## NMSU CORBETT CENTER STUDENT UNION 1600 INTERNATIONAL MALL LAS CRUCES, NM 88003

75% CONSTRUCTION DOCUMENTS JUNE 21, 2018

#### **OWNER:**

**NEW MEXICO STATE UNIVERSITY** NMSU FACILITIES & SERVICES 1530 WELLS ST LAS CRUCES, NM 88003 **CONTACT: ORASA VAUGHT** 



#### **CONSULTANTS:**

MECHANICAL, ELECTRICAL

**RAXIS ENGINEERING** 3800 N. MESA EL PASO, TX. 79902



#### ARCHITECT:

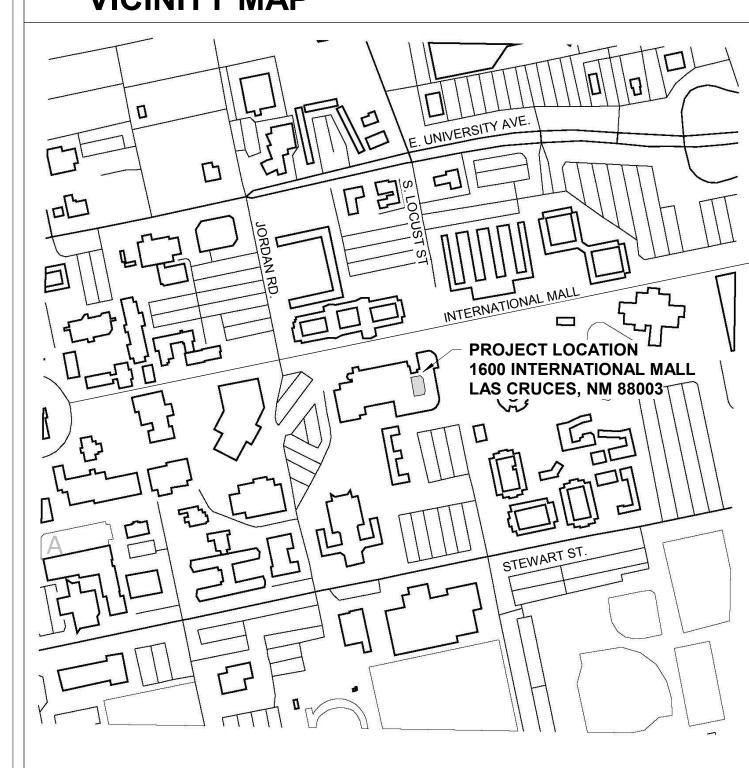
**WDG ARCHITECTS** WILLIAMS DESIGN GROUP, INC

1014 SOUTH MAIN STREET LAS CRUCES, NM 88005

P. (575) 528 - 0022 F. (575) 528 - 0023 **CONTACT: DAVID CLARKE** 



#### **VICINITY MAP**





#### **DESIGN CODES**

2015 INTERNATIONAL BUILDING CODE 2015 INTERNATIONAL EXISTING BUILDING CODE 2015 NM COMMERCIAL CODES

2012 NM PLUMBING CODE

2012 UNIFORM MECHANICAL CODE 2012 NM MECHANICAL CODE

2014 NATIONAL ELECTRICAL CODE

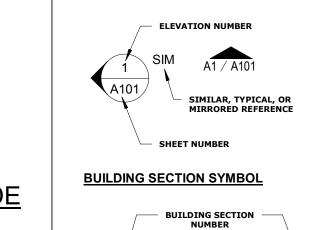
**2003 INTERNATIONAL FIRE CODE** 

2014 NM ELECTRICAL CODE 2009 INTERNATIONAL ENERGY CONSERVATION CODE

#### MATERIAL LEGEND

# PROJECTION (PLAN / ELEVATION) CUT (SECTION)

#### **SYMBOL LEGEND**





**ELEVATION SYMBOLS** 

# WALL SECTION SYMBOL

## **WINDOW/ DOOR TAG SYMBOLS**

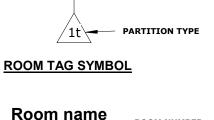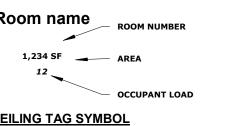
### **WALL TAG SYMBOL**






## **CEILING TAG SYMBOL HEIGHT INDICATION (ABOVE**

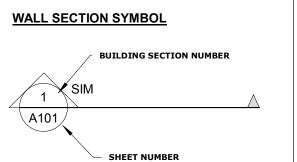REFERENCE KEYNOTE SYMBOL



## **DETAIL SYMBOL**

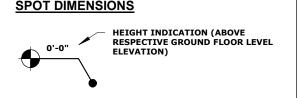	MIRRORED REFERENCE
	SHEET NUMBER
1	DETAIL
A101	SHEET NUMBER



#### DRAWING INDEX

**COVER G-SHEETS** CODE REVIEW DATA / EXITING PLAN ACCESSIBLE DETAILS, WALL TYPES, DOOR TYPES, IRRIGATION PLAN **OUTLINE SPECIFICATIONS** 

FIRST FLOOR PLAN **EQUIPMENT PLAN & EQUIPMENT SCHEDULE** 

**OUTLINE SPECIFICATIONS** 

**ENLARGED FLOOR PLAN & DETAILS** FIRST FLOOR REFLECTED CEILING PLAN

**EXTERIOR ELEVATIONS BUILDING SECTIONS & DETAILS** 

**SEWER & VENT PLUMBING PLAN** PLUMBING DETAILS

**ELECTRICAL GENERAL NOTES** LIGHTING PLAN POWER PLAN ELECTRICAL DETAILS

#### SCOPE OF WORK

BRING POWER FROM THE EXISTING ELECTRICAL ROOM WITHIN TAOS DINING AREA TO A NEW EXTERIOR MOUNTED SUB PANEL AT LOCATION SPECIFIED ON DRAWINGS. PROVIDE AND INSTALL ALL SHUNTS AND CONNECTIONS TO THE FIRE ALARM SYSTEM AS REQUIRED BY NMSU FIRE.

\*NOTE: PHASE I WILL BE COMPLETED ON A SEPARATE PERMIT PRIOR TO THE BEGINNING OF THE SCOTE OF WORK LISTED FOR THIS PROJECT AS PART OF THE SAME CONSTRUCTION CONTRACT.

#### PHASE II - EXTERIOR COURTYARD BAR

UTILIZE THE EXISTING COVERED CANOPY - RECONFIGURED TO FUNCTION AS A FULL SERVICE BAR AND

- REVERSE DOORS AT BOTH EXITS TO THE COURTYARD TO ALLOW THE DOORS TO FLOW IN THE DIRECTION OF EGRESS AS SHOWN ON DRAWINGS.
- REMOVE EXIT SIGNS INSIDE THE CORRIDOR SHOWING EGRESS TO EXIT TO THE COURTYARD. INSTALL NEW EXIT SIGNS OUTSIDE, SHOWING THE CORRECT EXIT FROM THE COURTY AND INTO
- THE CORRIDOR AND OUT THROUGH THE EXISTING EXIT DOORS PROVIDE AND INSTALL ALL DOOR HARDWARE AS SPECIFIED - EXIT DOORS WILL REQUIRE A
- CUT BACK EIFS AND PROVIDE AND INSTALL NEW LIGHT GAGE METAL FRAMED CANOPY WITH

PASSAGE ONLY - NOT AN EGRESS DOOR.

- BE PLACED AND INSTALL NEW 4" SLAB ON GRADE AS INDICATED ON THE DRAWINGS FOR THE BAR AREA, TABLES, AND THE FIRE PIT. PROVIDE AND INSTALL FLOOR DRAINS AND FLOOR SINKS AS INDICATED ON THE DRAWINGS IN THESE AREAS. SELECTIVE DEMOLITION TO OPEN HOLLOW COLUMNS TO CREATE NICHES FOR TV'S AND
- SHELVING AS SHOWN ON THE DRAWINGS. THIS WILL REQUIRE A RE-ROUTING OF THE EXISTING DRAIN PIPES WITHIN THE CHASE. NEW FINISH COAT (COLOR AS SELECTED BY THE ARCHITECT) ON ALL EXPOSED EIFS BELOW THE
- CANOPY TO CHANGE TO A CONTRASTING COLOR. DAFS OVER CEMENT BOARD AT LOCATIONS AS SPECIFIED ON THE DRAWINGS. PROVIDE AND INSTALL "FROSTED FILM" ON THE OUTSIDE OF THE EXISTING WINDOWS UNDER THE CANOPY TO 4'-0" AFF TO MASK THE VIEW OF THE BACK OF THE EQUIPMENT FROM THE
- INSIDE OF THE EXISTING DINING AREA. CREATE A NEW OPENING FROM THE EXISTING KITCHEN TO THE DINING AREA TO FUNCTION AS A SERVER PASS THROUGH AT THE AREA INDICATED ON THE DRAWINGS. THIS WILL INCLUDE THE EXCLUSION OF THE EXISTING CLOSET AND SLIGHT MODIFICATIONS TO THE EXISTING AREA.
- NEW BURNISHED MASONRY WALLS TO PARTIALLY ENCLOSE THE EXISTING CANOPY UNDER THE MECHANICAL CHASE. PROVIDE AND INSTALL THREE (3) NEW OVERHEAD COILING SECURITY GRILLS AT EACH OF THE
- NEW BURNISHED MASONRY WALLS TO FUNCTION AS TABLE BASES AS SHOWN ON DRAWINGS.
- NEW CONCRETE COUNTERTOPS AT BAR FRONT, SIDES, AND BUILT-IN TABLES. PROVIDE ALL ELECTRICAL AND PLUMBING INFRASTRUCTURE (CONNECTED TO EXISTING INFRASTRUCTURE) WITHIN THE BAR AREA TO ALLOW A FULLY FUNCTIONING FULL SERVICE BAR.
- INSTALL ALL OWNER PROVIDED EQUIPMENT AS LISTED IN THE EQUIPMENT SCHEDULE. PROVIDE ALL ELECTRICAL AND DATA INFRASTRUCTURE NEEDED FOR THE OWNER PROVIDED FELEVISIONS AND INSTALL OWNER PROVIDED TELEVISIONS IN THE LOCATIONS SPECIFIED ON
- PROVIDE AND INSTALL NEW LIGHTING AS SHOWN ON THE DRAWINGS REPLACE THE EXISTING LIGHT FIXTURES UNDER SOFFIT WITH THE REPLACEMENT FIXTURES
- STRIP ALL PAINT OFF OR THE EXISTING LIGHT POLES AND REPLACE GLOBES WITH NEW EQUAL. PROVIDE FIRE PIT SPECIFIED AND GAS AND ELECTRICAL INFRASTRUCTURE NEEDED (INCLUDING SHUNTS AND EMERGENCY SHUT-OFF BUTTON FOR A FULLY FUNCTIONING FIRE PIT AT THE LOCATION SPECIFIED ON THE DRAWINGS (MUST MEET ALL SAFETY REQUIREMENTS OF NMSU
- CONNECT TO EXISTING IRRIGATION INFRASTRUCTURE AND RUN NEW IRRIGATION LINES
  - HROUGHOUT THE PLANTER UNDER THE STAIRS. ADD NEW SOIL TO THE PLANTER UNDER STAIRS TO PREPARE AREA FOR OWNER PROVIDED HERB/VEGETABLE GARDEN.
- PROVIDE AND INSTALL METAL LETTER SIGNAGE AS SHOWN ON DRAWINGS PROVIDE ELECTRICAL INFRASTRUCTURE FOR ELECTRIC BUILDING SIGN ABOVE CANOPY.



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PROJECT NO. 206-98

SHEET TITLE

**COVER SHEET** 



PLUMBING REQUIREMENTS: (IBC 2015 CHAPTER 29: TABLE 2902.1) **ASSEMBLY A-2:** TOTAL OCCUPANT LOAD (203) = REQUIRED PROVIDED (PUBLIC FACILITIES) W.C. LAV. W.C. LAV. WOMEN 16 6 DRINKING FOUNTAINS REQUIRED PROVIDED (PUBLIC D.F.) OCCUPANTS 203 SERVICE SINK REQUIRED PROVIDED (SHARED FACILITY)

**CODE REVIEW** 

PROJECT TYPE: RENOVATION

CLASSIFICATION OF WORK: ALTERATION - LEVEL 2 Per IBC 2015 - 304.1

OCCUPANCY CLASSIFICATION: A-2 (TAVERNS AND BARS)

EXISTING CONSTRUCTION TYPE : IB NET FLOOR AREA: 4,292 SF

NO CHANGE IN AREA

ASSEMBLY A-2 (UNCONCENTRATED TABLES AND CHAIRS) - 15 NSF/OCCUPANT KITCHENS, COMMERCIAL - 200 GSF/OCCUPANT TOTAL OCCUPANT LOAD (NEW WORK)

ASSEMBLY A-2 (UNCONCENTRATED TABLES AND CHAIRS):201 KITCHENS, COMMERCIAL: 2

TOTAL OCCUPANT LOAD (NEW WORK): 203 OCCUPANTS

-REQUIRED EXIT WIDTH (644 X .2) **128.8 INCHES** 

EXIT TRAVEL DISTANCE REQUIREMENTS - Per IBC 2015 1017.2

OCCUPANCY CLASSIFICATION A (NONSPRINKLERED) :200'-0" MAX DISTANCE

TO NOT LESS THAN ONE-HALF OF THE LENGHT OF THE MAXIMUM OVERALL

EXIT ACCESS DOORWAY DISTANCE: 62'-9"

STAIRWAY WIDTH REQUIREMENTS - Per IBC 2015 1009.3

NOT APPLICABLE

**MEANS OF EGRESS** - Per IEBC 2015 704 & 805.2

704.1 "ALTERATIONS SHALL BE DONE IN A MANNER THAT MAINTAINS THE LEVEL OF PROTECTION PROVIDED FOR THE MEANS OF

ACCESSIBLE MEANS OF EGRESS - Per IBC 2015 1009.1

EXCEPTION 1: "ACCESSIBLE MEANS OF EGRESS ARE NOT REQUIRED TO

SEPARATION REQUIREMENTS - (IBC 2015)

Per IBC 2015 TABLE 508.4

NO SEPARATION REQUIREMENT BETWEEN A-OCCUPANCY AND A-OCCUPANCY

AUTOMATIC SPRINKLER SYSTEMS ARE NOT REQUIRED DUE TO EXCEPTION 2 (THE

**BUILDING AREA MODIFICATIONS** 

Per IBC 2015 506.3.3 - Equation 5-5

OCCUPANT LOAD FACTOR - Per IBC 2015 1004.1.2

TOTAL OCCUPANT LOAD: 203

**EXIT WIDTH REQUIREMENTS** - Per IBC 2015 1005.3.2

TOTAL OCCUPANT LOAD (EXISTING) SHARING PATH OF TRAVEL W/ NEW WORK: 441 OCCUPANTS

TOTAL PROJECT OCCUPANT LOAD: 644 OCCUPANTS

-ACTUAL EXIT DOOR WIDTH 204 INCHES

**EXIT CORRDOR WIDTH REQUIREMENTS** - Per IBC 2015 1020.2

"ANY FACILITY NOT LISTED"

REQUIRED: 44" CLEAR WIDTH PROVIDED: 102" MIN. CLEAR WIDT

EXIT AND EXIT ACCESS - Per IBC 2015 1007.1.1

EXIT ACCESS DOORWAYS...SHALL BE PLACED A DISTANCE APART EQUAL DIAGONAL DIMENSION OF THE BUILDING OR AREA TO BE SERVED.

DIAGONAL DIMENSION OF SPACE: 88'-6"

EGRESS."

805.2 "MEANS OF EGRESS CONFORMING TO THE REQUIRMENTS OF THE BUILDING CODE UNDER WHICH THE BUILDING WAS CONSTRUCTED SHALL BE CONSIDERED COMPLIANT IF, IN THE OPINION OF THE CODE OFFICIAL, THEY DO NOT CONSTITUTE A DISTINCT HAZARD TO LIFE"

NOTE: ALL ALTERATIONS MAINTAIN THE LEVEL OF PROTECTION PROVIDED FOR THE MEANS OF EGRESS. ALTERATIONS DO NOT AFFECT THE CONFIGURATION OF AREAS UTLIZED AS REFUGE AREAS.

BE PROVIDED IN EXISTING BUILDINGS.

FIRE PROTECTION - Per IEBC 2015 804.2.2

WORK AREA DOES NOT EXCEED 50 PERCENT OF THE FLOOR AREA.

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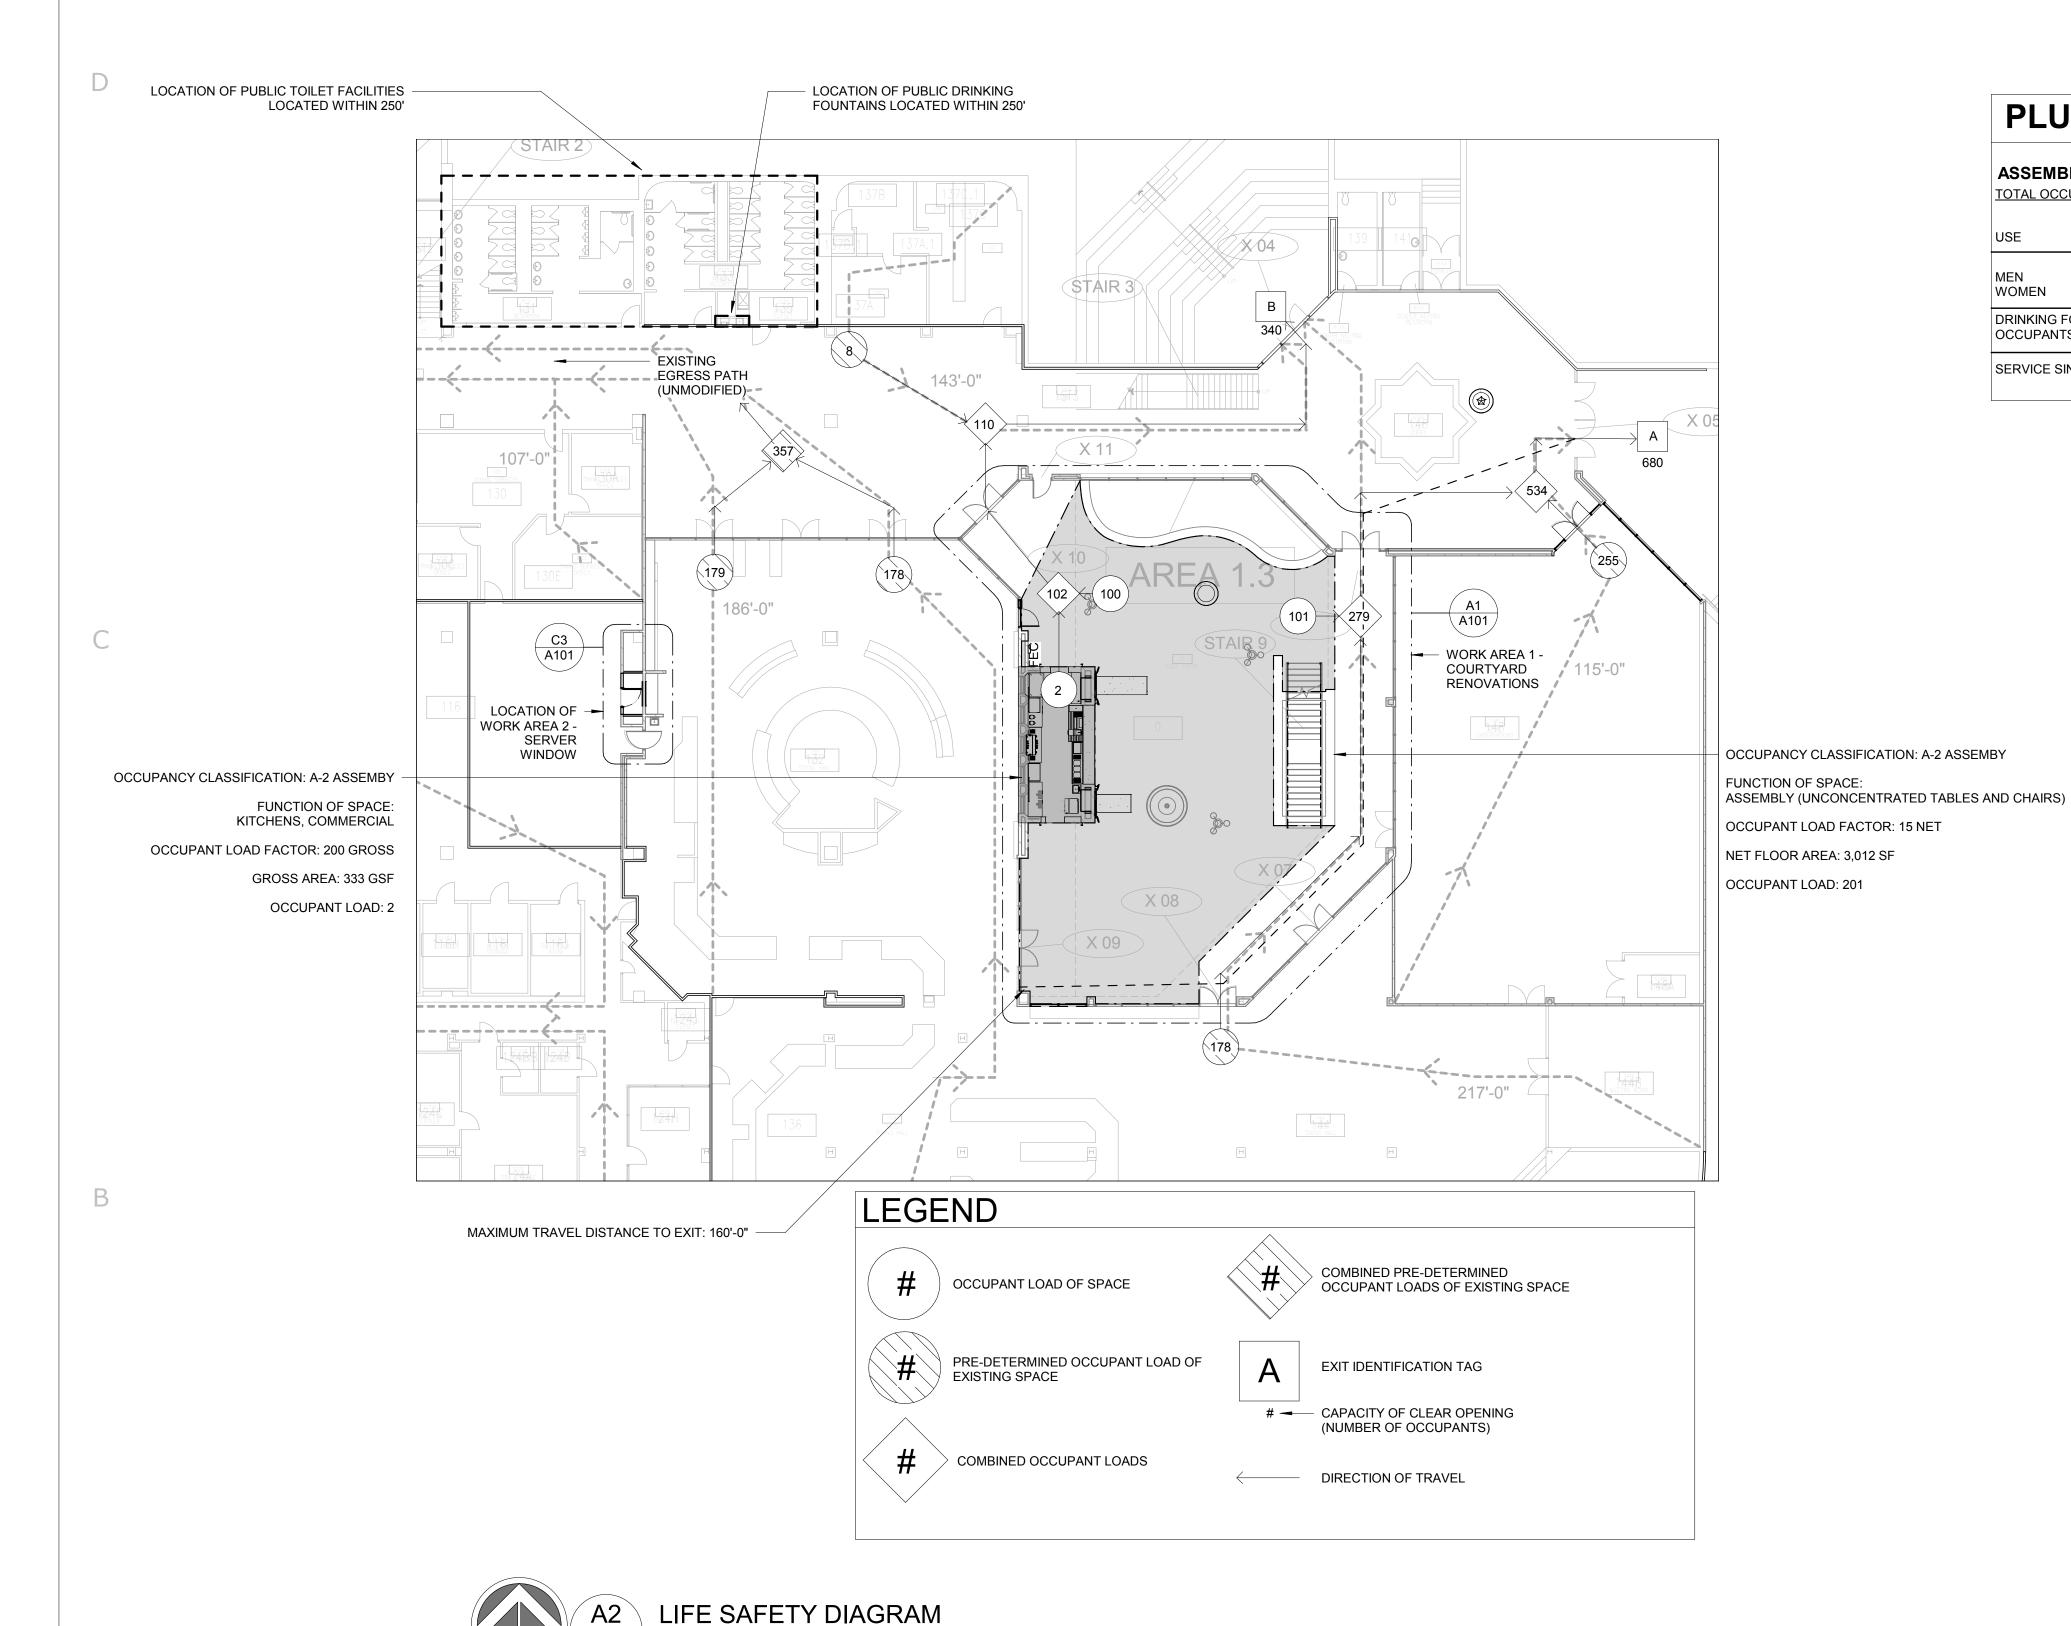
PROJECT NO. 206-98

SHEET TITLE

CORBE


CODE REVIEW DATA / EXITING PLAN

SHEET NO.



**PROJECT** 

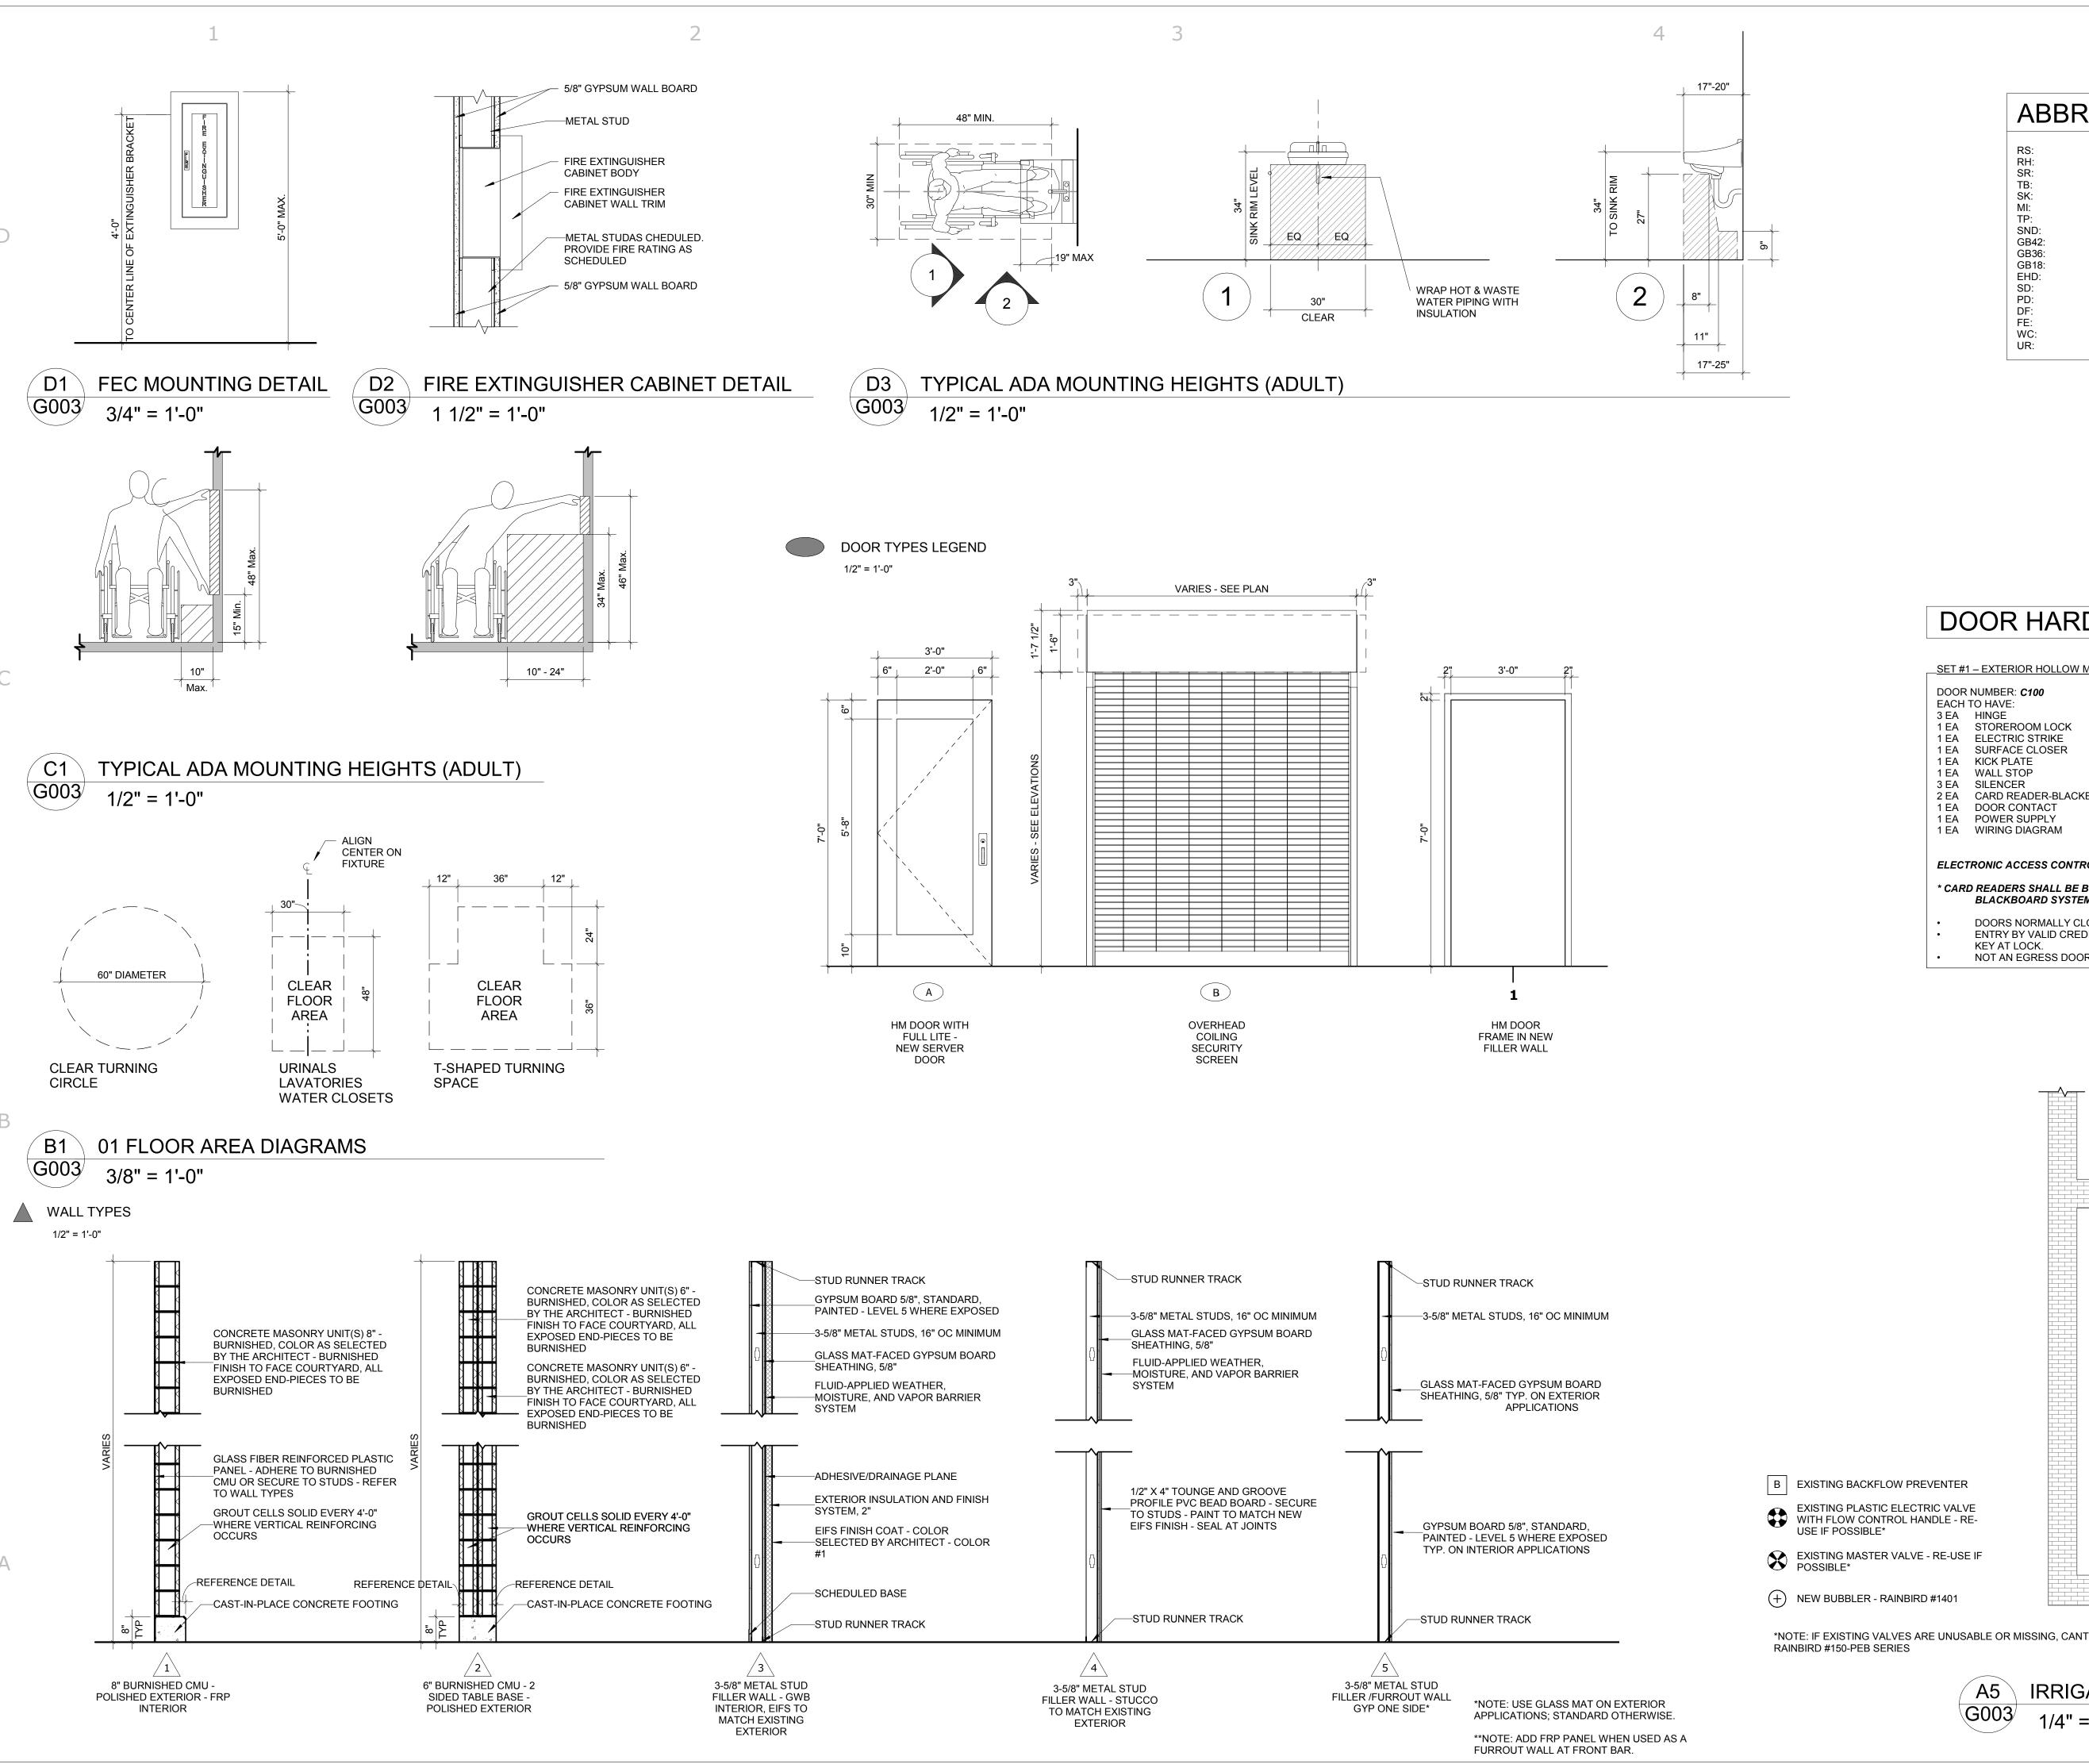NORTH



ABBREVIATION LEGEND

ROOM SIGNAGE ROBE HOOK SHOWER CURTAIN ROD **MIRROR TOILET PAPER DISPENSER** SANITARY NAPKIN DISPOSAL GRAB BAR- 42" LONG GRAB BAR- 36" LONG VERTICAL GRAB BAR - 18" LONG ELECTRIC HAND DRYER SOAP DISPENSER PAPER TOWEL DISPENSER DRINKING FOUNTAIN FIRE EXTINGUISHER WATER CLOSET

COURTYARD BAR

CORBETT

**DOOR HARDWARE** 

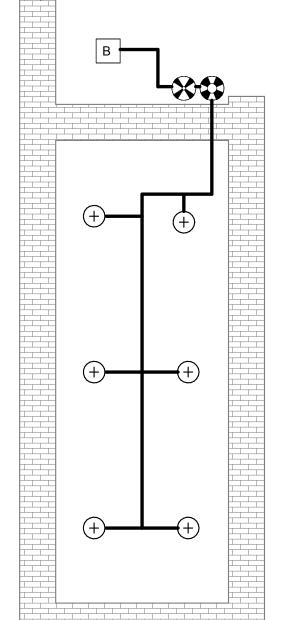
652 626 YAL TRINE 4111 EDA TB 8400 10" X 2" LDW 630 IVE 2 EA CARD READER-BLACKBOARD DR4200 BLK BLK BB LGR BB POINT TO POINT / RISER

**ELECTRONIC ACCESS CONTROL – CARD READER** 


#### \* CARD READERS SHALL BE BLACKBOARD, CONNECTED TO THE EXISTING BLACKBOARD SYSTEM - REFER TO ELECTRICAL

ENTRY BY VALID CREDENTIAL AT CARD READER BOTH SIDES OR BY

NOT AN EGRESS DOOR - SECURED ACCESS ONLY FOR SERVERS.



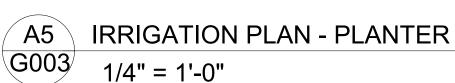\*NOTE: IF EXISTING VALVES ARE UNUSABLE OR MISSING, CANTRACTOR SHALL INSTALL NEW VALVES -





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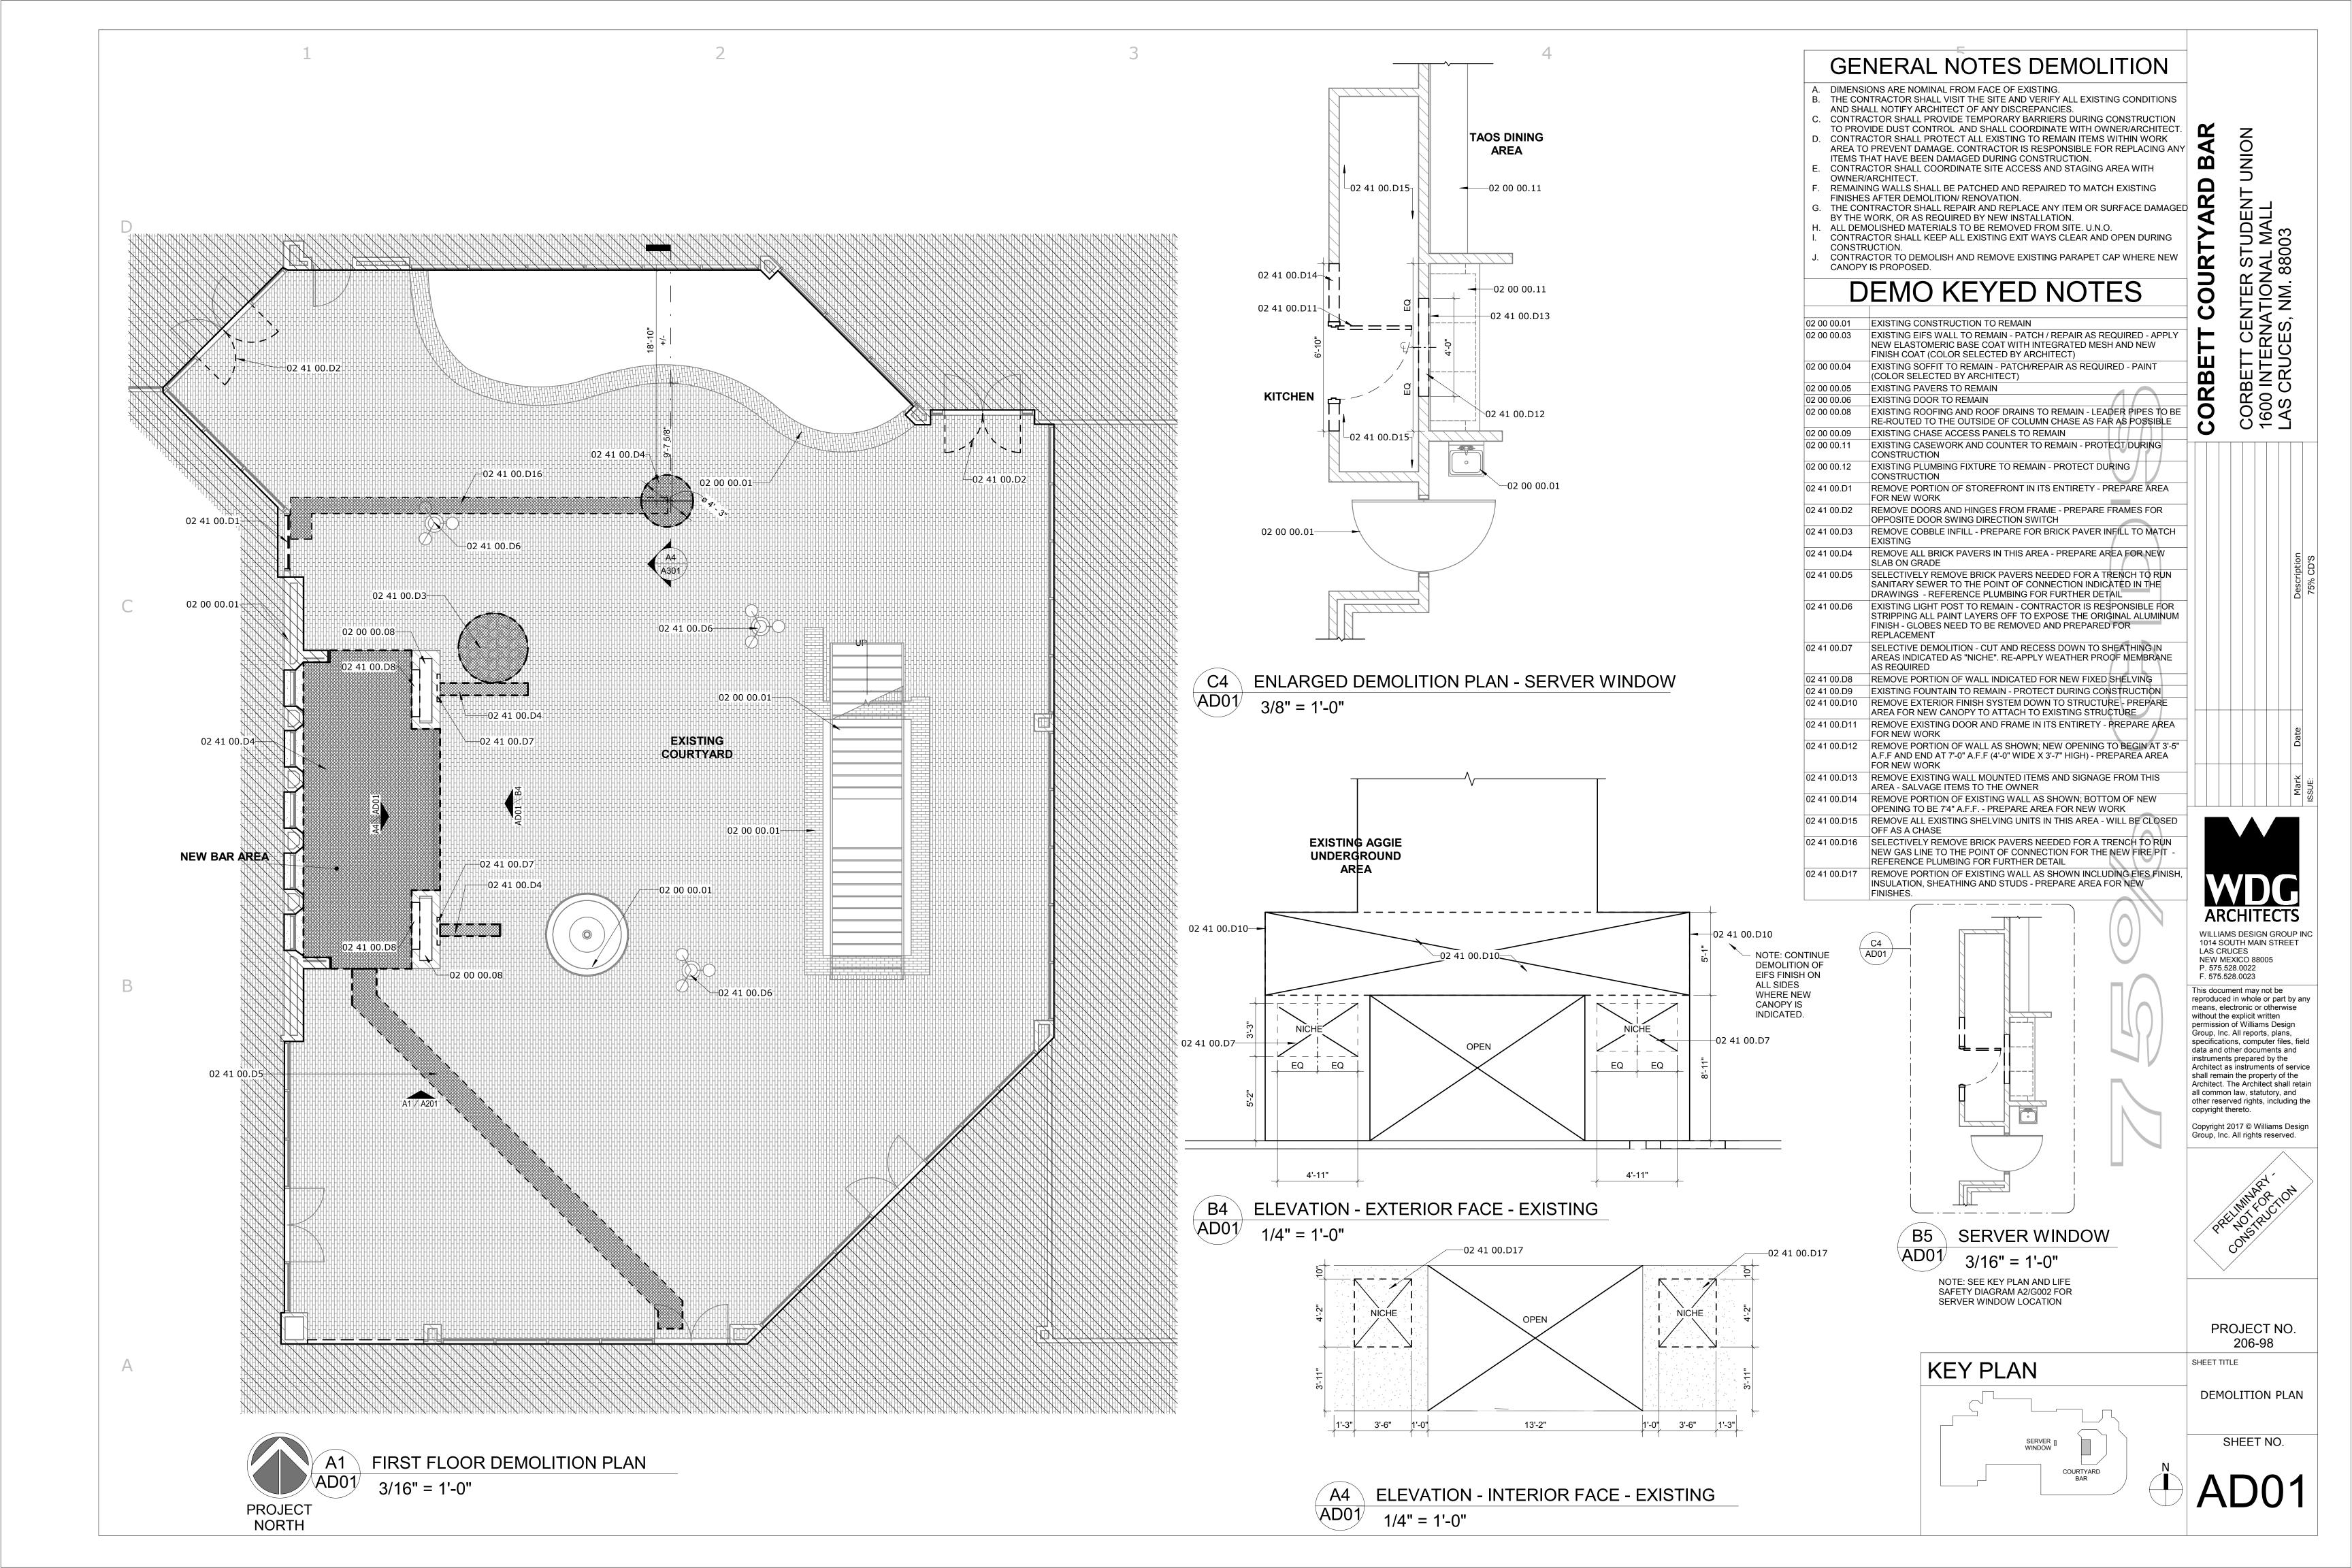
Architect as instruments of service shall remain the property of the


Architect. The Architect shall retain all common law, statutory, and other reserved rights, including the


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**ACCESSIBLE** DETAILS, WALL TYPES, DOOR TYPES, IRRIGATION PLAN





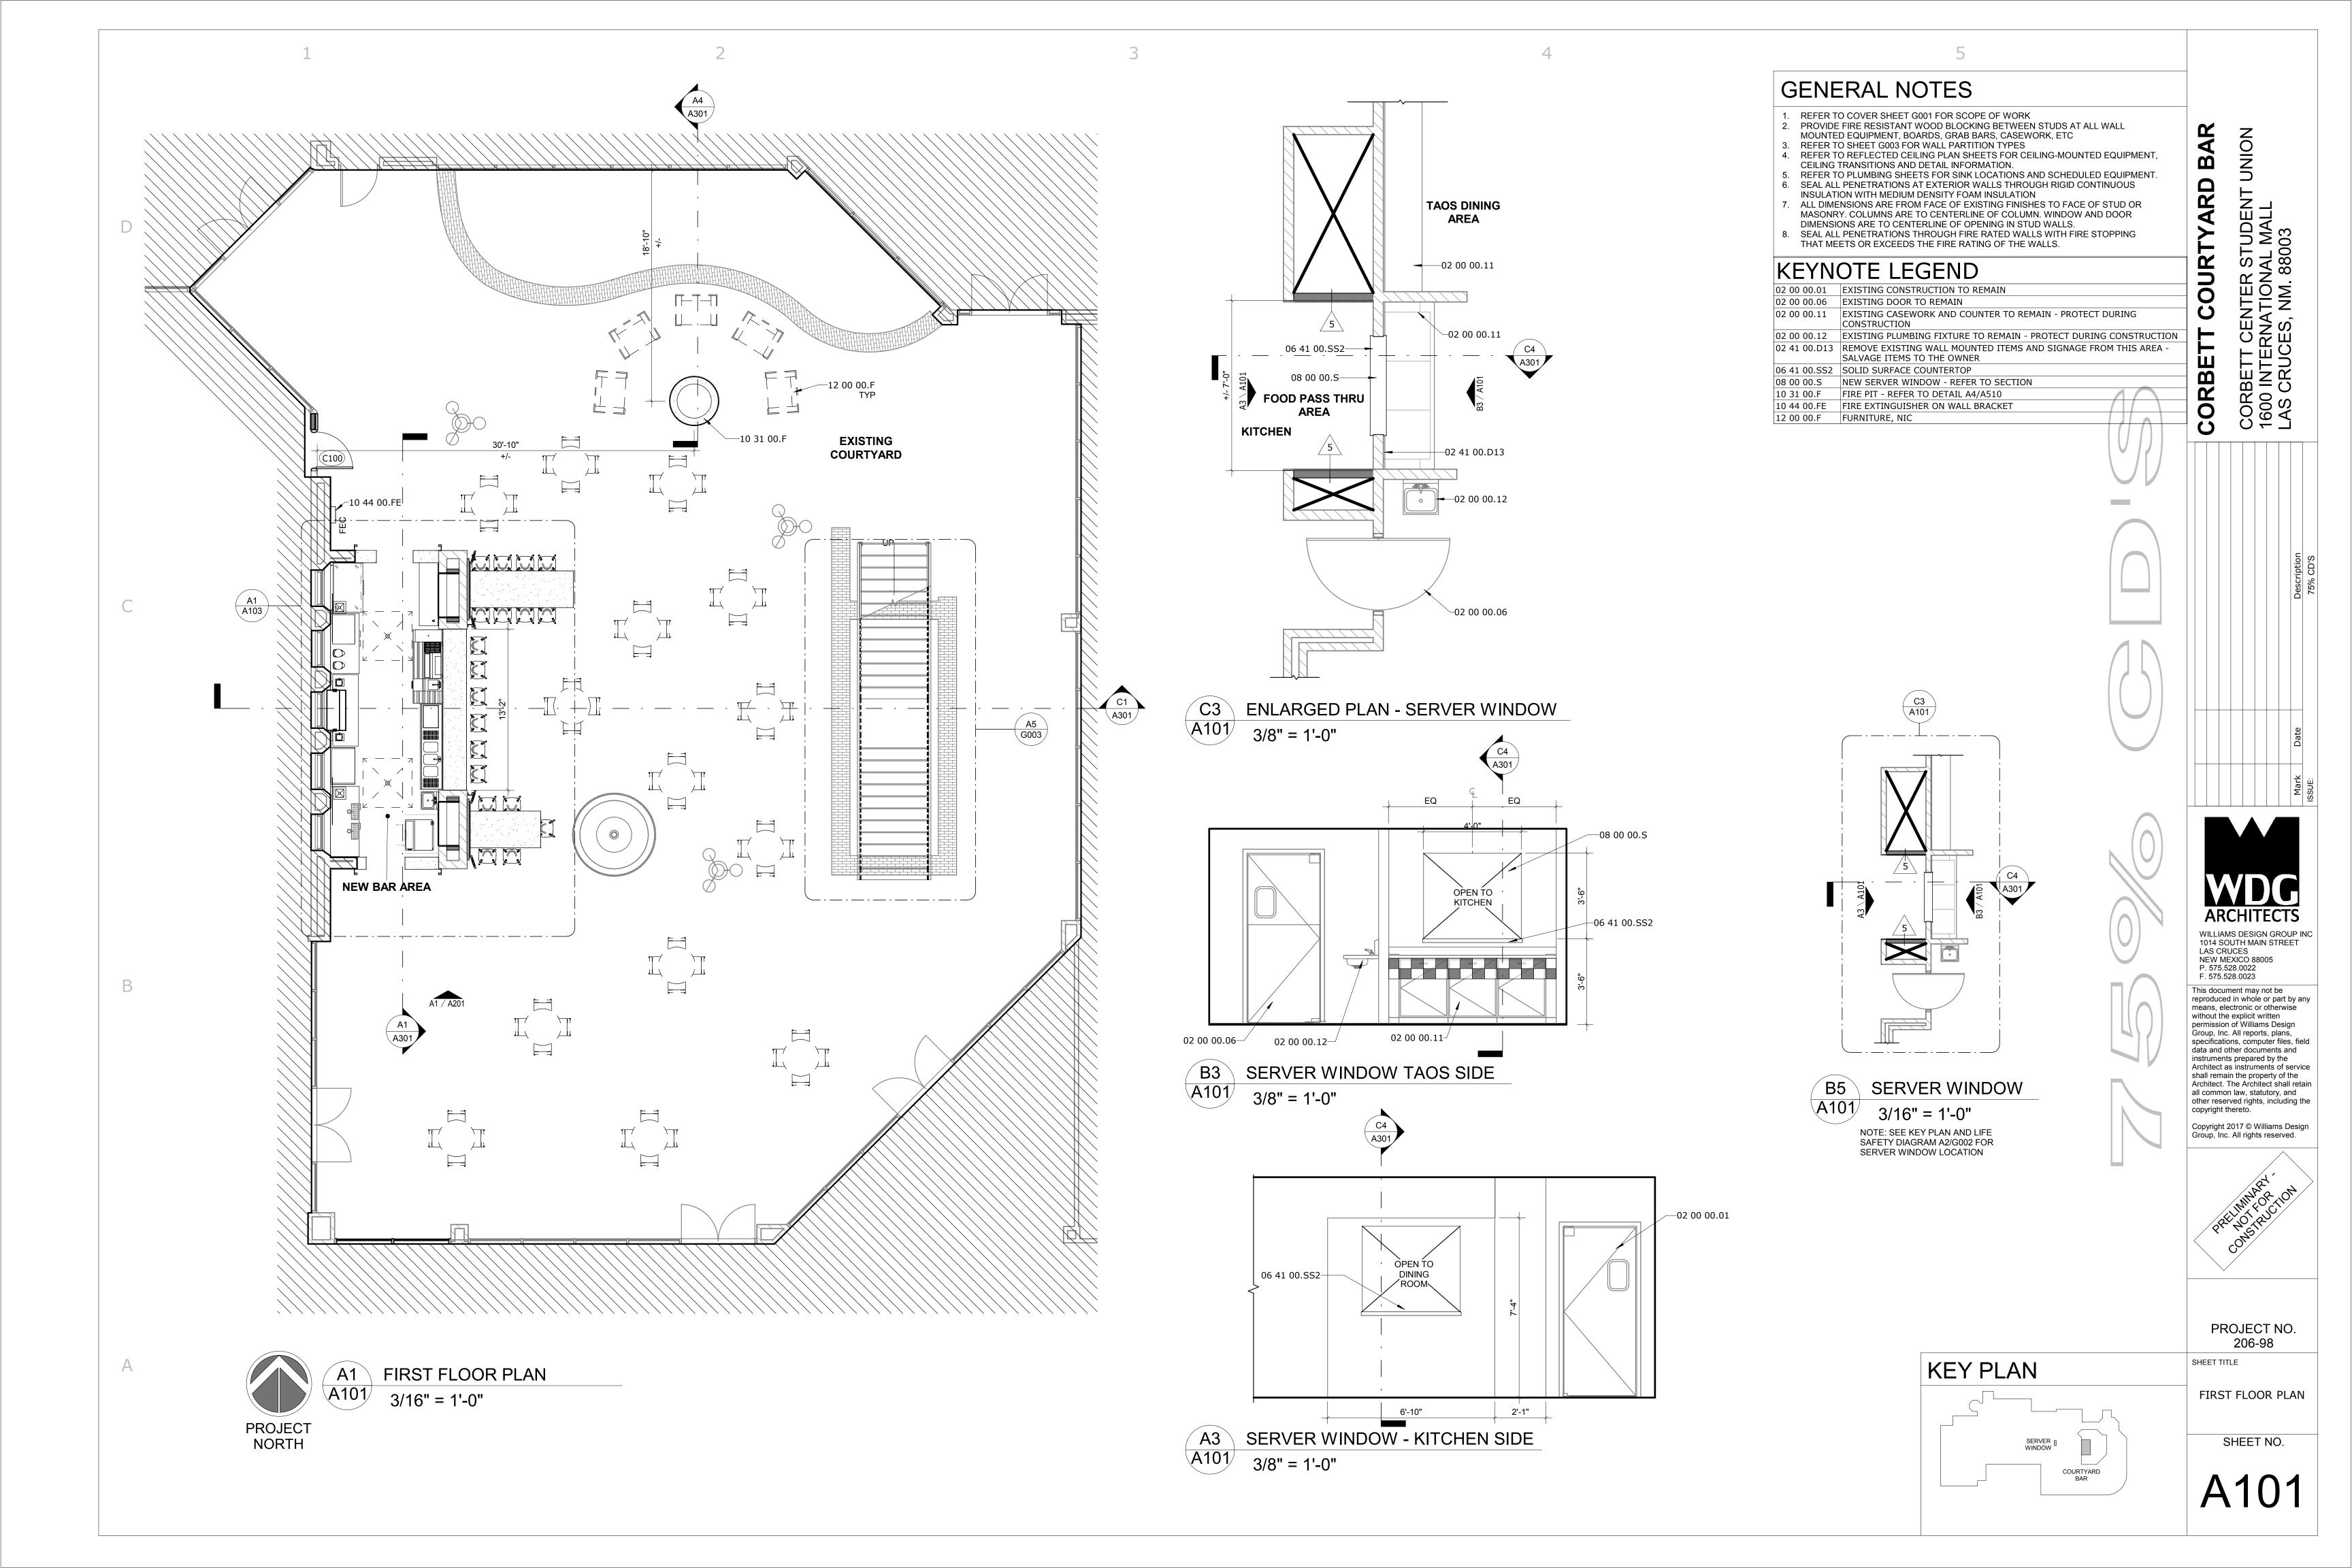

KEYNOTE LEGEND

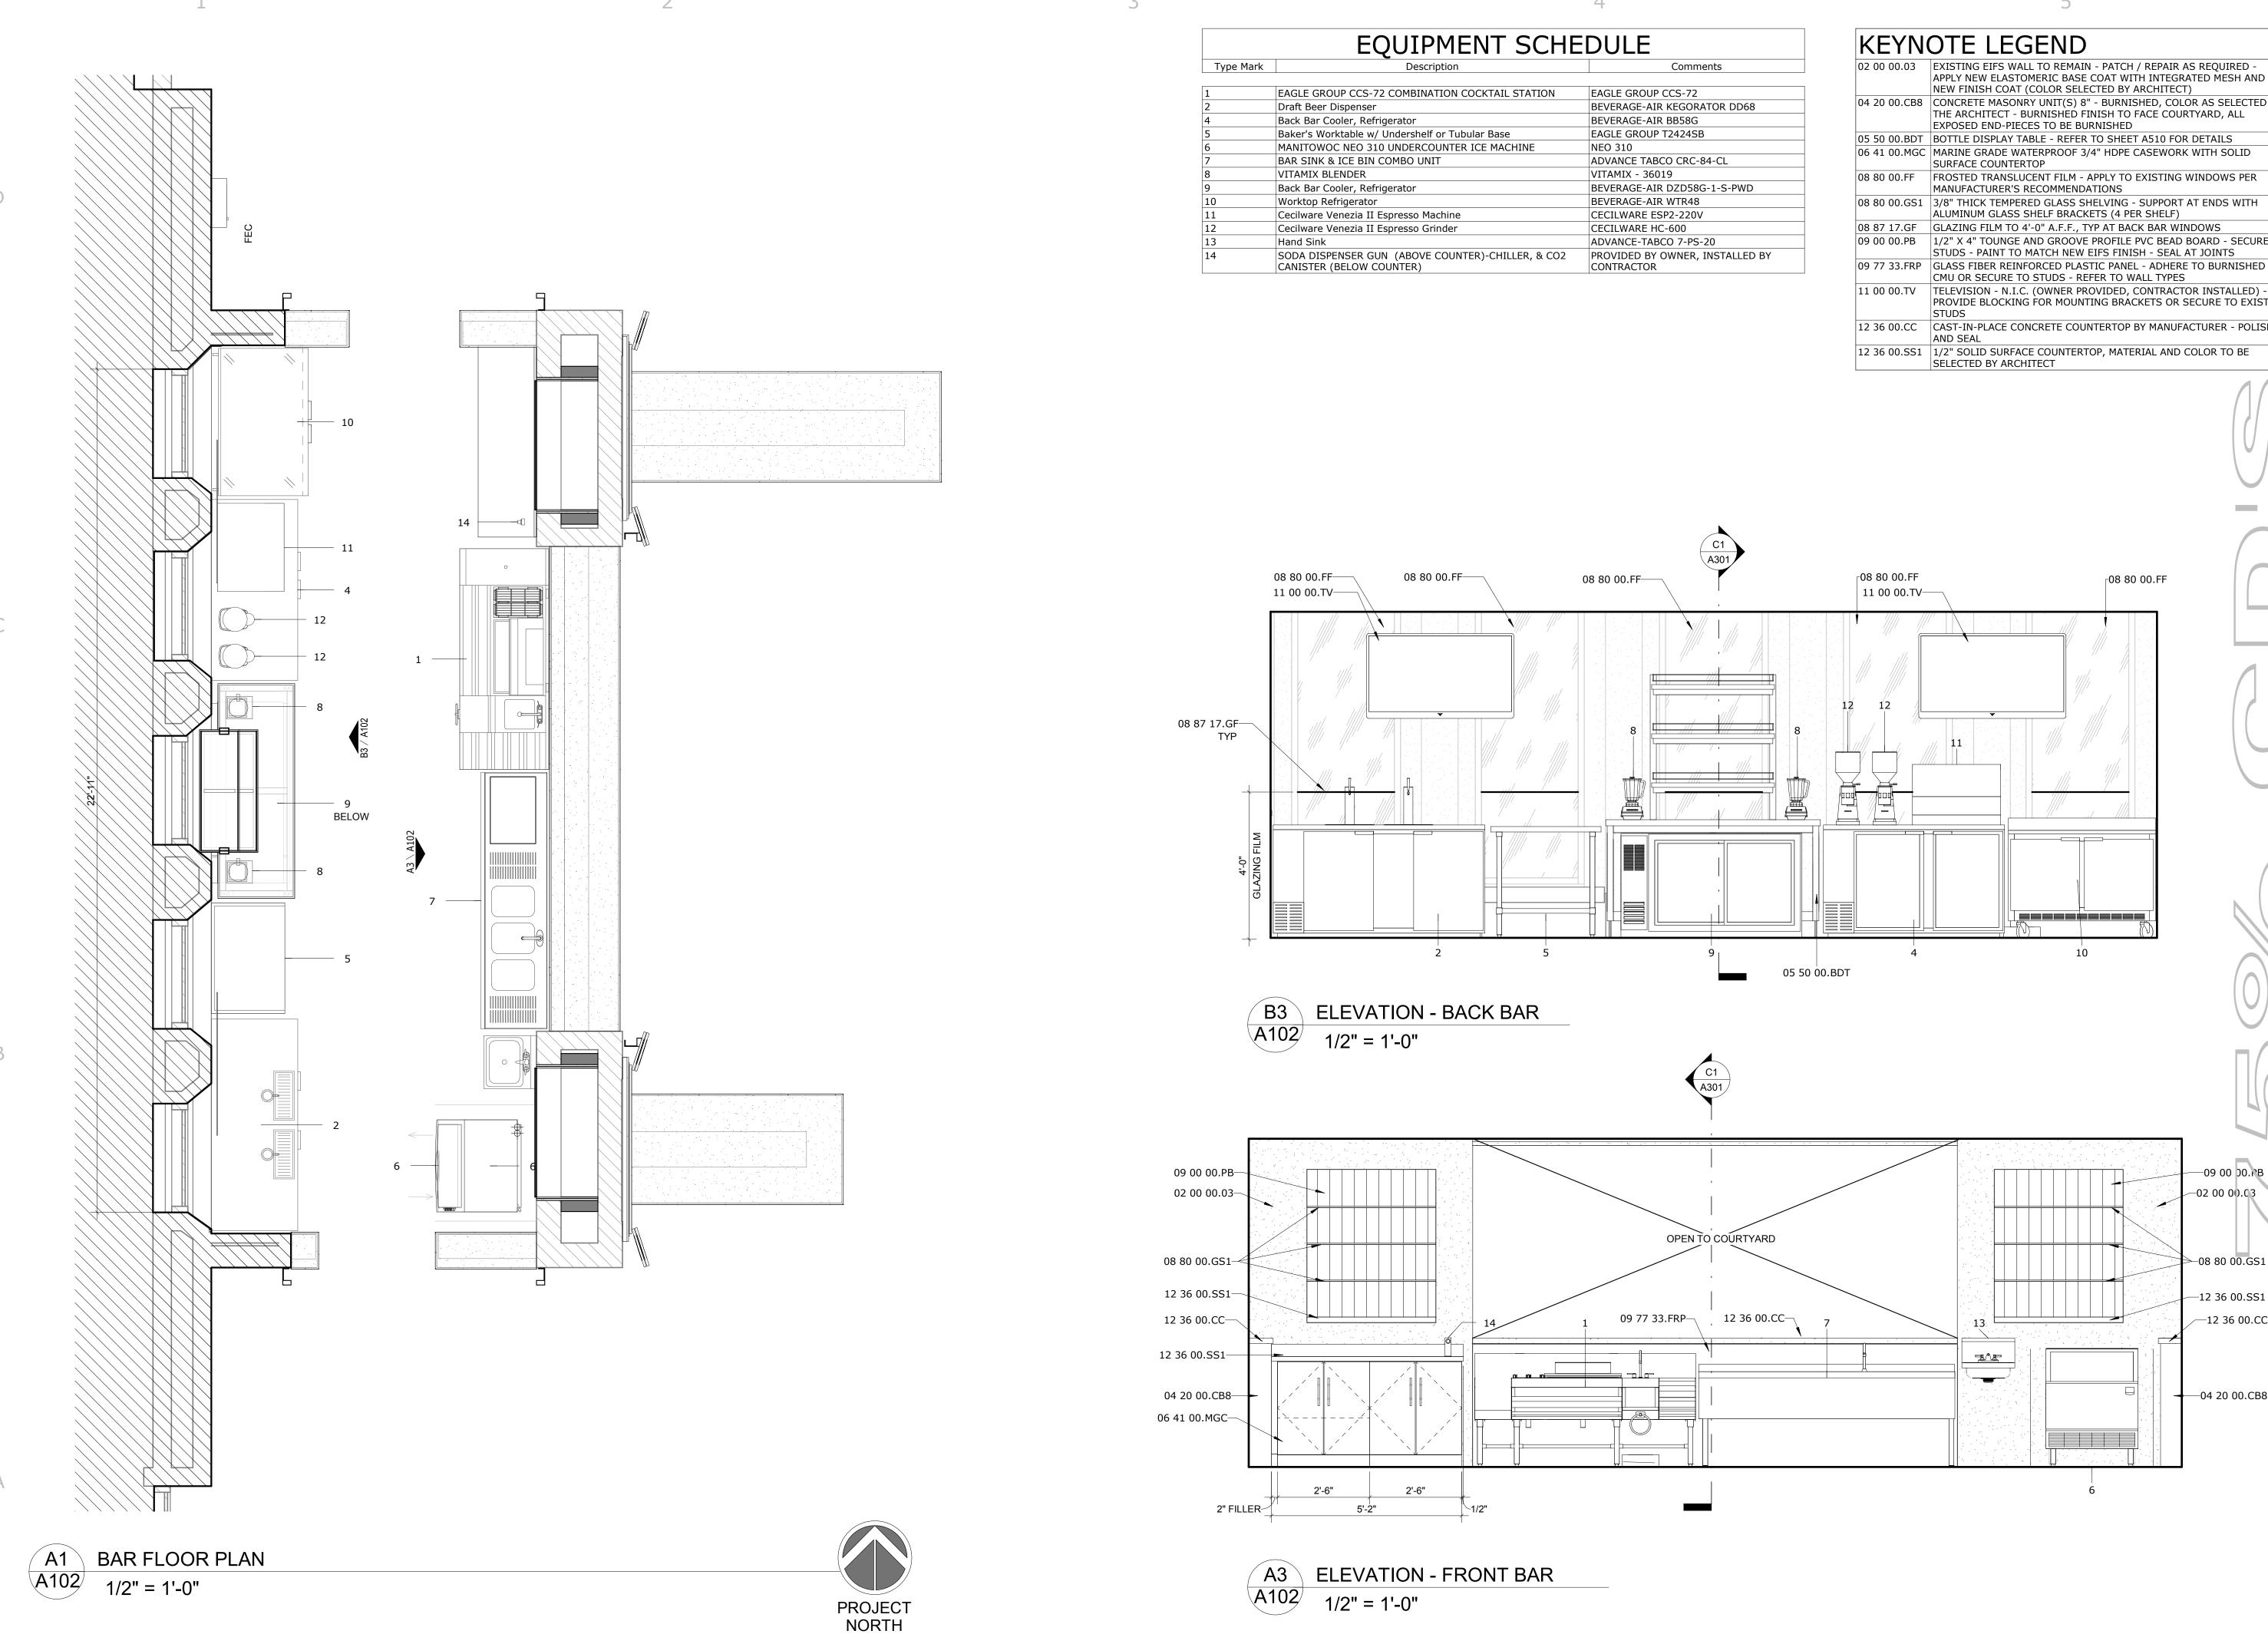02 00 00.03 EXISTING EIFS WALL TO REMAIN - PATCH / REPAIR AS REQUIRED -APPLY NEW ELASTOMERIC BASE COAT WITH INTEGRATED MESH AND NEW FINISH COAT (COLOR SELECTED BY ARCHITECT) 04 20 00.CB8 | CONCRETE MASONRY UNIT(S) 8" - BURNISHED, COLOR AS SELECTED BY THE ARCHITECT - BURNISHED FINISH TO FACE COURTYARD, ALL

EXPOSED END-PIECES TO BE BURNISHED 05 50 00.BDT | BOTTLE DISPLAY TABLE - REFER TO SHEET A510 FOR DETAILS 06 41 00.MGC MARINE GRADE WATERPROOF 3/4" HDPE CASEWORK WITH SOLID SURFACE COUNTERTOP

08 80 00.FF FROSTED TRANSLUCENT FILM - APPLY TO EXISTING WINDOWS PER MANUFACTURER'S RECOMMENDATIONS 08 80 00.GS1 3/8" THICK TEMPERED GLASS SHELVING - SUPPORT AT ENDS WITH

08 87 17.GF GLAZING FILM TO 4'-0" A.F.F., TYP AT BACK BAR WINDOWS 09 00 00.PB | 1/2" X 4" TOUNGE AND GROOVE PROFILE PVC BEAD BOARD - SECURE TO STUDS - PAINT TO MATCH NEW EIFS FINISH - SEAL AT JOINTS 09 77 33.FRP GLASS FIBER REINFORCED PLASTIC PANEL - ADHERE TO BURNISHED CMU OR SECURE TO STUDS - REFER TO WALL TYPES

PROVIDE BLOCKING FOR MOUNTING BRACKETS OR SECURE TO EXISTING 12 36 00.CC CAST-IN-PLACE CONCRETE COUNTERTOP BY MANUFACTURER - POLISH

12 36 00.SS1 1/2" SOLID SURFACE COUNTERTOP, MATERIAL AND COLOR TO BE SELECTED BY ARCHITECT

<sub>-</sub>08 80 00.FF

BAR

**OURTYARD** 

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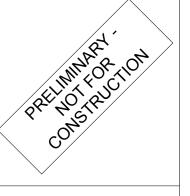
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-08 80 00.GS1

-12 36 00.SS1

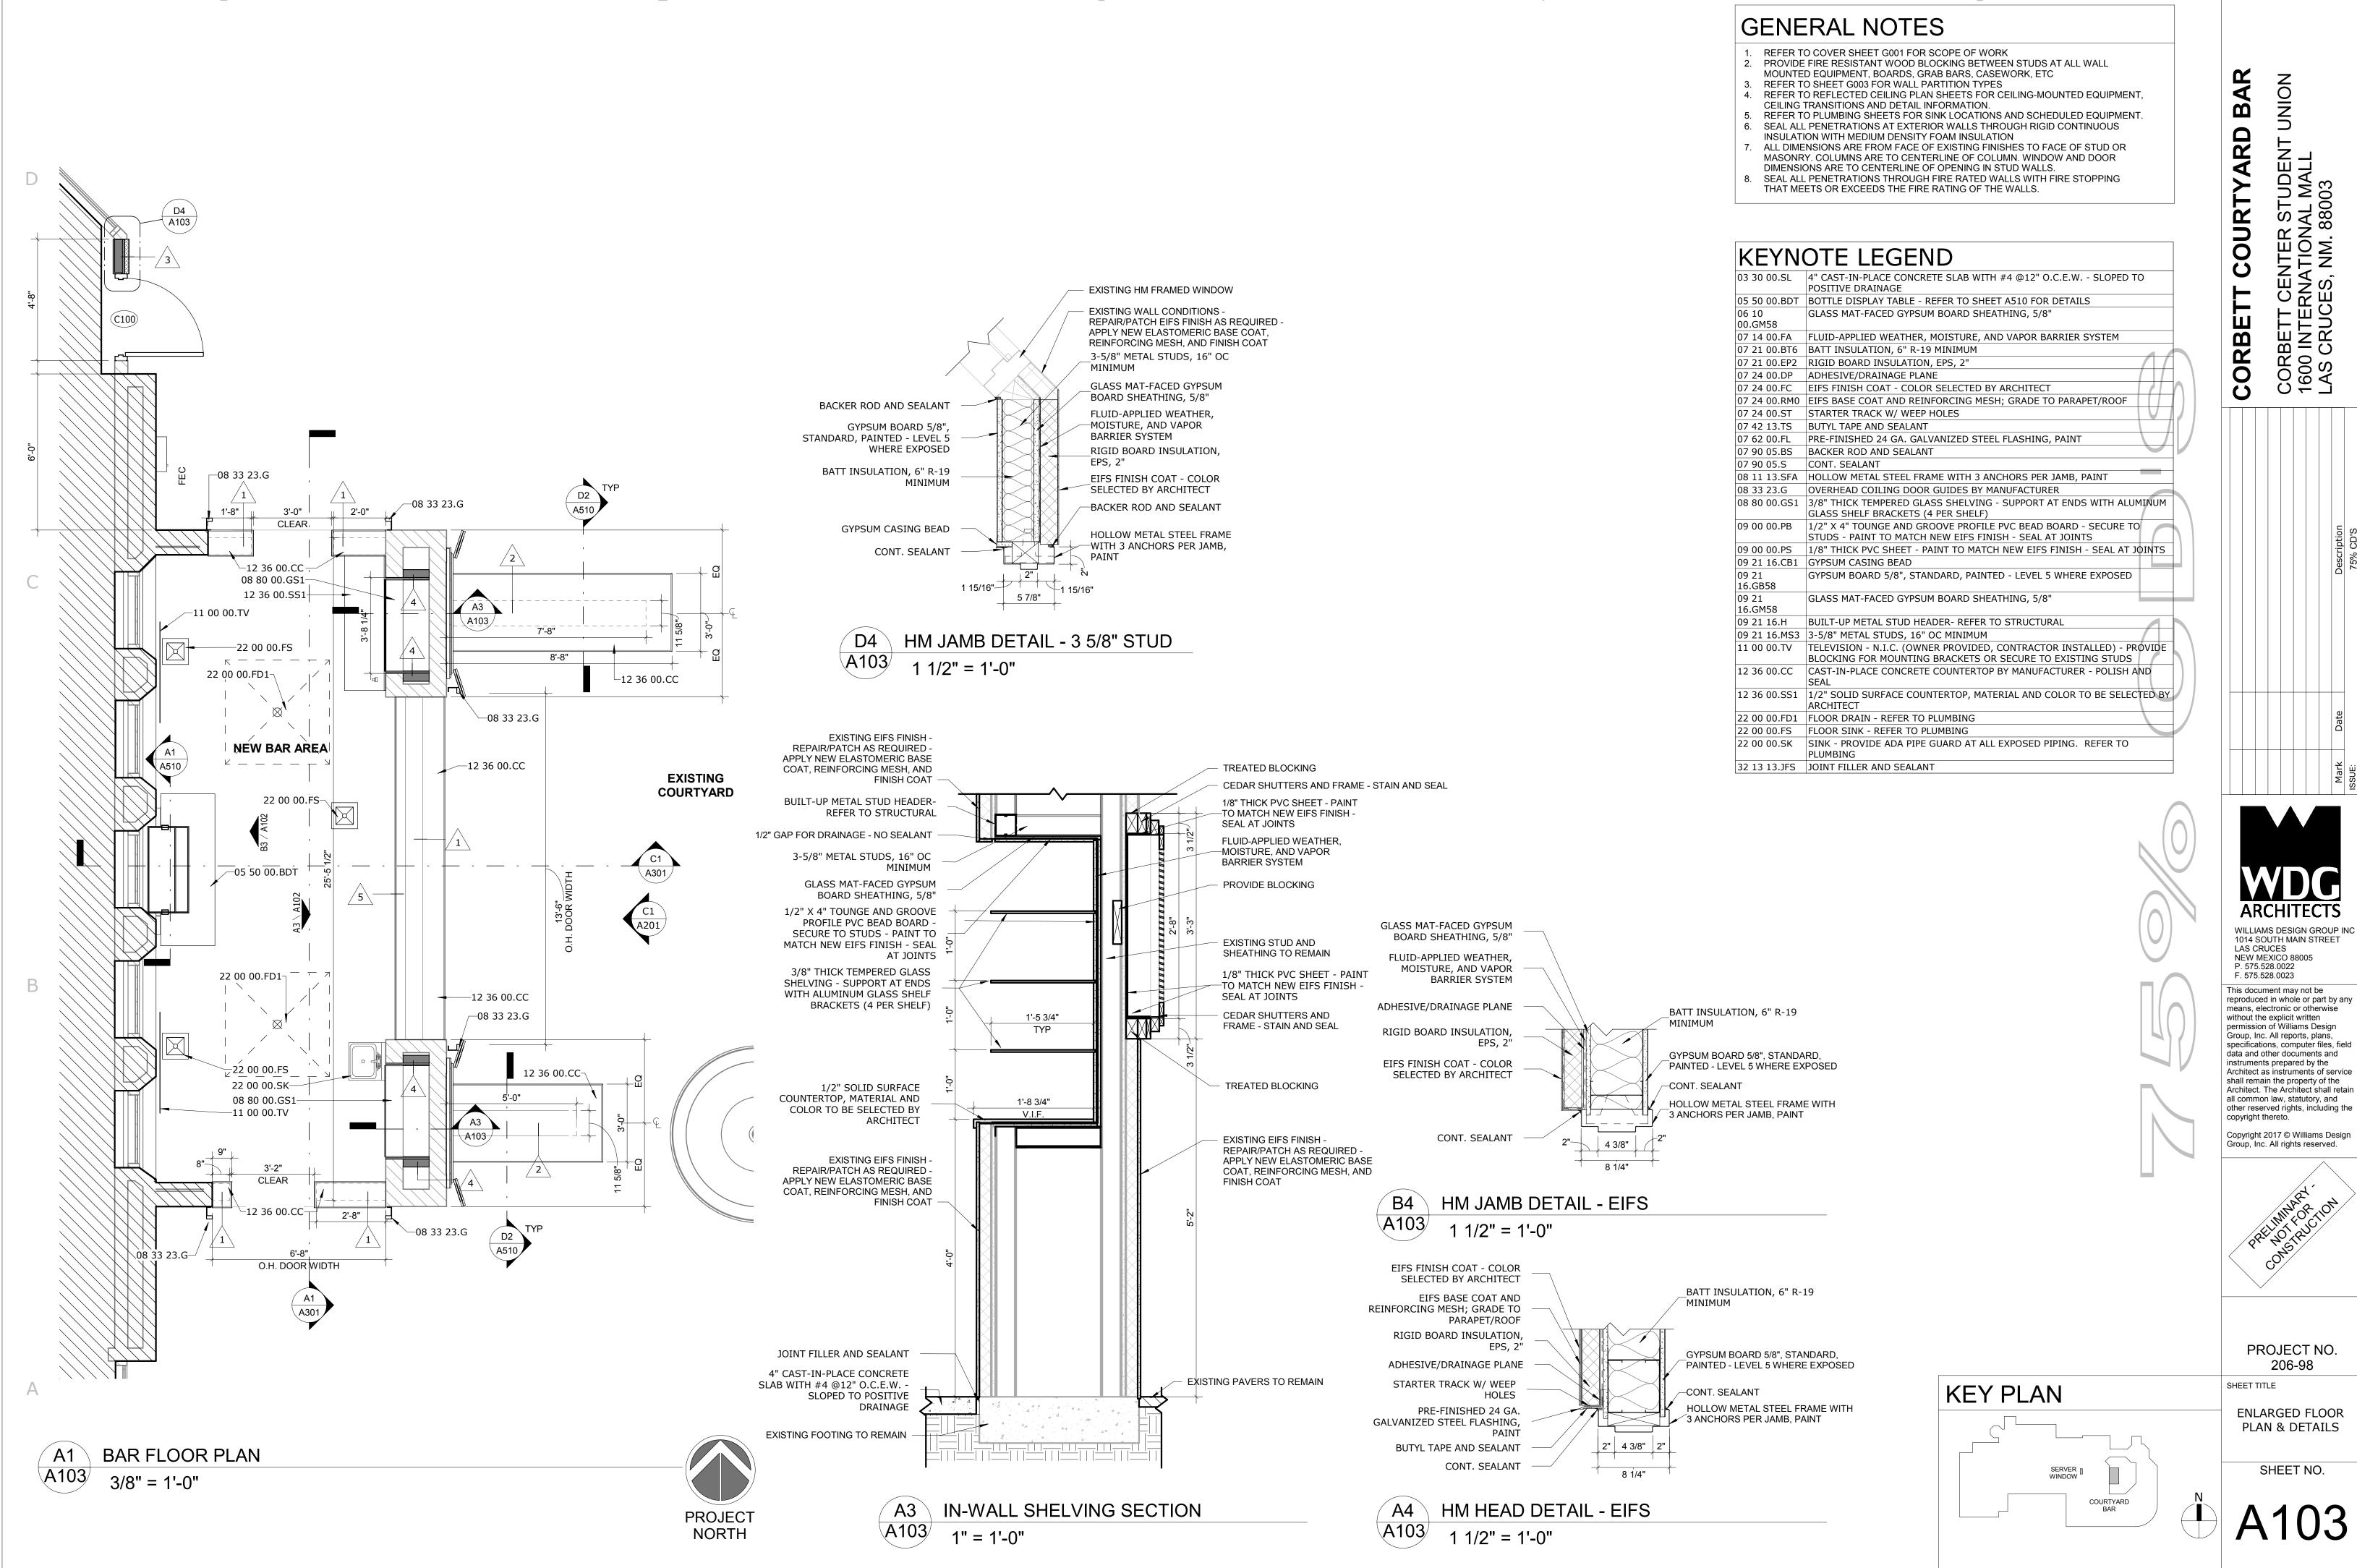
─12 36 00.CC

-04 20 00.CB8



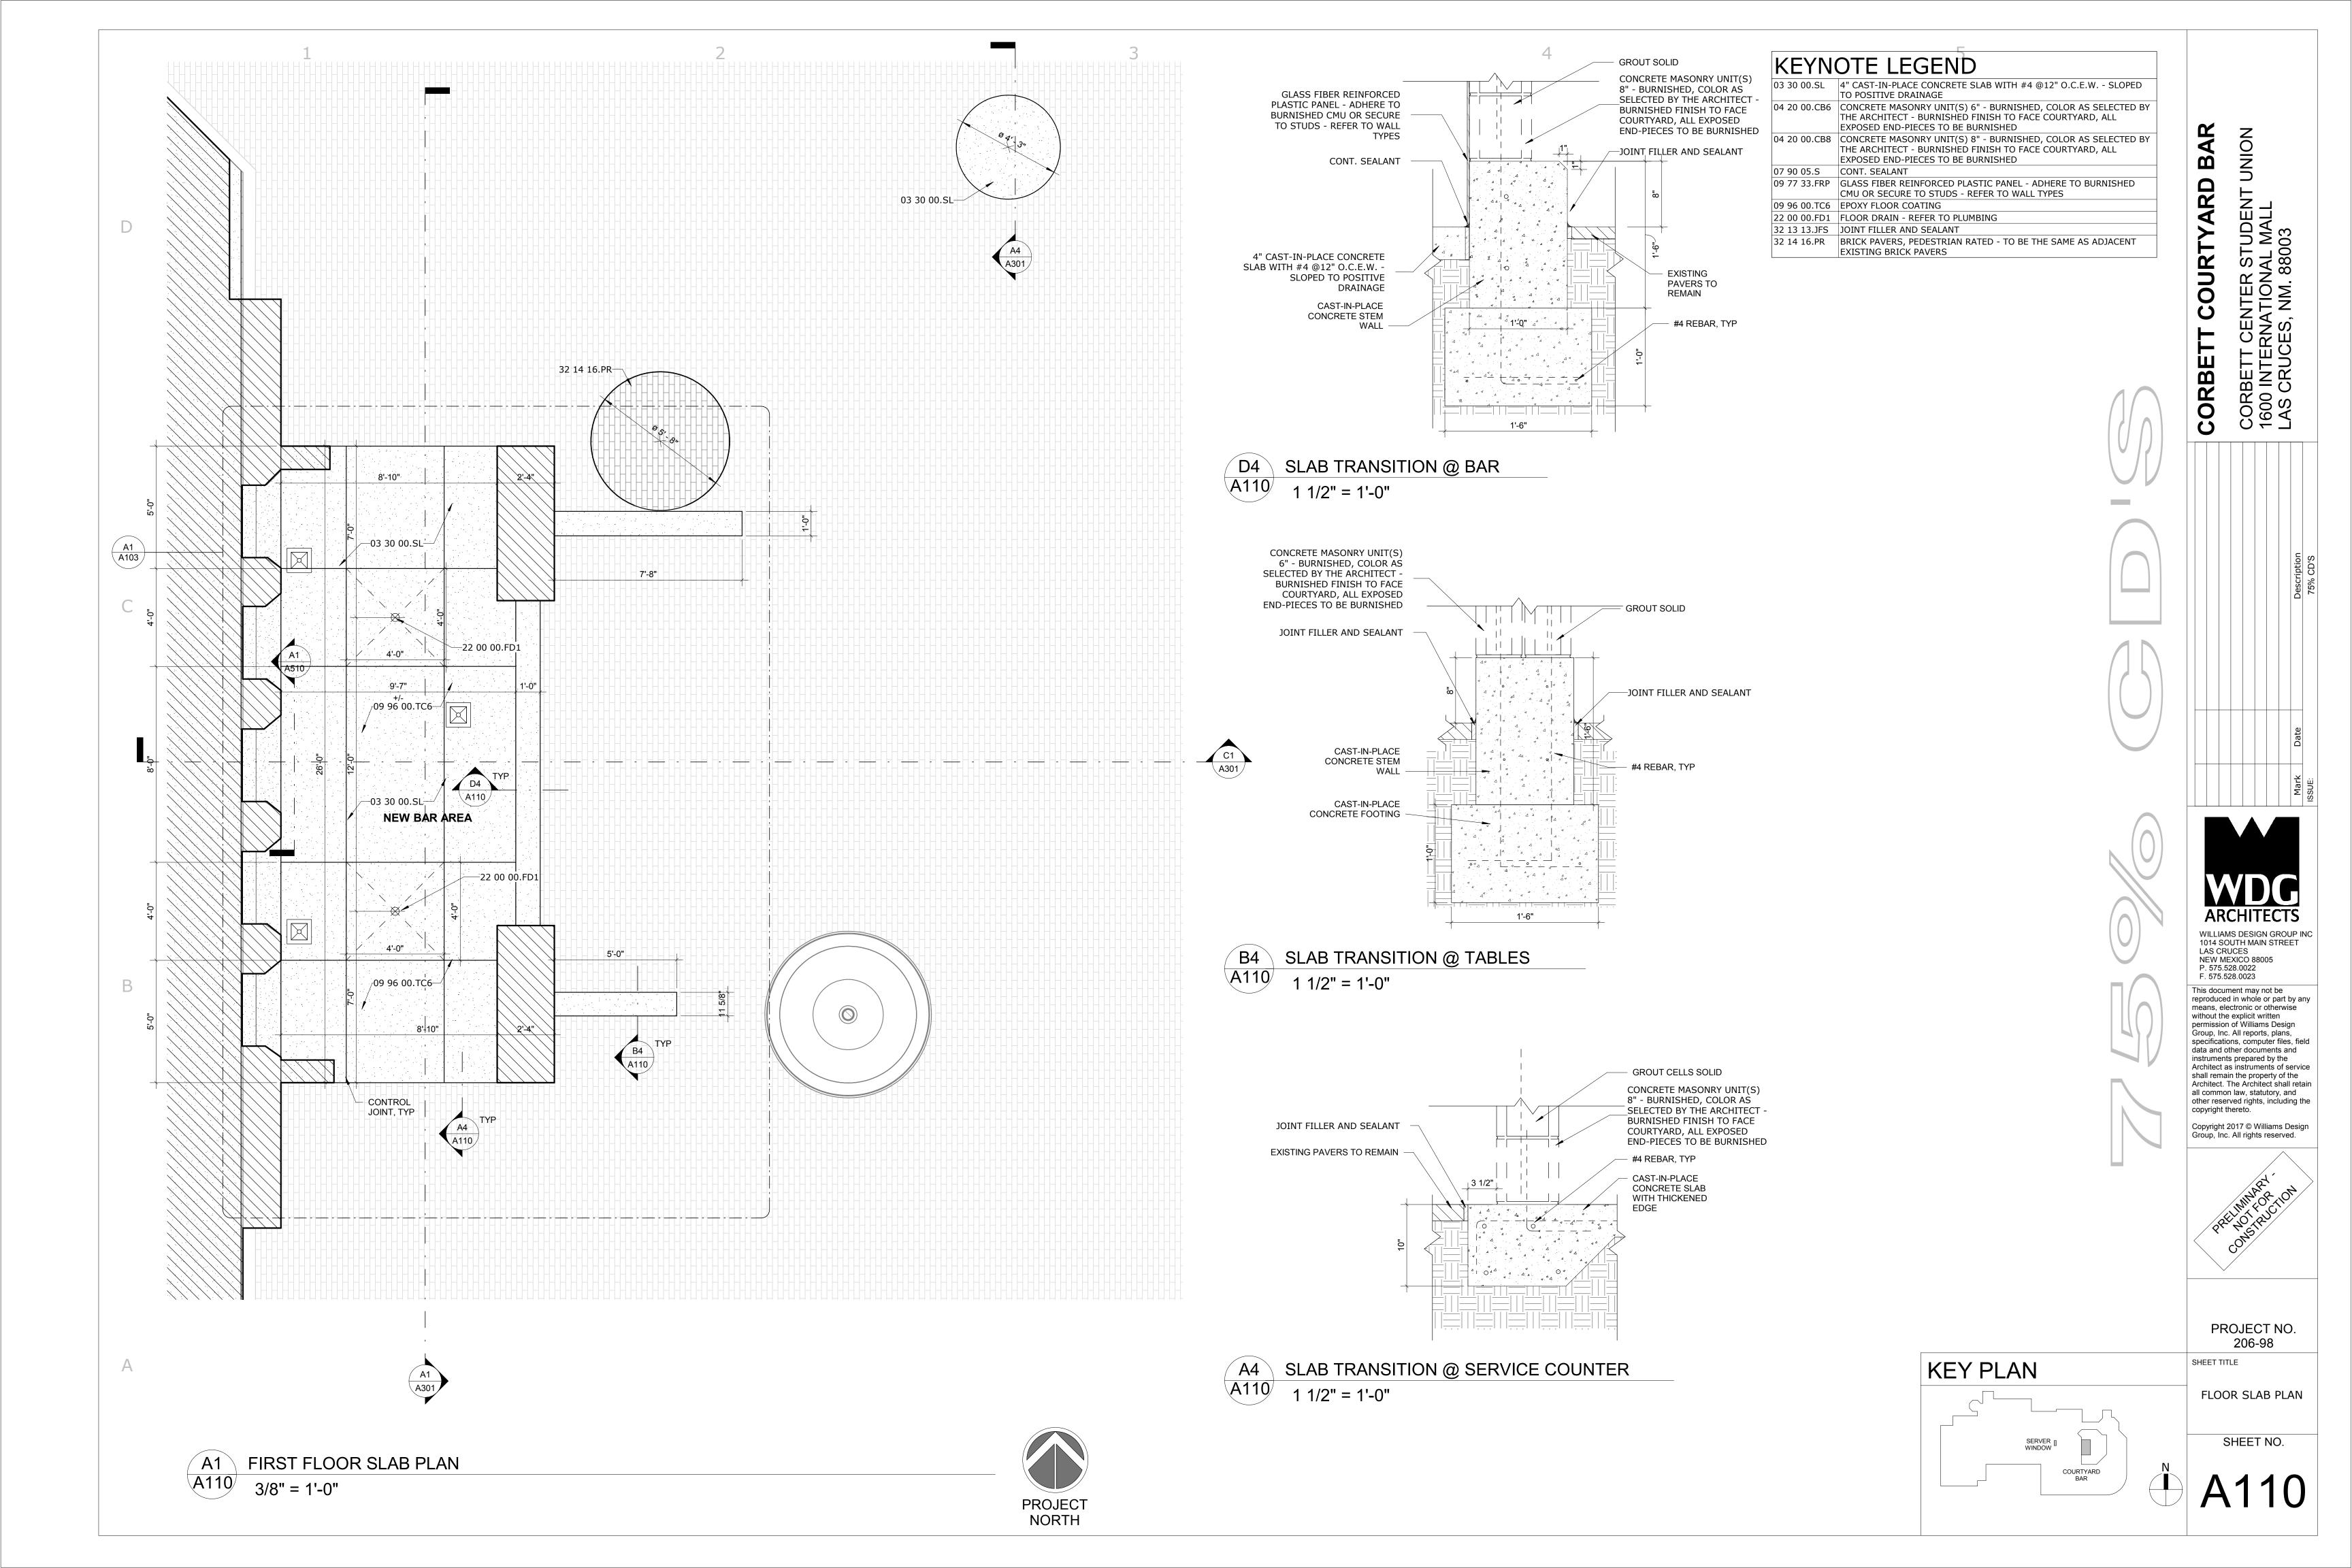
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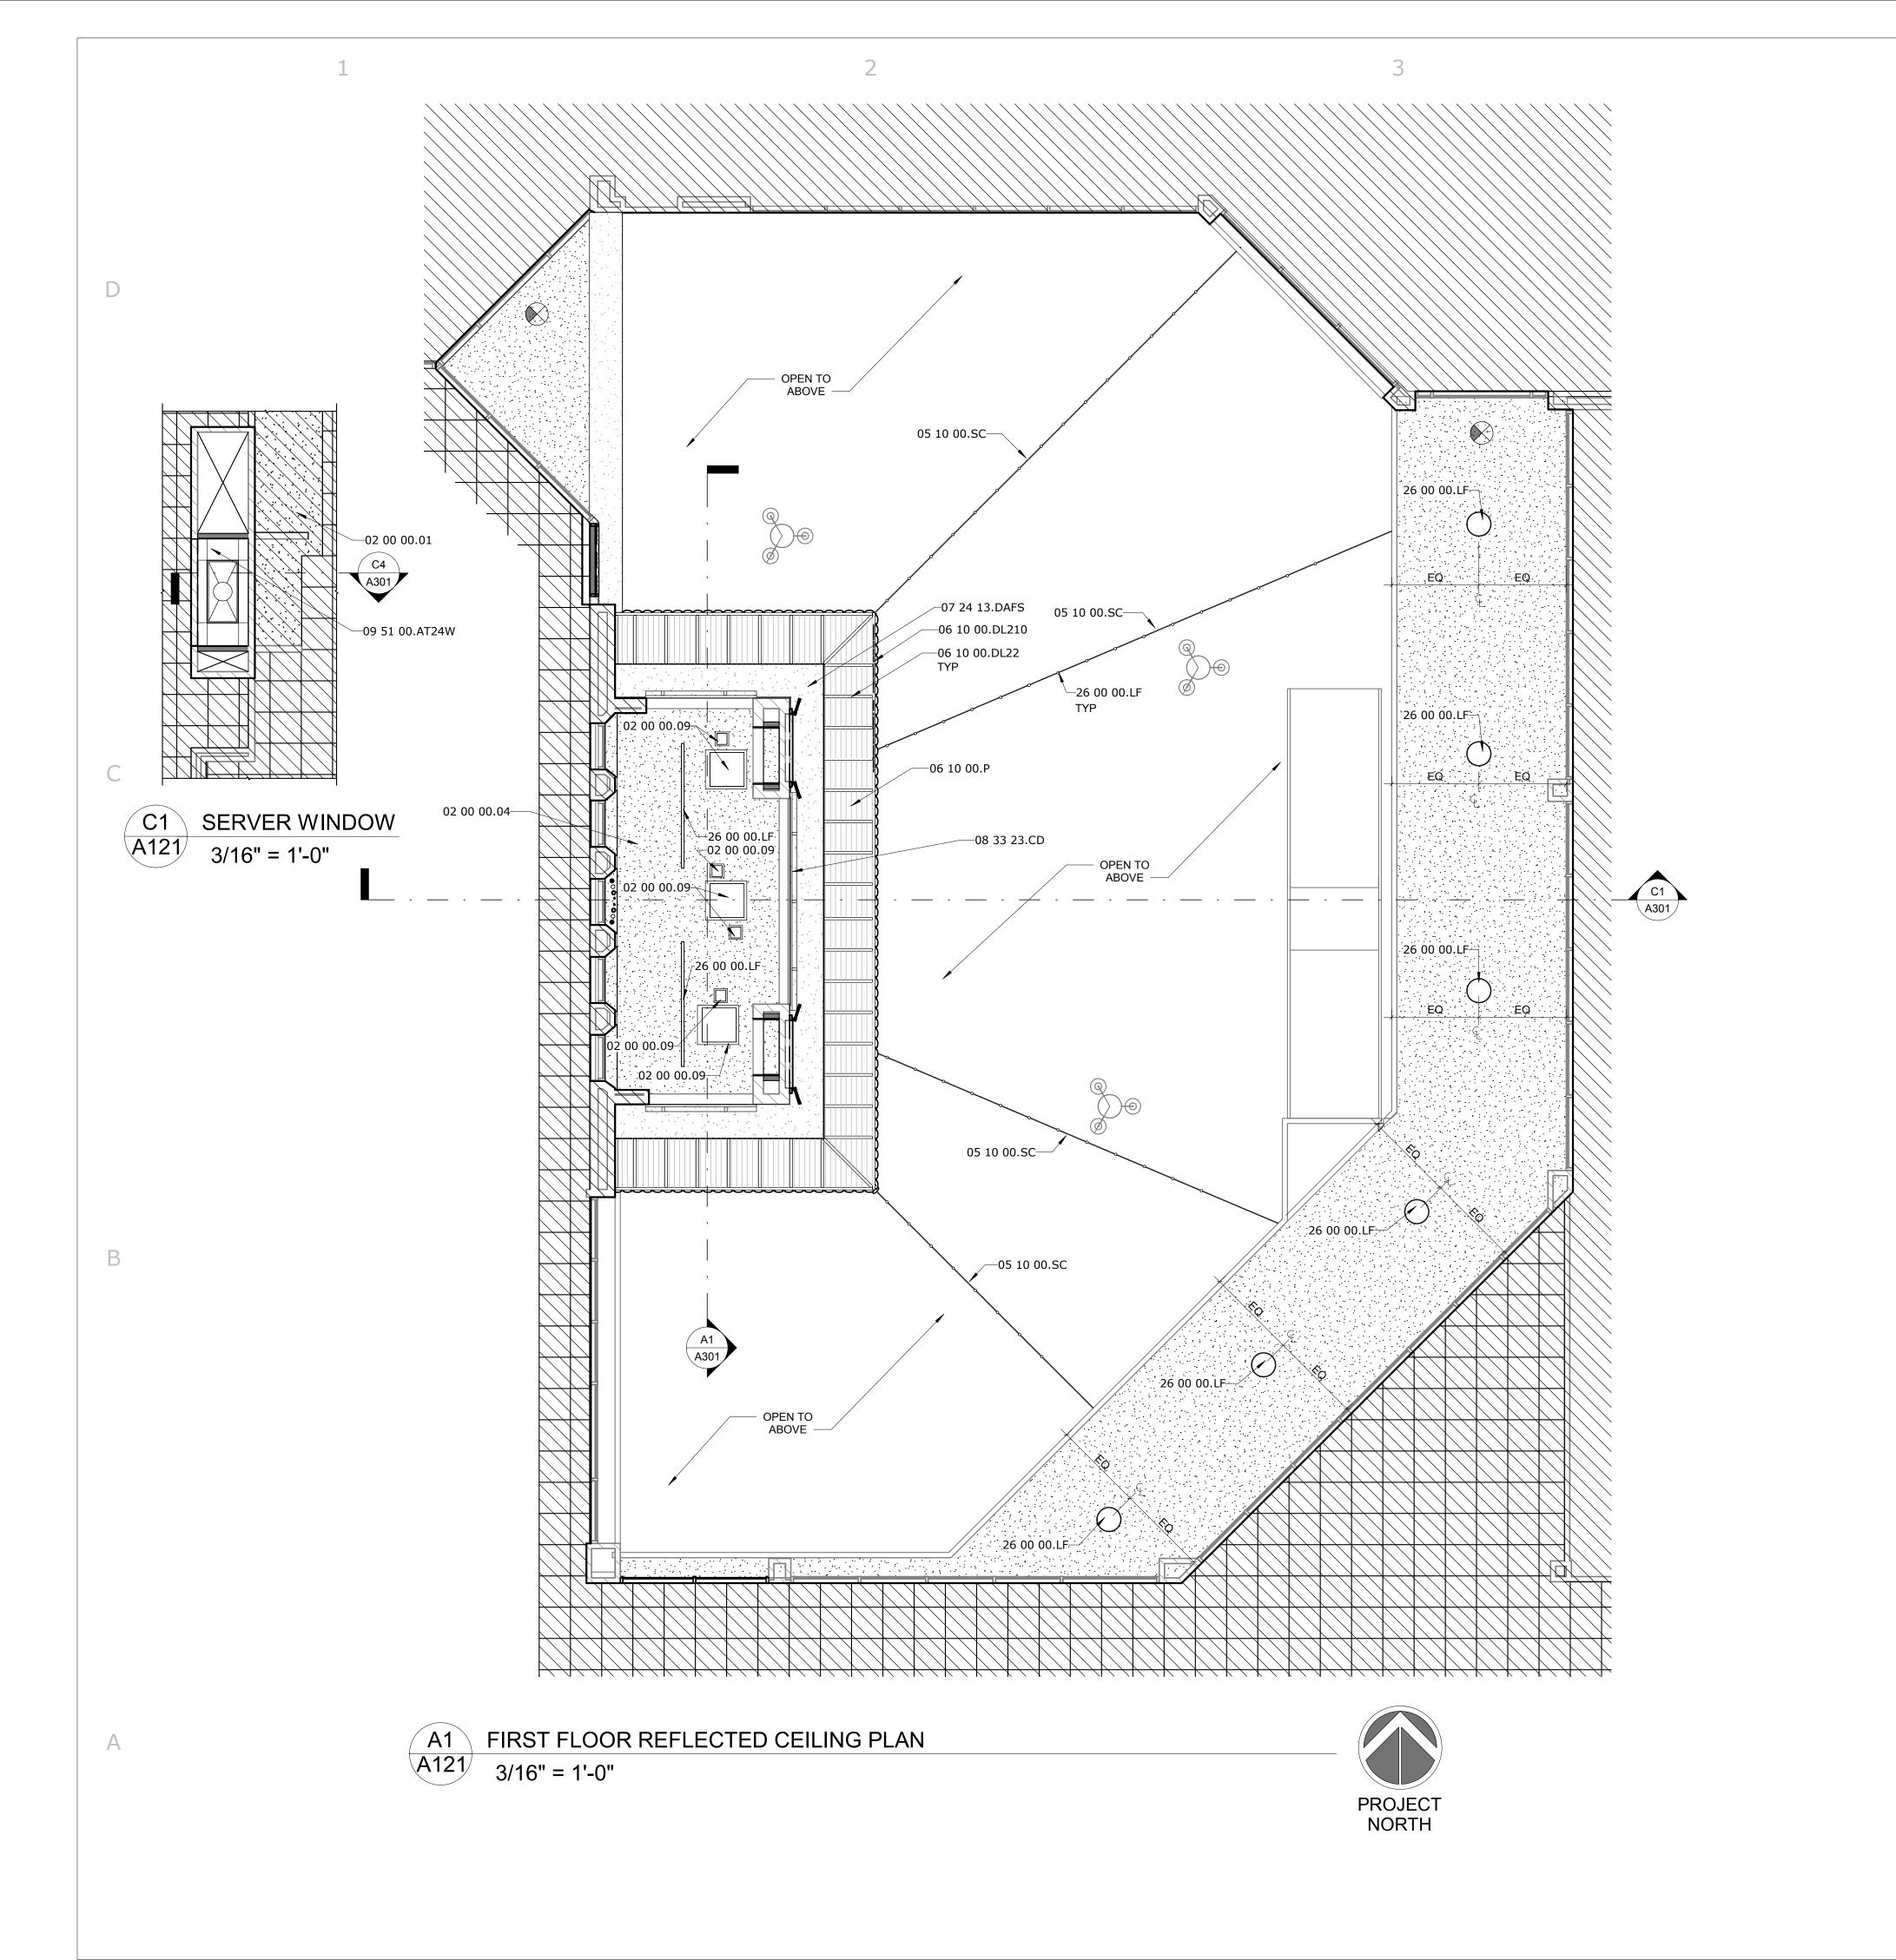
SHEET TITLE **EQUIPMENT PLAN & EQUIPMENT** SCHEDULE



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**ENLARGED FLOOR** PLAN & DETAILS





#### GENERAL NOTES RCP PLAN

CONTRACTOR SHALL COORDINATE WITH ALL MECHANICAL, ELECTRIAL AND PLUMBING ENGINEERING SHEETS FOR ADDITIONAL CEILING MOUNTED EQUIPMENT.

CONTRACTOR TO REPAIR ANY DAMAGE DONE TO EXISTING DURING CONSTRUCTION.

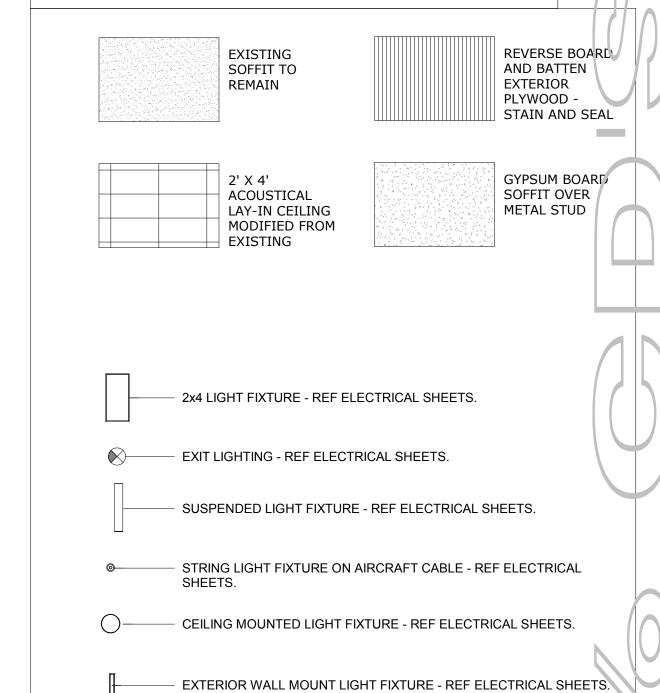
#### KEYNOTE LEGEND

02 00 00.01 EXISTING CONSTRUCTION TO REMAIN
02 00 00.04 EXISTING SOFFIT TO REMAIN - PATCH/REPAIR AS REQUIRED - PAINT (COLOR SELECTED BY ARCHITECT)
02 00 00.09 EXISTING CHASE ACCESS PANELS TO REMAIN
05 10 00.SC 1/8" Ø STAINLESS STEEL AIRCRAFT CABLE TO HOST LIGHT FIXTURE; ATTACH AT BOTH ENDS - REFER TO ATTAHCMENT DETAILS
06 10 00.DL22 DIMENSIONAL LUMBER, 2X2 TREATED WOOD BATTEN @ 2'-0" O.C. - STAIN AND SEAL TO MATCH SOFFIT
06 10 00.DL210 DIMENSIONAL LUMBER, CEDAR 2X10 FASCIA BOARD - STAIN AND SEAL
06 10 00.P 5/8" YELLOW PINE REVERSE BOARD AND BATTEN EXTERIOR PLYWOOD - STAIN AND SEAL
07 24 13.DAFS DIRECT APPLIED FINISH SYSTEM
08 33 23.CD OVERHEAD COILING DOOR

09 51 00.AT24W | SUSPENDED TILE CEILING, 2X4 - EXISTING, RECONFIGURED

26 00 00.LF LIGHT FIXTURE - REFER TO ELECTRICAL

#### RCP LEGEND





COURTYARD BAR

CORBETT

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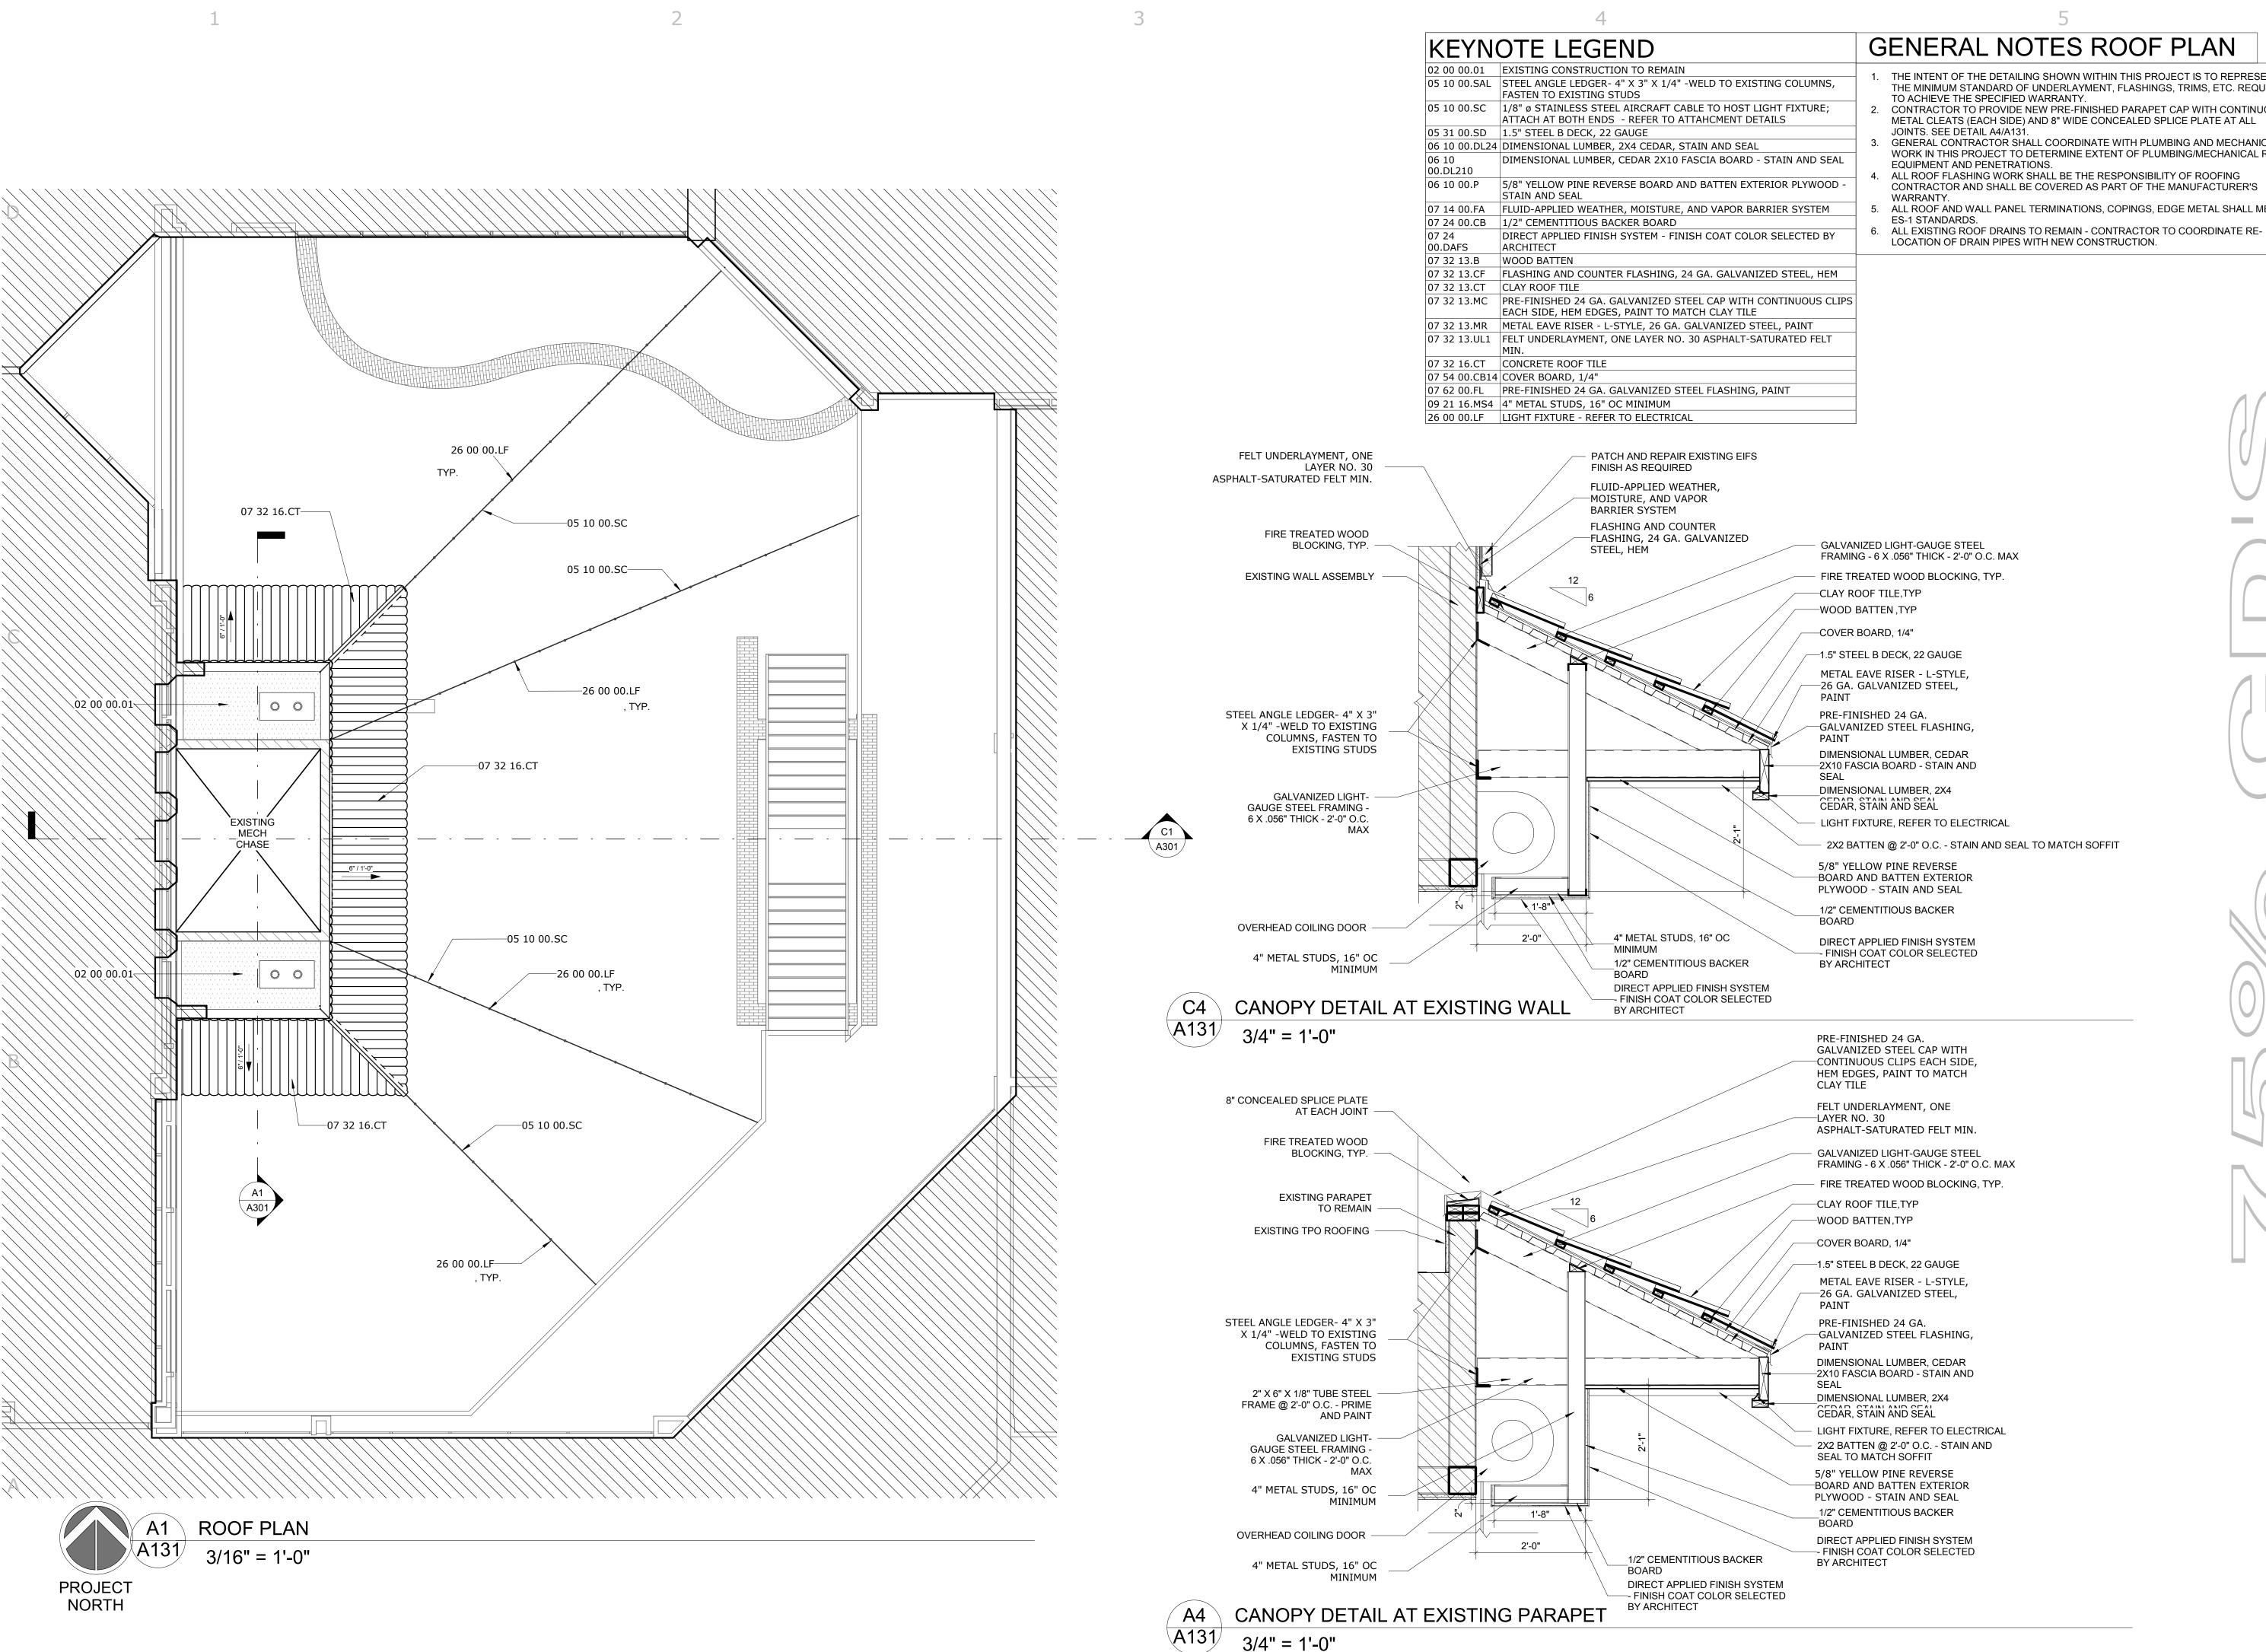
PROJECT NO. 206-98

SHEET TITLE

FIRST FLOOR REFLECTED CEILING PLAN

SHEET NO.

A121



1. THE INTENT OF THE DETAILING SHOWN WITHIN THIS PROJECT IS TO REPRESENT THE MINIMUM STANDARD OF UNDERLAYMENT, FLASHINGS, TRIMS, ETC. REQUIRED

CONTRACTOR TO PROVIDE NEW PRE-FINISHED PARAPET CAP WITH CONTINUOUS METAL CLEATS (EACH SIDE) AND 8" WIDE CONCEALED SPLICE PLATE AT ALL

GENERAL CONTRACTOR SHALL COORDINATE WITH PLUMBING AND MECHANICAL WORK IN THIS PROJECT TO DETERMINE EXTENT OF PLUMBING/MECHANICAL ROOF

CONTRACTOR AND SHALL BE COVERED AS PART OF THE MANUFACTURER'S

5. ALL ROOF AND WALL PANEL TERMINATIONS, COPINGS, EDGE METAL SHALL MEET

ORB

NOINO

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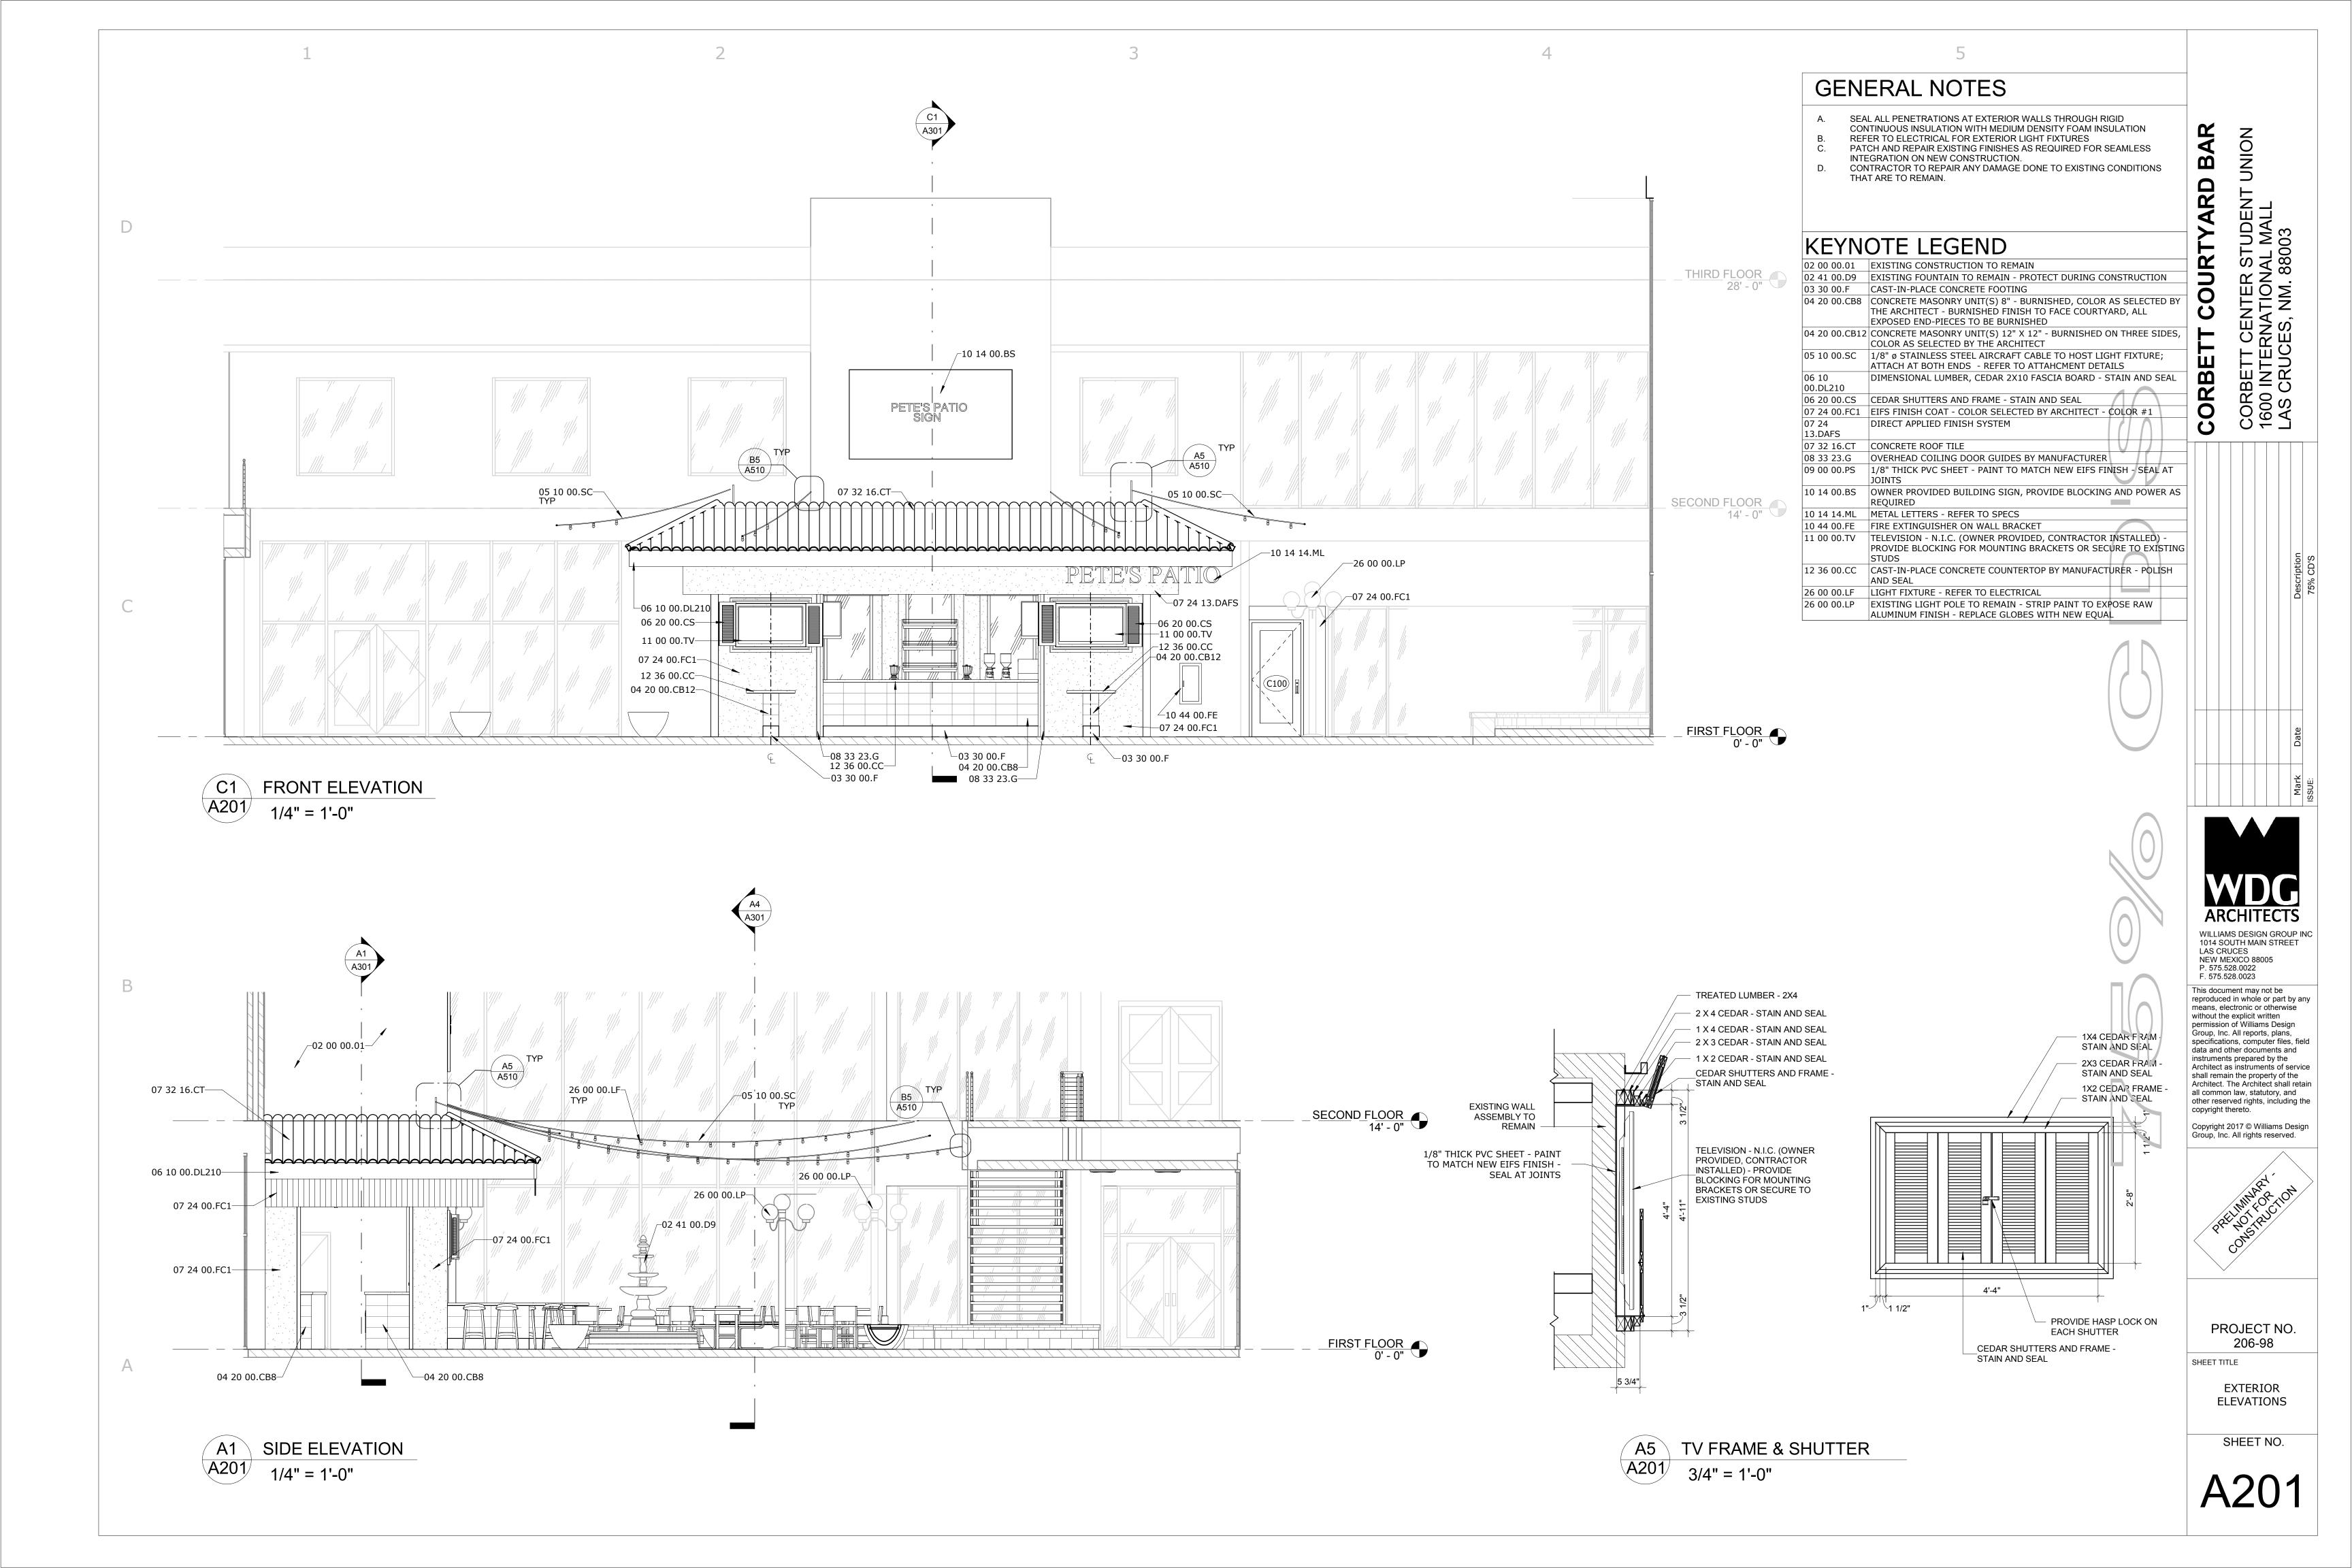
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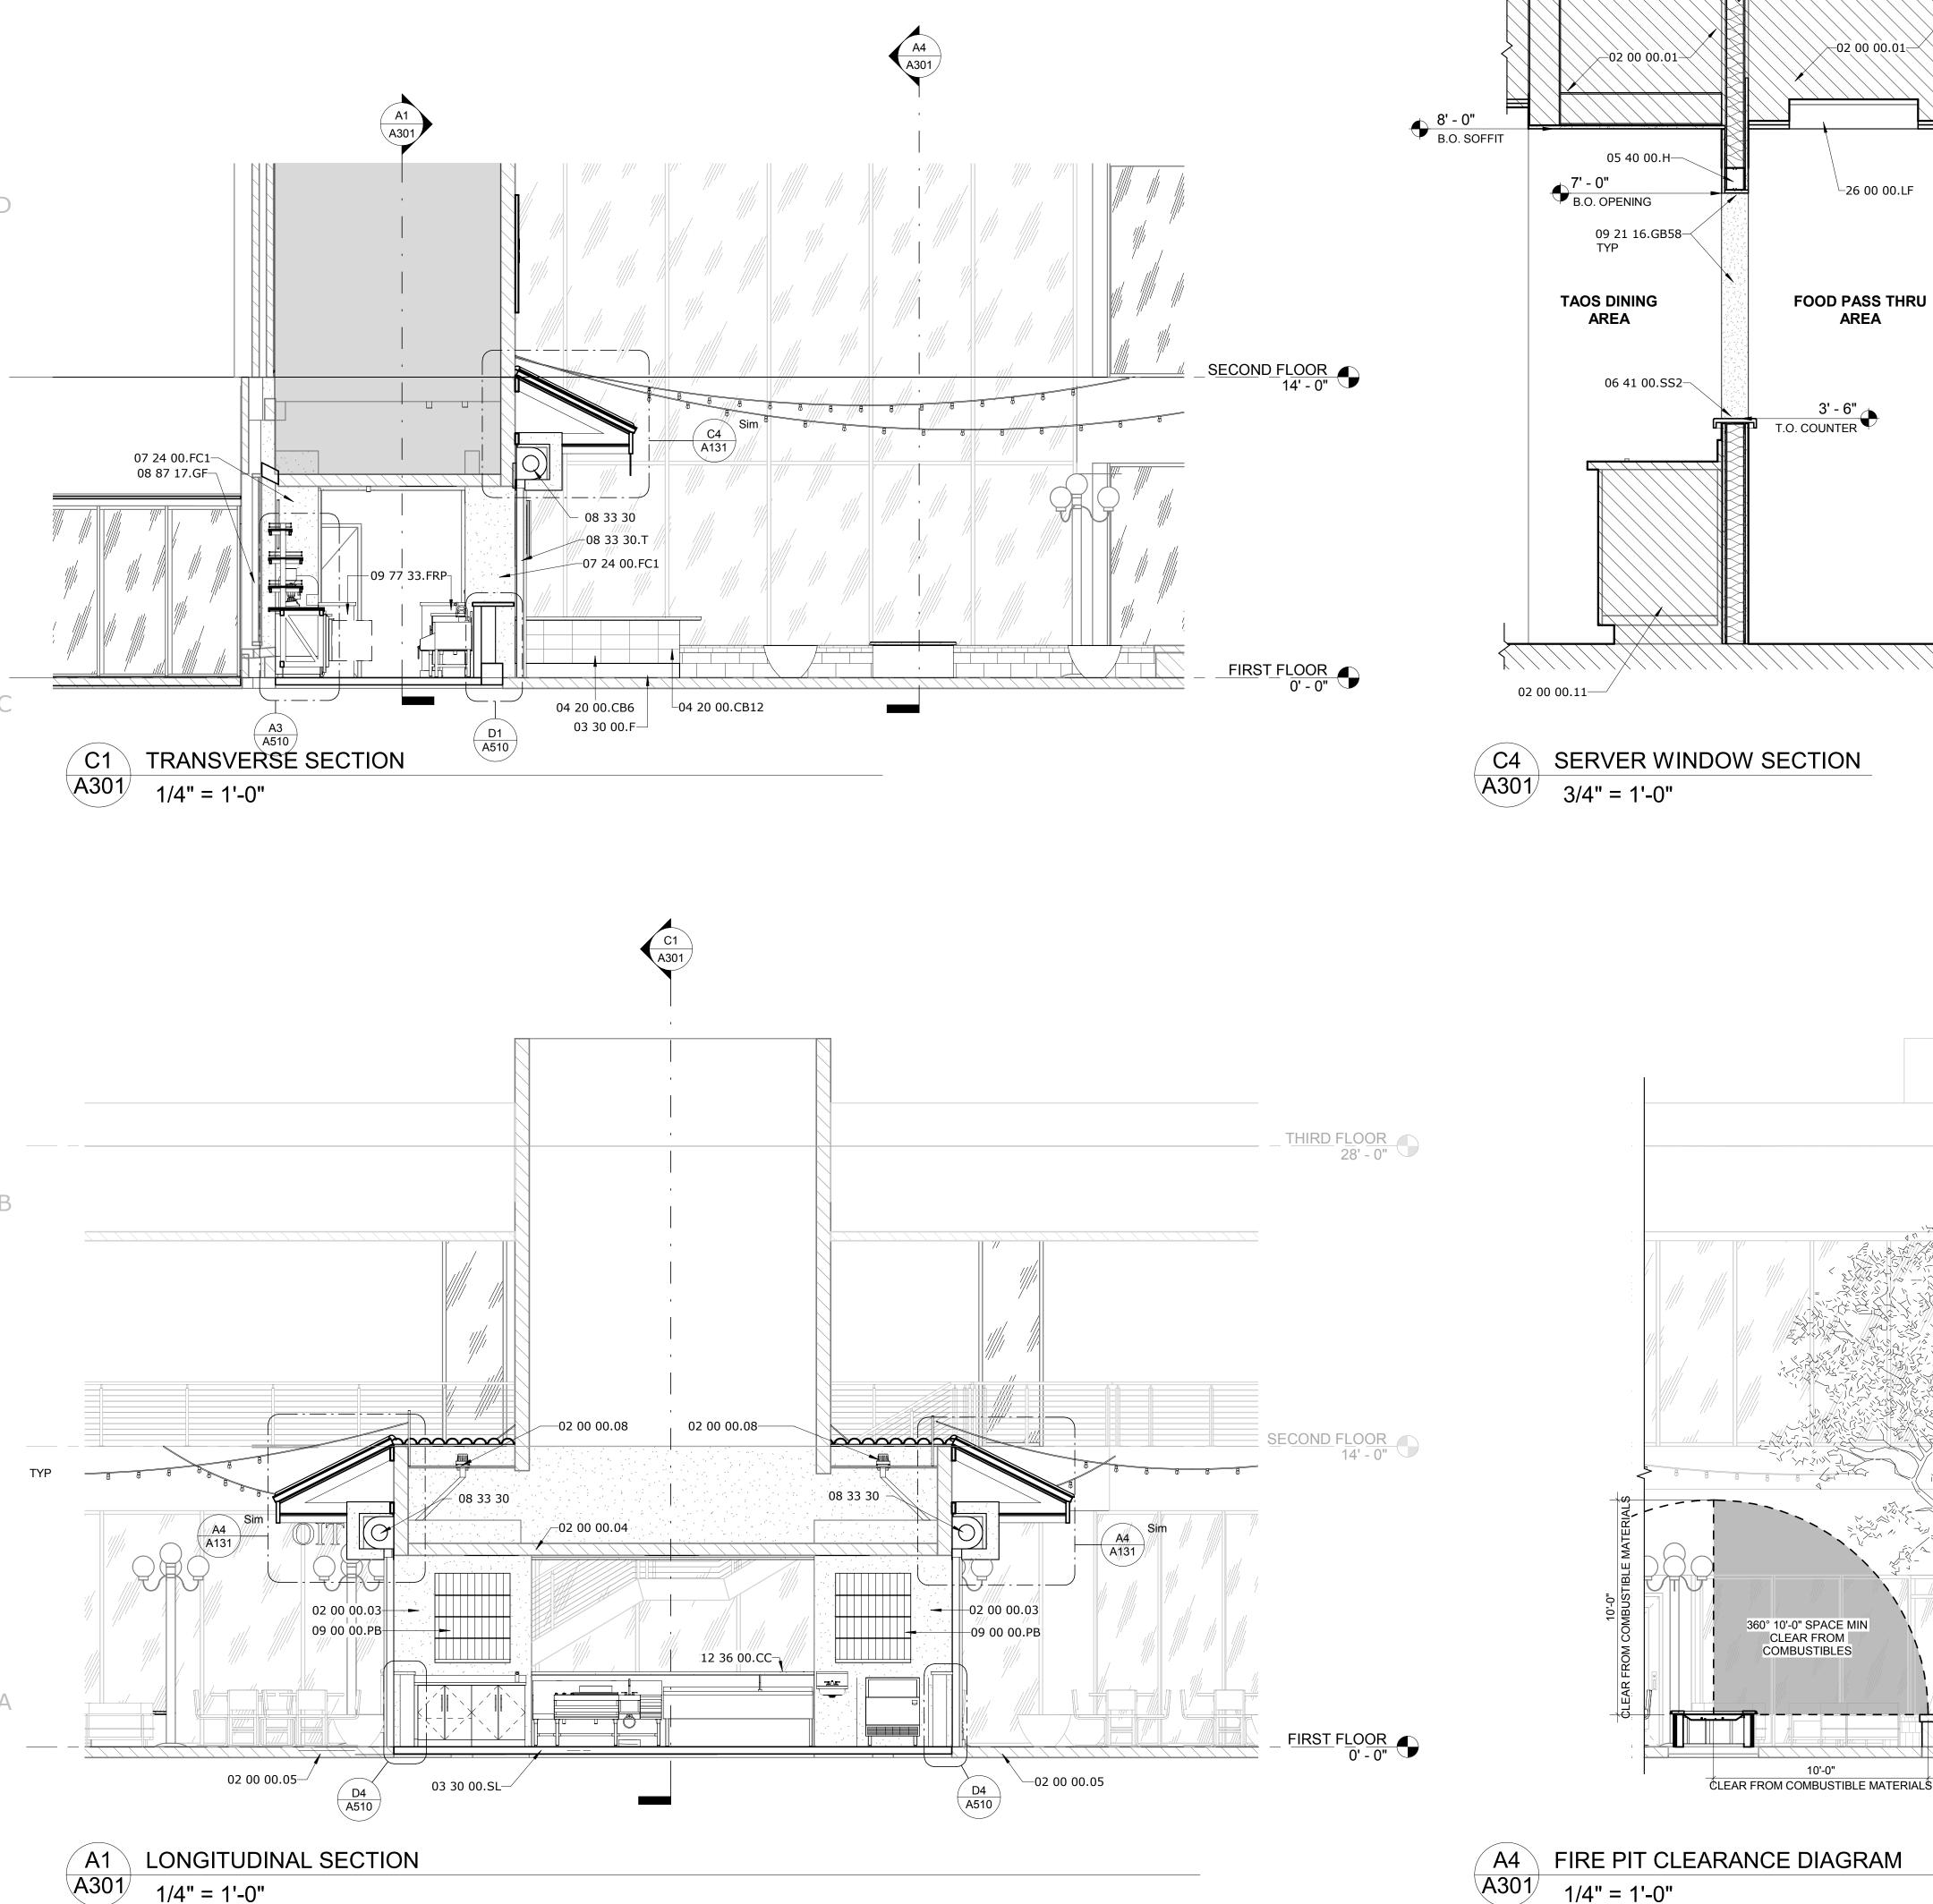


PROJECT NO. 206-98

SHEET TITLE

**ROOF PLAN & ROOF DETAILS** 





#### **GENERAL NOTES**

- ALL DIMENSIONS ARE TO FACE OF EXISTING FINISHES OR FINISHED FLOOR. REFERENCE SHEET G003 FOR MOUNTING HEIGHTS AND ADA CLEARANCES PROVIDE BACKING AT ALL SHELVES, BRACKETS AND WALL HUNG FIXTURES
- AND WALL HUNG ACCESSORIES EXTEND INFILL WALLS TO B.O. EXISTING OR NEW SOFFITS OR CEILINGS INTEGRATE NEW CONSTRUCTION WITH OLD CONSTRUCTION. PATCH AND REPAIR EXISTING FINISHES AS REQUIRED FOR SEAMLESS INTEGRATION.

#### KEYNOTE LEGEND

—05 40 00.Н

**KITCHEN** 

─\_09 21 16.GB58

02 00 00.01 EXISTING CONSTRUCTION TO REMAIN 02 00 00.03 EXISTING EIFS WALL TO REMAIN - PATCH / REPAIR AS REQUIRED - APPLY NEW ELASTOMERIC BASE COAT WITH INTEGRATED MESH AND NEW FINISH COAT (COLOR SELECTED BY ARCHITECT) 02 00 00.04 EXISTING SOFFIT TO REMAIN - PATCH/REPAIR AS REQUIRED - PAINT (COLOR SELECTED BY ARCHITECT) 02 00 00.05 EXISTING PAVERS TO REMAIN 02 00 00.08 EXISTING ROOFING AND ROOF DRAINS TO REMAIN - LEADER PIPES TO BE RE-ROUTED TO THE OUTSIDE OF COLUMN CHASE AS FAR AS POSSIBLE 02 00 00.11 EXISTING CASEWORK AND COUNTER TO REMAIN - PROTECT DURING

CONSTRUCTION 03 30 00.F CAST-IN-PLACE CONCRETE FOOTING

03 30 00.SL 4" CAST-IN-PLACE CONCRETE SLAB WITH #4 @12" O.C.E.W. - SLOPED TO POSITIVE DRAINAGE 04 20 00.CB6 | CONCRETE MASONRY UNIT(S) 6" - BURNISHED, COLOR AS SELECTED BY THE ARCHITECT - BURNISHED FINISH TO FACE COURTYARD, ALL EXPOSED END-PIECES TO BE BURNISHED 04 20 00.CB12 CONCRETE MASONRY UNIT(S) 12" X 12" - BURNISHED ON THREE SIDES,

COLOR AS SELECTED BY THE ARCHITECT 05 40 00.H BUILT-UP STUD HEADER - LIGHT GAGE STEEL STUDS 06 41 00.SS2 | SOLID SURFACE COUNTERTOP

07 24 00.FC1 | EIFS FINISH COAT - COLOR SELECTED BY ARCHITECT - COLOR #1 08 33 30 SECURITY GRILLES 08 33 30.T TRACK 08 87 17.GF GLAZING FILM TO 4'-0" A.F.F., TYP AT BACK BAR WINDOWS

09 00 00.PB | 1/2" X 4" TOUNGE AND GROOVE PROFILE PVC BEAD BOARD - SECURE TO STUDS - PAINT TO MATCH NEW EIFS FINISH - SEAL AT JOINTS GYPSUM BOARD 5/8", STANDARD, PAINTED - LEVEL 5 WHERE EXPOSED 16.GB58

09 77 33.FRP GLASS FIBER REINFORCED PLASTIC PANEL - ADHERE TO BURNISHED CMU OR SECURE TO STUDS - REFER TO WALL TYPES 12 36 00.CC CAST-IN-PLACE CONCRETE COUNTERTOP BY MANUFACTURER - POLISH AND SEAL

26 00 00.LF | LIGHT FIXTURE - REFER TO ELECTRICAL

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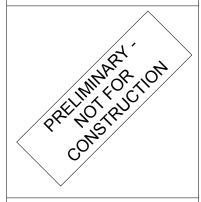
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instruments prepared by the Architect as instruments of service shall remain the property of the Architect. The Architect shall retain




PROJECT NO. 206-98

SHEET TITLE

**BUILDING SECTIONS** & DETAILS

SHEET NO.

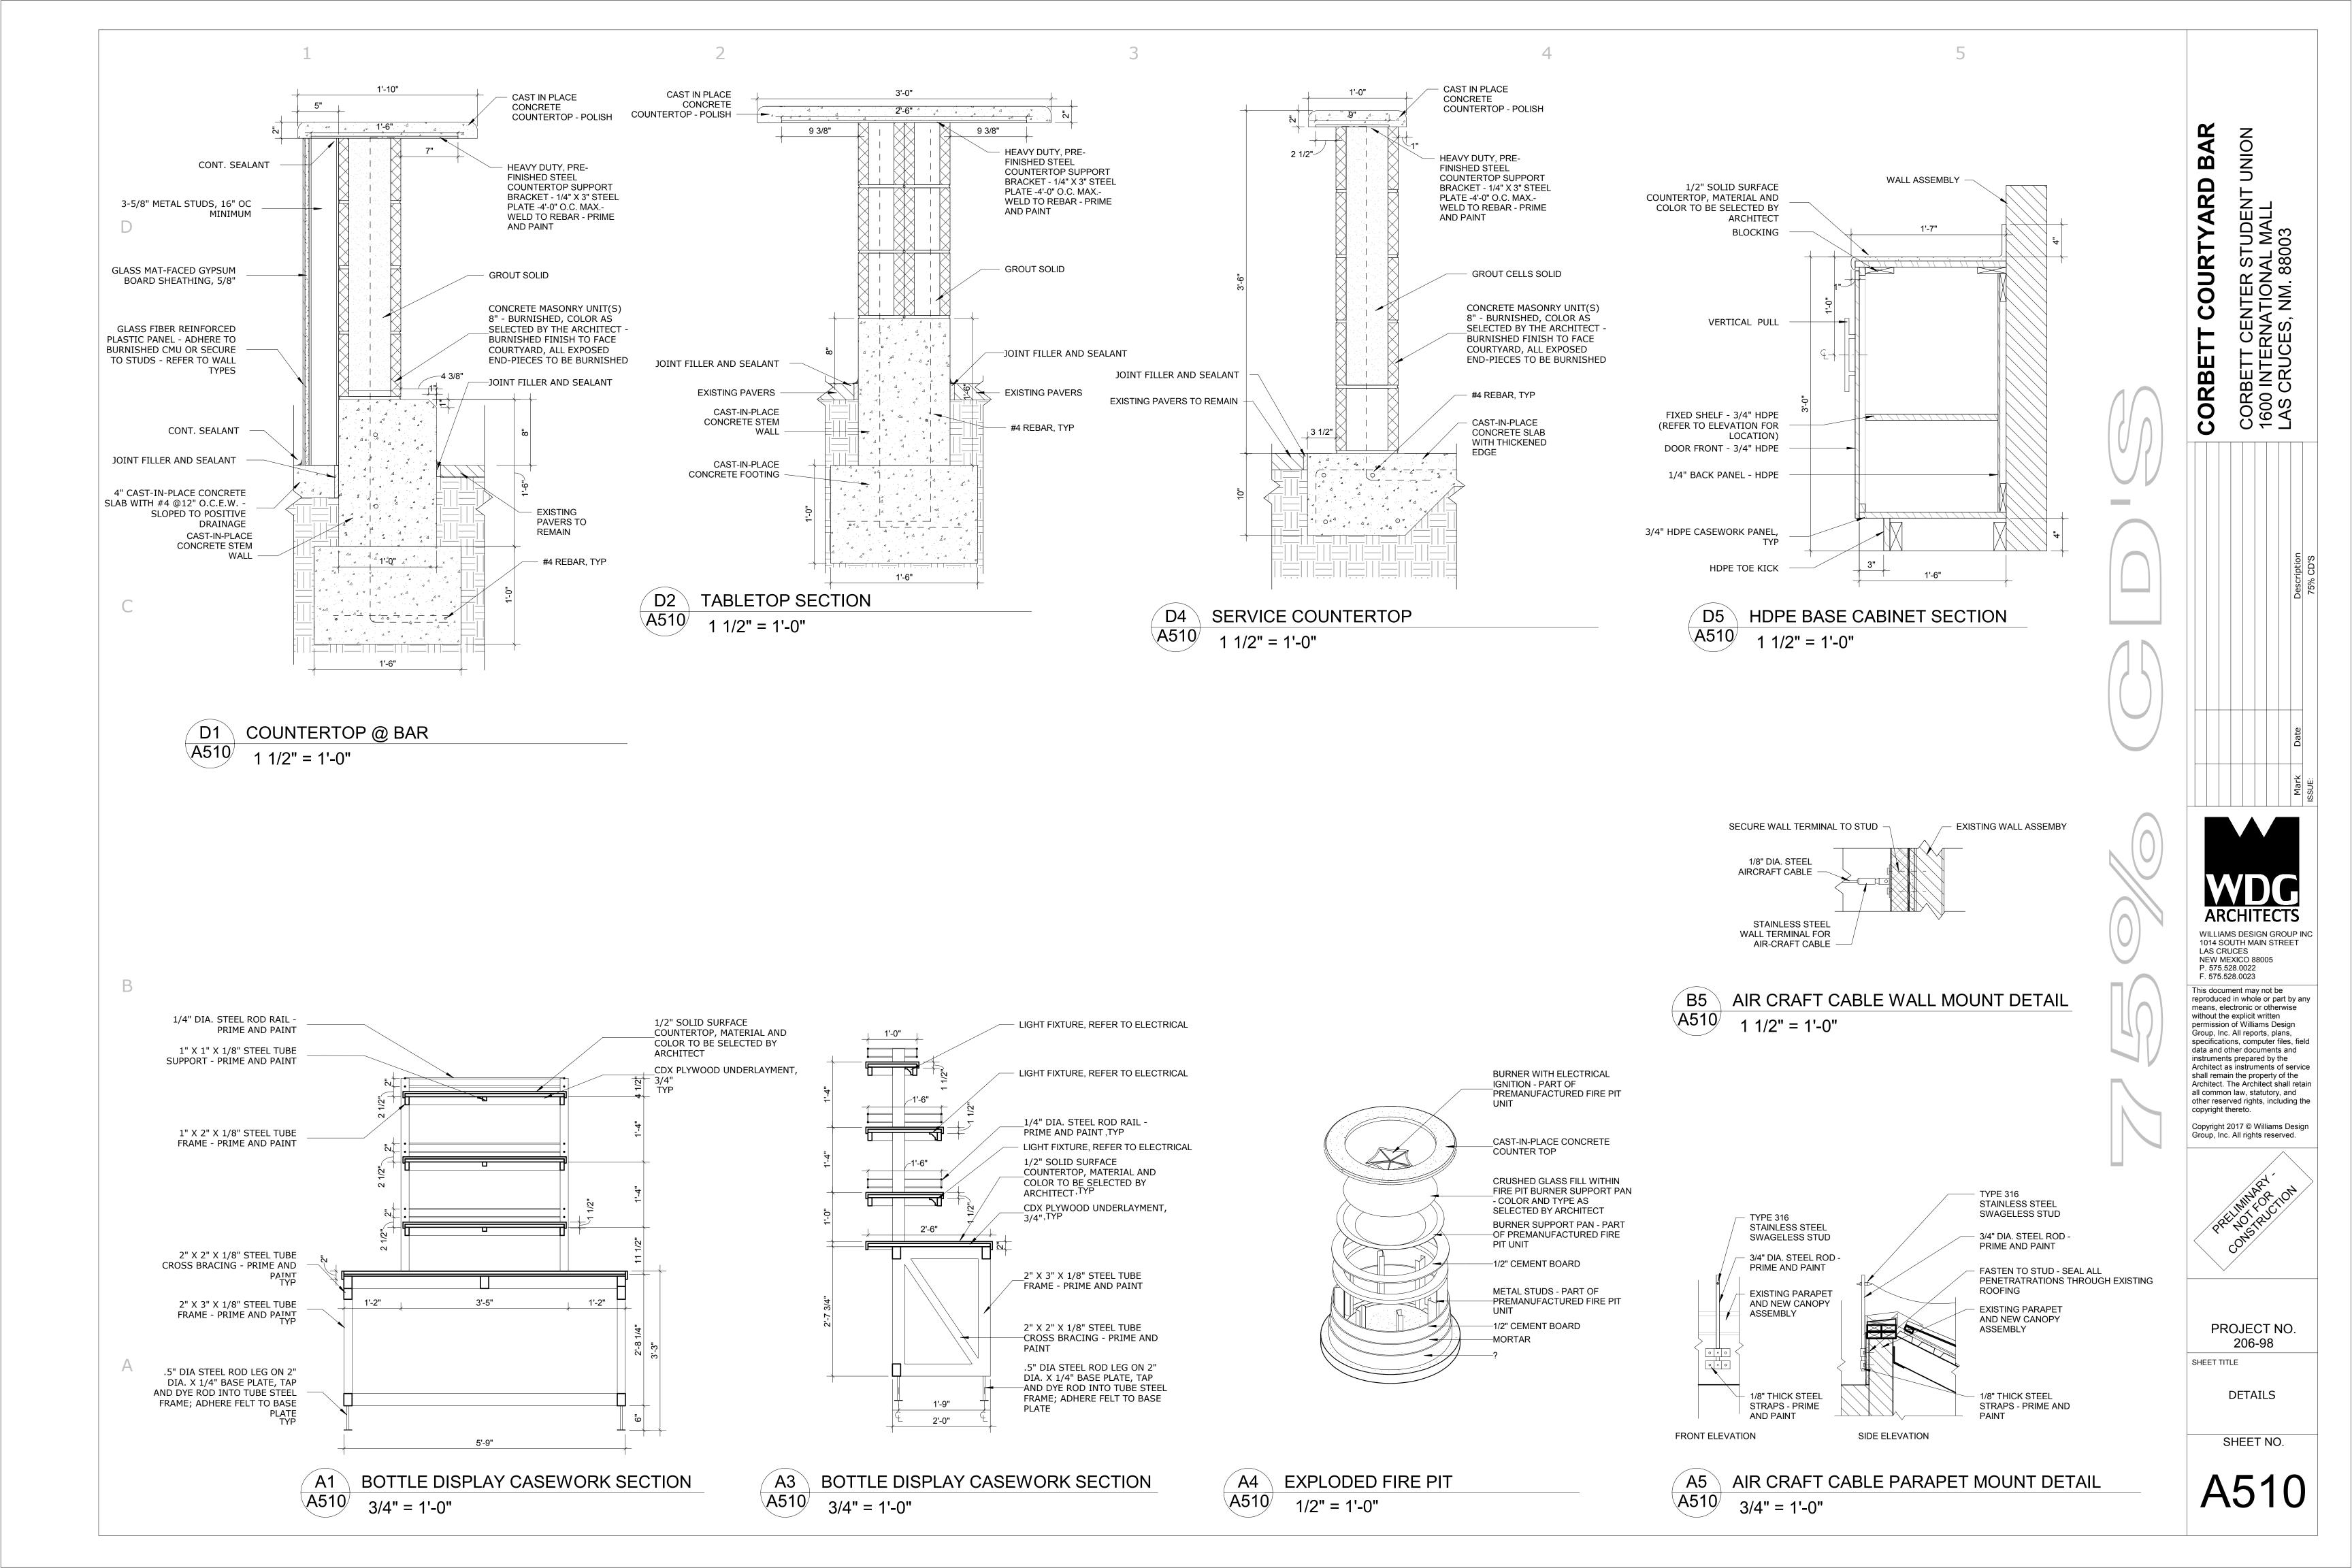1/4" = 1'-0"



C. THE CONTRACTOR SHALL FAMILIARIZE THEMSELF WITH PROJECT PRIOR TO THE BID OPENING, TO ALLOW HIM TO SUBMIT A COMPLETE BID WITHIN THE SCOPE OF THE DRAWINGS AND SPECIFICATIONS. ANY QUESTIONS ARISING DURING THE BID PERIOD, IN REGARD TO THE CONTRACTOR'S FUNCTIONS. THE SCOPE OF THE WORK OR ANY OTHER ISSUE RELATED TO THIS PROJECT SHALL BE BROUGHT UP DURING THE BID PERIOD WITH THE ENGINEER FOR CLARIFICATION PRIOR TO AWARD OF CONTRACT.

CONNECTIONS IN THIS CONTRACT FOR ANY ITEM REQUIRED.

D. IT WILL BE THE CONTRACTOR'S OBLIGATION TO INCLUDE, IN THEIR BID, THE COSTS FOR INSTALLING JUNCTION BOXES, PROVIDING MISCELLANEOUS COVERS, WORK WITH OTHER DISCIPLINES WHERE THE CONTRACT INVOLVES ELECTRICAL POWER OR CONTROL CONNECTIONS, SWITCHES, ETC. ALL OF THIS WORK SHALL BE PART OF THIS CONTRACT.

E. LOCATION OF EQUIPMENT AND OTHER DEVICES SHOWN ON THE PLANS ARE APPROXIMATE AND SHALL BE FIELD VERIFIED, COORDINATE WITH ARCHITECTURAL DOCUMENTS FOR EXACT LOCATIONS.

F. THE CONDUIT RUNS AS SHOWN ON PLANS INDICATE APPROXIMATE ROUTING. EXACT LOCATION OF CONDUIT RUNS SHALL BE AS FIELD CONDITIONS DICTATE.

G. CONTRACTOR SHALL INSTALL PULL AND JUNCTION BOXES WHEREVER REQUIRED BY N.E.C. OR JOB CONDITIONS. ALL NEW WIRING SHALL BE TAGGED AT ALL PULL BOXES, JUNCTION BOXES, EQUIPMENT BOXES AND CABINETS WITH APPROVED PLASTIC TAGS. ACTION CRAFT, BRADY OR APPROVED EQUAL.

H. SHOULD CONTRACTOR AT ANY TIME NOTICE THAT THE ACTUAL FIELD CONDITIONS DO NOT CORRESPOND TO THE INFORMATION GIVEN ON THE DRAWINGS, THEN IT WILL BE THEIR RESPONSIBILITY TO NOTIFY THE ENGINEER FOR CLARIFICATION, PRIOR TO COMMENCING SUCH WORK.

I IT SHALL BE THE RESPONSIBILITY OF THE CONTRACTOR TO COORDINATE WITH ALL TRADES FOR THE EXACT LOCATION OF EQUIPMENT AND APPURTENANCES THAT REQUIRE ELECTRICAL CONNECTIONS.

J. CONTRACTOR SHALL MAKE AS-BUILT DRAWINGS DOCUMENTING ANY AND ALL WIRING AND EQUIPMENT CONDITIONS AND CHANGES WHILE COMPLETING THIS CONTRACT. PROVIDE UPDATED TYPEWRITTEN DIRECTORIES FOR ALL PANELS AND LABEL ALL PANELS WITH PLASTIC LAMINATED NAMEPLATES.

K. INSTALL BLANK DEVICE PLATES ON ALL UNUSED JUNCTION BOXES IN FINISHED AREAS.

L. ALL ELECTRICAL WIRING AND HOME RUN CIRCUITING TO PANELS SHALL BE ROUTED IN CONDUIT, MIN SIZE 3/4" EMT CONDUIT IF NOT NOTED

M. REFER TO POWER PLANS FOR DETAILED LAYOUTS OF ELECTRICAL GEAR

N. AFTER THE CONTRACTOR HAS RECEIVED APPROVED SHOP DRAWINGS FOR THE ELECTRICAL DISTRIBUTION EQUIPMENT, THEY SHALL SUBMIT SCALED LAYOUTS OF ALL ELECTRICAL EQUIPMENT TO THE ENGINEER FOR APPROVAL TO ENSURE THAT ALL CLEARANCE REQUIREMENTS ARE MET. THIS SUBMITTAL SHALL BE PROVIDED WITH SUFFICIENT TIME SO AS NOT INTERFERE WITH THE TIMELY EXECUTION OF THE ROUGH-IN WORK THAT WILL BE REQUIRED.

O. WHEREVER REQUIRED, FURNISH AND INSTALL ON WALL OR CEILING FREESTANDING UNISTRUT CHANNELS, ANGLE IRONS OR ANY OTHER SUPPORT STRUCTURE WITH THREADED ROD HANGERS AS REQUIRED FOR THE SUPPORT OF ELECTRICAL EQUIPMENT OF ANY KIND TO ENSURE PROPER INSTALLATION.

P. ALL NEW WIRING SHALL BE COPPER, MIN #12 THWN CU.

Q. MOUNTING HEIGHTS INDICATED ON THE DRAWINGS ARE APPROXIMATE. THIS CONTRACTOR SHALL BE RESPONSIBLE FOR COORDINATING WITH OTHER TRADES FOR EXACT HEIGHT REQUIRED. THIS REQUIREMENT ALSO APPLIES TO THE LOCATION OF WALL BOXES FOR HVAC SENSORS, T-STATS, ETC. THIS NOTE APPLIES TO ALL ELECTRICAL SHEETS IN THESE DRAWINGS: OUTLET DEVICES THAT HAVE TO BE RELOCATED DUE TO COUNTERTOP, CHALKBOARD, TACKBOARD, TYPE CONFLICTS WILL BE DONE AT NO ADDITIONAL COST TO THE OWNER.

R. ELECTRICIAN TO CONFIRM POWER REQUIREMENTS FOR MECHANICAL EQUIPMENT DELIVERED ON SITE.

#### S. ALL EXPOSED CONDUIT SHALL BE PAINTED TO MATCH ARCHITECTURAL WALL OR CEILING.

T. CONTRACTOR SHALL SAW CUT AND PATCH ASPHALT, CONCRETE OR OTHER MATERIAL ENCOUNTERED AS REQUIRED TO INSTALL NEW UNDERGROUND RACEWAY. REFER TO ARCHITECTURAL REGARDING

PATCHING REQUIREMENTS. U. CONTRACTOR SHALL COORDINATE INSTALLATION OF NEW LAY-IN FIXTURES WITH ARCHITECTURAL REFLECTED CEILING PLAN AND

V. PROVIDE BLANK METAL COVERPLATE OVER ALL UNUSED OUTLET BOXES. PAINT COVERPLATE TO MATCH ADJACENT SURFACES.

MECHANICAL DIFFUSERS PRIOR TO INSTALLATION OF FIXTURES.

W. OUTLET MOUNTING HEIGHTS INDICATED ON THE DRAWINGS ARE APPROXIMATE. THIS CONTRACTOR SHALL BE RESPONSIBLE FOR COORDINATING WITH OTHER TRADES FOR EXACT HEIGHT REQUIRED. THIS REQUIREMENT ALSO APPLIES TO SWITCHES, TELEPHONE OUTLETS, DATA OUTLETS, HVAC SENSORS, ETC.. ANY DEVICE THAT HAS TO BE RELOCATED DUE TO CONTRACTOR'S FAILURE TO COORDINATE LOCATION WITH COUNTERTOPS, CHALKBOARDS, TACKBOARDS, ETC. WILL BE DONE AT NO ADDITIONAL COST TO THE OWNER.

X. ALL RECEPTACLES TO BE 20A COMMERCIAL GRADE, IVORY. WALL PLATES TO MATCH. ISOLATED GROUND DUPLEX RECEPTACLES (IG) WILL BE ORANGE BODY AND FACE PLATE.

Y. INSTALL WALL MOUNTED LIGHT FIXTURES, SWITCHES, OUTLETS, AND COMMUNICATION DEVICES IN STRICT COORDINATION WITH ARCHITECTURAL DETAILS, SECTIONS AND ELEVATIONS.

Z. FIRESTOPPING OF PENETRATIONS IN FIRE-RATED WALLS, FLOORS, etc. SHALL BE DONE BY A FIRESTOPPING CONTRACTOR. ELECTRICAL CONTRACTOR SHALL MAKE REQUIRED PENETRATIONS IN RATED WALLS. FLOORS, etc. NEATLY AND WITH A CUTTING TOOL, THE CONTRACTOR SHALL MAKE THE PENETRATIONS NO LARGER THAN NECESSARY, AND THE CONTRACTOR SHALL COORDINATE ALL SUCH PENETRATIONS WITH THE FIRE STOPPING CONTRACTOR BEFORE SUCH PENETRATIONS ARE

AA. PROVIDE 1" CONDUIT WITH PULLSTRING FROM COMMUNICATION OUTLETS TO ABOVE SUSPENDED CEILING.

BB. SUPPORT ALL FIXTURES FROM STRUCTURE ABOVE. CEILING TILES OR PLASTER CEILING SHALL NOT SUPPORT FIXTURES.

CC. FINISHED FLOOR ELEVATIONS FOR OUTLETS AND OTHER DEVICES ARE TO CENTER OF BOX. WHERE MILLWORK IS PRESENT, BOTTOM OF BOX SHALL BE MINIMUM OF 2" ABOVE BACK- SPLASH, REGARDLESS OF DIMENSION SHOWN ON PLANS.

DD. SUPPORT HORIZONTAL RUNS OF EMT CONDUIT EVERY 10'-0" AND AT EVERY FITTING, BOX, PANEL, ETC..

EE. USE GLAND RING COMPRESSION THREADED FITTINGS WITH INSULATED THROAT FOR EMT CONDUIT. DOUBLE SET SCREW FITTINGS ARE ACCEPTABLE FOR 2-1/2" CONDUIT AND LARGER ONLY.

FF. ELECTRICAL CONTRACTOR SHALL COORDINATE WITH MECHANICAL CONTRACTOR THE MECHANICAL EQUIPMENT'S ELECTRICAL REQUIREMENTS. INCLUDING POWER, CONTROL, COMMUNICATION, AND MONITORING, OF EACH DEVICE PROVIDED AND/OR INSTALLED BY MECHANICAL

GG. BEFORE INSTALLATION, EQUIPMENT AND DEVICES INCLUDING, BUT NOT LIMITED TO, ANY DEVICE WITH ELECTRICAL CONNECTIONS, DUCTWORK, DIRECTLY ON GRADE OR ON A SLAB OR FLOOR. BEFORE AND AFTER INSTALLATION, SUCH EQUIPMENT AND DEVICES SHALL BE PROTECTED FROM ENTRY OF DIRT, TRASH, WATER (EXCEPT AS REQ'D), VERMIN, ETC...

HH. DEVICES THAT MIGHT CAUSE OR OPERATE WITH VIBRATION OR NOISE SHALL BE ISOLATED PER MANUFACTURER'S RECOMMENDATIONS.

II. ELECTRICAL DEVICE INSTALLATION SHALL COMPLY WITH ACCESSIBILITY CODES ADOPTED FOR NEW MEXICO. SPECIFICALLY MOUNT APPLICABLE SWITCHES, RECEPTACLES, AND ENVIRONMENTAL CONTROLS SO THAT THEY ARE MOUNTED WITH THE TOP OF THE DEVICE NO HIGHER THAN FOURTY-EIGHT (48 INCHES) ABOVE THE FINISH FLOOR AND THE BOTTOM OF THE DEVICE NO LOWER THAN FIFTEEN INCHES (15 INCHES) ABOVE THE FINISHED FLOOR. ELECTRICAL DEVICES ABOVE A COUNTERTOP OR OTHER OBSTRUCTION SHOULD COMPLY WITH ICC/ANSI 117.1-2003 SECTION 308.

JJ. EXTERIOR LIGHTING SHALL COMPLY WITH THE LAS CRUCES OUTDOOR LIGHTING ORDINANCE AND THE NEW MEXICO NIGHT SKY PROTECTION.

KK. THE MEANS OF EGRESS TRAVEL SHALL BE ILLUMINATED AT ANY TIME THE BUILDING IS OCCUPIED WITH A LIGHT INTENSITY OF NOT LESS THAN 1 FOOT CANDLE AT THE FLOOR LEVEL.

LL. ABANDONED POWER WIRING WILL BE REMOVED BACK TO THE SOURCE. THE ACCESSIBLE PORTIONS OF ABANDONED CONDUIT/TUBING AND EQUIPMENT SHALL BE REMOVED. THE ACCESSIBLE PORTIONS OF ABANDONED CABLES (VOICE, DATA, VIDEO, ALARM, ETC.) SHALL BE REMOVED.

MM. ALL CONDUIT INSTALLED ON THE ROOF MUST BE SUPPORTED, WITH CONDUIT SUPPORTS EVERY 10'-0". CONDUIT SUPPORT TO BE DURA-BLOCK, CONTRACTOR TO PROVIDED SIZED AND ACCESSORIES REQUIRED.

NN. ALL GFCI RATED RECEPTACLE SHALL BE INSTALLED IN AN ACCESSIBLE SERVICE LOCATION, IT SHALL NOT BE INSTALLED BEHIND ANY EQUIPMENT. IF NEEDED CONTRACTOR SHALL HAVE THE OPTION TO PROVIDE A GFCI RATED CIRCUIT BREAKER WHERE REQUIRED BY CODE. ALL EQUIPMENT GFCI RATED RECEPTACLES SHALL NOT BE INSTALLED MORE THAN 12"FROM SERVING EQUIPMENT. COORDINATE ALL LOCATIONS WITH EQUIPMENT INSTALLER BEFORE DOING ANY WORK.

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PROJECT NO. 206-98

SHEET TITLE

ELECTRICAL GENERAL

SHEET NO.

06-14-18

1. THE ELECTRICAL WORK SHALL BE PERFORMED IN STRICT ACCORDANCE 6. PROVIDE THE OWNER WITH THREE (3) COPIES OF ALL INSTALLATIONS WITH THE APPLICABLE AND ADOPTED PROVISIONS OF THE NATIONAL INSTRUCTIONS, PRODUCT DATA SUBMITTAL INFORMATION, WARRANTIES, ELECTRICAL CODE, ENERGY CODE AS ADOPTED AND INTERPRETED BY CONTACT INFORMATION DURING WARRANTY PERIOD AND BALANCING THE STATE OF NEW MEXICO AND THE NATIONAL FIRE PROTECTION REPORTS IN 3-RING BINDERS.

В

**ELECTRICAL SPECIFICATIONS** 

ORDINANCES.

CONTRACTOR.

UNLESS OTHERWISE INDICATED

SCHEDULES ON THE DRAWINGS.

ASSOCIATION (NFPA) REGULATIONS, CURRENT ADOPTED EDITION

HIS FAILURE TO COMPLY WITH ALL APPLICABLE CODES AND

REGARDING MECHANICAL SYSTEMS, FIRE SYSTEMS AND ELECTRICAL

SYSTEMS. ALL MATERIALS AND LABOR NECESSARY TO COMPLY WITH

RULES, REGULATIONS AND ORDINANCES SHALL BE PROVIDED. WHERE

CODE REQUIREMENTS, THE OWNER, ARCHITECT AND ENGINEERS FREE

2 ALL WORK SHALL CONFIRM WITH FEDERAL, STATE, AND LOCAL CODES.

SYSTEMS SHALL BE INSTALLED COMPLETE AND FULLY OPERATIVE

3. ALL MATERIALS SHALL BE NEW EXCEPT WHERE NOTED OTHERWISE. ALL

WORK SHALL PRESENT A NEAT AND MECHANICAL APPEARANCE WHEN

COMPLETED AND SHALL BE EXECUTED IN A WORKMANLIKE MANNER.

4 REQUIRED INSURANCE SHALL BE PROVIDED BY THIS CONTRACTOR FOR

PROTECTION AGAINST PUBLIC LIABILITY AND PROPERTY DAMAGE FOR

THE DURATION OF WORK. CONTRACTOR SHALL SECURE AND PAY ALL

COORDINATE WITH ARCHITECT, ENGINEER OR OWNER. SUBSTITUTIONS

EQUIPMENT AND PRINCIPAL MATERIAL SPECIFIED. CONTRACTOR SHALL

INFORMATION AS NECESSARY FOR EVALUATION. MINIMUM OF SIX (6)

COPIES, OR AS DIRECTED BY THE ENGINEER, OF EACH SECTION SHALL

BE SUBMITTED AND SHALL INCLUDE ALL ITEMS MENTIONED BY MODEL

NUMBER AND/OR MANUFACTURER'S NAME IN THE SPECIFICATION OR IN

INDICATE AND/OR PROVIDE NAME OF MANUFACTURERS, CATALOG AND

REQUESTED BY THE CONTRACTOR SHALL BE PAID FOR BY THE

5. CONTRACTOR SHALL SUBMIT SPECIFIC INFORMATION ON LIST OF

MODEL NUMBERS, CUT SHEETS, AND SUCH SUPPLEMENTARY

PERMITS, FEES, INSPECTIONS, AND TESTS UNLESS OTHERWISE INDICATED.

RULES, AND REGULATIONS. ALL WORK SHALL BE PERFORMED BY A

LICENSED CONTRACTOR IN A FIRST CLASS WORKMANLIKE MANNER. THE

THE DRAWINGS INDICATE MATERIALS OR CONSTRUCTION IN EXCESS OF

7. ALL SYSTEMS AND COMPONENTS SHALL BE APPROVED FOR THE PURPOSE FOR WHICH INSTALLED. ALL EQUIPMENT AND MATERIALS SHALL BE NEW AND FROM ESTABLISHED AMERICAN SUPPLIERS UNLESS OTHERWISE INDICATED.

DIGITAL NOTIFIER

FIRE ALARM KEY PAD

FARA

KP

FIRE ALARM REMOTE ENUNCIATOR

AND HARMLESS FROM LIABILITY OF ANY NATURE OR KIND ARISING FROM 8. THE CONTRACTOR SHALL COORDINATE WITH OWNER, ARCHITECT, AND OR ENGINEER ANY WORK THAT HAS THE POTENTIAL TO HINDER ELECTRICAL SERVICES TO AREA OUTSIDE OF THIS CONTRACT. ALL SHUT-DOWNS OR TIE-INS RELATING TO THESE SYSTEMS SHALL BE SCHEDULED AND SUBMITTED IN WRITING TO BE APPROVED BY THE OWNER'S FACILITY MANAGEMENT, OWNER, ARCHITECT, OR ENGINEER. CONTRACTOR SHALL SUBMIT IN WRITING A SCHEDULE FOR PHASING OF CONSTRUCTION THAT INDICATES AREAS OF FIRST PRIORITY DURING EACH PHASE AND ANTICIPATED COMPLETION TIMES. SCHEDULES SHALL BE SUBMITTED A MINIMUM OF ONE WEEK PRIOR TO COMMENCING WORK. FACILITY MANAGEMENT, OWNER, ARCHITECT OR ENGINEER SHALL REVIEW THESE SCHEDULES AND NOTIFY CONTRACTOR OF ACCEPTANCE PRIOR TO COMMENCEMENT OF WORK.

> CONTRACTOR SHALL FIELD VERIFY EXISTING CONDITIONS AND PROVIDE A WRITTEN REPORT TO THE ARCHITECT OFFICE. THIS REPORT SHALL DESCRIBE EXISTING DAMAGE OR OTHER CONDITIONS THAT MAY INTERFERE WITH THIS PROPOSED NEW WORK. THIS SITE SURVEY SHALL ALSO INCLUDE VERIFICATION OF SIZES, LOCATIONS, AND CONDITIONS OF EXISTING UTILITIES.

10. ALL WIRING SHALL BE RUN IN RIGID CONDUIT, INTERMEDIATE METALLIC CONDUIT (IMC) OR ELECTRICAL METALLIC TUBING (EMT) INSTALLED IN ACCORDANCE WITH THE NEC. MC CABLE IS ALLOWED IN WALLS ONLY. ALUMINUM CONDUIT SHALL NOT BE USED UNLESS SPECIFICALLY INDICATED ON THE DRAWINGS. EMT OR ALUMINUM CONDUIT SHALL NOT BE INSTALLED IN CONCRETE SLABS OR BELOW GRADE. MINIMUM SIZE -3/4 INCH. ALL CONDUITS CONTAINING POWER CONDUCTORS SHALL CONTAIN A EQUIPMENT GROUND CONDUCTOR SIZED IN ACCORDANCE WITH THE NEC. A #9 PULL WIRE SHALL BE INSTALLED IN EACH EMPTY CONDUIT.

11. INCREASE BRANCH CIRCUIT WIRE SIZE AS REQUIRED TO PREVENT EXCESSIVE VOLTAGE DROP AS FOLLOWS: 60' TO 100' - #10 AWG; OVER 100' - #8 AWG.

12. THE CONDUIT SYSTEM AND NEUTRAL CONDUCTOR OF THE WIRING SYSTEM SHALL BE GROUNDED IN ACCORDANCE WITH THE NEC AND ALL 18. ALL DISCONNECTS SHALL BE HEAVY DUTY RATED. LOCAL CODES AND ORDINANCES. GROUNDING AND BONDING SHALL COMPLY WITH ALL THE APPLICABLE REQUIREMENTS OF THE NEC.

13. USE THE FOLLOWING WIRING COLOR CODE: A. FOR WIRE SIZES 10 AWG AND SMALLER, INSTALL WIRE COLORS IN

ACCORDANCE WITH THE FOLLOWING: 120/208 277/480 PHASE A BLACK BROWN PHASE B RED ORANGE PHASE C BLUE YELLOW NEUTRAL WHITE GRAY GREEN GROUND GREEN SWITCH PINK/PURPLE PINK/PURPLE

EQUAL IN QUALITY AND FUNCTION.

FURNISH AND INSTALL, UNLESS OTHERWISE NOTED.

<sup>14.</sup> BURIED ELECTRICAL CONDUITS SHALL BE MARKED PER CODE REQUIREMENTS WITH UNDERGROUND WARNING TAPE 3" BELOW FINISHED GRADE. TAPE SHALL BE 4" WIDE COLORED RED WITH SUITABLE WARNING LEGEND PER ASMB A13.1.

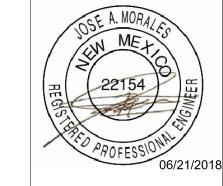
15. CONTRACTOR TO PROVIDE BLANK COVER FOR ALL J-BOXES AND WEATHERPROOF COVERS FOR J-BOXES IN WET LOCATIONS.

16. ENCLOSURES, BOXES AND COVERS ARE REQUIRED TO CONFORM TO ALL TEST PROVISIONS OF THE MOST CURRENT ANSI/SCTE77. WHEN MULTIPLE "TIERS" ARE SPECIFIED THE BOXES MUST PHYSICALLY ACCOMMODATE AND STRUCTURALLY SUPPORT COMPATIBLE COVER WHILE POSSESSING THE HEIGHT TIER RATING. ALL COVERS ARE REQUIRED TO HAVE THE TIER LEVEL RATING EMBOSSED ON THE SURFACE. IN NO ASSEMBLY CAN THE COVER DESIGN LOAD EXCEED THE DESIGN LOAD OF THE BOX. ALL COMPONENTS IN AN ASSEMBLY (BOX & COVER) ARE MANUFACTURED USING MATCHED SURFING TOOLING. INDEPENDENT THRID PARTY VERIFICATION OR TEST REPORTS STAMPED BY A REGISTERED PROFESSIONAL ENGINEER CERTIFYING THAT ALL TEST PROVISIONS OF THIS SPECIFICATION HAVE BEEN MET ARE REQUIRED WITH EACH SUBMITTAL. CONTRACTOR TO ENSURE EXACT LOCATION AND PLACEMENT OF BOXES AND COVERS AND PROVIDE THE RATING REQUIRED BY LOCAL AND NATIONAL CODES.

17. ELECTRICAL PANELS SHALL BE PANELBOARDS, HAVE COPPER BUSS, BOLTED CIRCUIT BREAKERS, KAIC RATING AS NOTED. PROVIDE TYPED AND LAMINATED COMPLETE SCHEDULE. MARKING IN COMPLIANCE WITH THE 2014 NEC 110.21, 110.22, 200.6(D), 210.5(C) AND 408.4.

19. EMERGENCY EGRESS LIGHTING TO COMPLY WITH 2009 IBC SECTION 106 AND 2014 NEC 700.12.

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PROJECT NO. 206-98

LIGHTING PLAN

SHEET TITLE

SHEET NO.

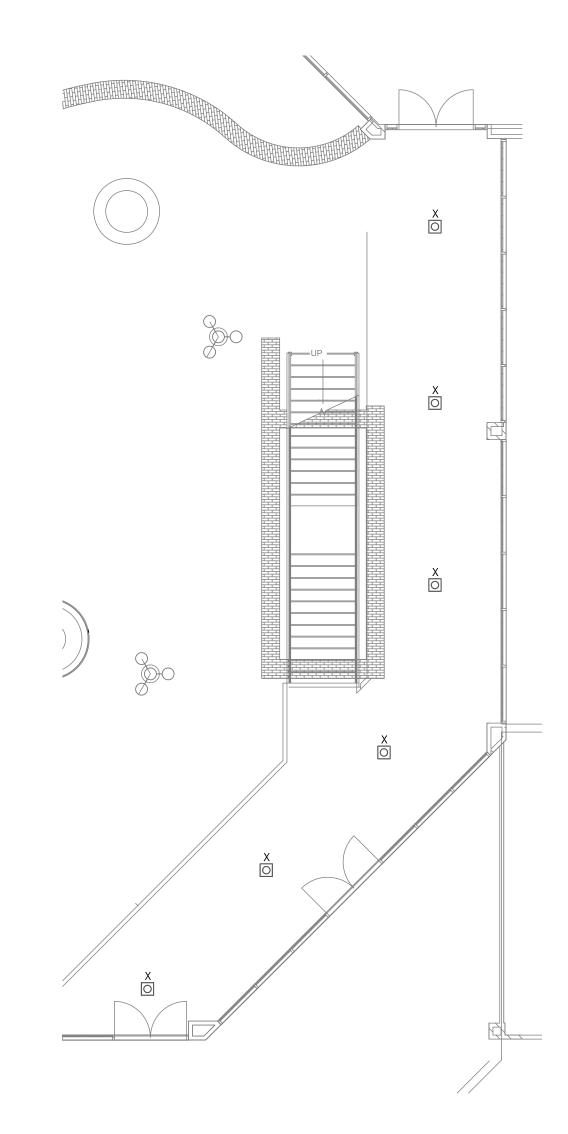
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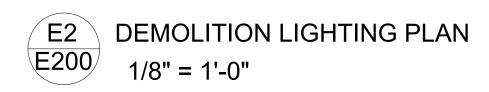
**PROJECT** 

NORTH

#### **DEMOLITION GENERAL NOTES:**

- 1. PRIOR TO BID SUBMISSION, THE CONTRACTOR SHALL VISIT THE SITE AND AREA OF WORK TO FAMILIARIZE WITH THE EXISTING CONDITIONS.
- 2. REMOVE ALL ELECTRICAL DEVICES TO INCLUDE BUT NOT LIMITED TO J-BOXES, CONDUIT, WIRING, HANGER STRAPS, HANGER SUPPORTS, SWITCHES, DISCONNECTS, PANELS, CIRCUIT BREAKERS. ALL DEMOLITION WORK IN NOT DETAILED ON THESE DRAWINGS. REMOVAL AND RELOCATION OF EXISTING ELECTRICAL WORK SHALL BE NEEDED FOR SATISFACTORY PERFORMANCE OF THIS AND OTHER TRADES.
- 3. THE INTENT OF THIS DRAWING IS TO RELATE THE GENERAL EXTEND OF DEMOLITION REQUIRE AND NOT TO INDICATE ALL DEVICES, REMOVALS, RECONNECTIONS OR ADDITIONAL WORK REQUIRED.
- 4. CONTRACTOR SHALL BE RESPONSIBLE FOR DISCONNECTING AND DISPOSING OF ALL ELECTRICAL EQUIPMENT, CONDUIT, WIRE, DEVICES, ECT. AS REQUIRED FOR A COMPLETE DEMOLITION. ALL FLUORESCENT LAMPS AND PCB BALLASTS SHALL BE DISPOSED OF IN ACCORDANCE WITH STATE ND FEDERAL REGULATIONS.
- 5. ALL CONDUIT NOT USED OR MADE OBSOLETE DURING DEMOLITION SHALL BE CUT BACK TO CEILING, WALL, OR FLOOR WITH THE REMAINING END PLUGGED TO ALLOW REFINISHING OF THE SURFACE. EXISTING CONDUIT THAT ARE IN WALL OR FLOORS WHICH ARE NOT REMAIN AND THE CONDUIT DOES NOT, AND WILL NOT INTERFERE WITH THE WORK OF ANY TRADE, MAY REMAIN. ALL ABANDONED WIRE SHALL BE REMOVED IN ITS ENTIRETY.
- 6. ALL WORK REQUIRED SHUT-DOWN OF EXISTING SYSTEM SHALL BE PERFORMED DURING OVERTIME HOURS, WITH OWNER'S APPROVAL, AT NOT ADDITIONAL COST TO THE OWNER. CONTRACTOR SHALL PLAN ND PERFORM WORK IN SUCH A WAY AS TO MINIMIZE THE OUTAGES AND SUBMIT TO THE OWNER A SCHEDULE THE REQUIRED OUTAGE.
- 7. REFER TO MECHANICAL AND PLUMING DRAWINGS FOR DEMOLITION/RELOCATION OF MECHANICAL OR PLUMBING EQUIPMENT. THE CONTRACTOR SHALL DISCONNECT AND REMOVE ALL CONDUIT, WIRE AND ASSOCIATED DEVICES RELATING TO HE EQUIPMENT REMOVED.
- 8. PRIOR TO INTERRUPTION FOR EXISTING FEEDERS OR PANELS, THE CONTRACTOR SHALL VERIFY, BY MEANS OF TRACING ALL EXISTING CIRCUITS, THAT ALL BRANCH CIRCUIT BEING FED FROM DEMOLISHED/RELOCATED FEEDERS ANA PANELS ARE NOT SERVING AREA TO REMAIN. WHERE NECESSARY, RECONNECT CIRCUITS TO CORRESPONDING NEW OR EXISTING TO REMAIN BRANCH CIRCUIT PANELS.
- 9. CONTRACTOR TO COORDINATE WITH OTHER TRADES FOR DEMOLITION OF FIRE ALARM DEVICES, INTRUSION DEVICES, CCTV DEVICES, PHONE/DATA DEVICES AND PA SYSTEM PRIOR TO COMMENCING DEMOLITION WORK.
- MATERIALS DURING DEMOLITION. CONTRACTOR SHALL COORDINATE WITH OWNER WHICH ITEMS AND/OR MATERIALS OWNER WISHES TO CLAIM AND REMOVE ALL ITEMS AND/OR MATERIALS NOT CLAIMED BY THE



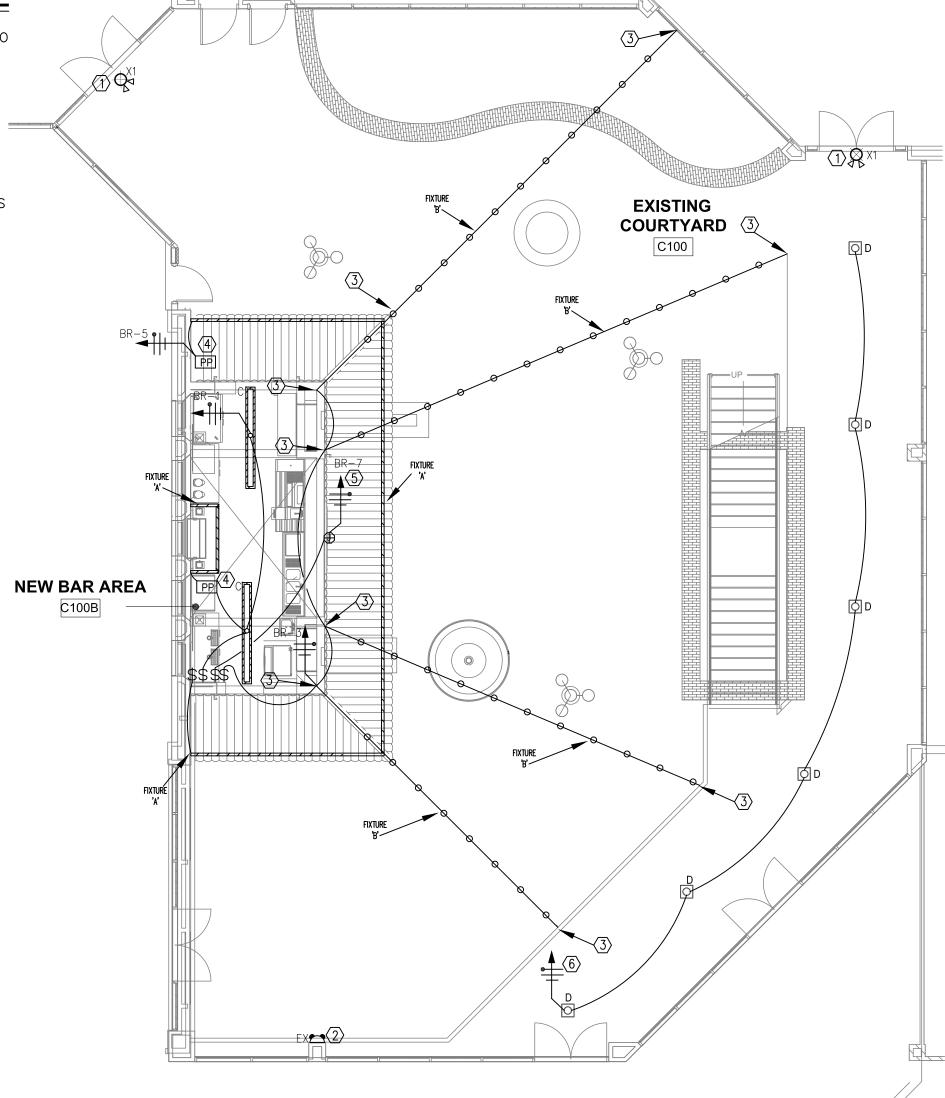


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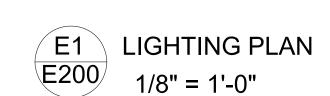
	OLITION ELECTRIC BOL LEGEND	CAL	
SYMBOL	DESCRIPTION	SYMBOL	
ΟX	EXISTING DOWNLIGHT FIXTURE TO BE DISCONNECT, REMOVED AND REPLACE.		

#### LIGHTING PLAN KEYED NOTES

- (1) CONNECT ALL EXIT LIGHTS AND EMERGENCY LIGHTS TO HOT LEG OF NEAREST LIGHTING CIRCUIT.
- (2) INSTALL OUTDOOR REMOTE EMERGENCY HEAD ABOVE DOOR, CONNECT AS SHOWN.
- (3) COORDINATE WITH ARCHITECT FOR MOUNTING REQUIREMENTS ON EXISTING STRUCTURE.
- PROVIDE AND INSTALL PSV 40 24 U2ND IP65
  TRANSFORMER ABOVE ACCESSIBLE CEILING. MAKE CONNECTIONS TO TAPE LIGHT FIXTURE 'A' IN COVE AS REQUIRED.
- (5) PROVIDE J-BOX ON BUILDING FACADE FOR SIGN. COORDINATE WITH ARCHITECT FOR EXACT LOCATION AND REQUIREMENTS.
- (6) CONNECT TO EXISTING EXTERIOR LIGHT CIRCUIT.





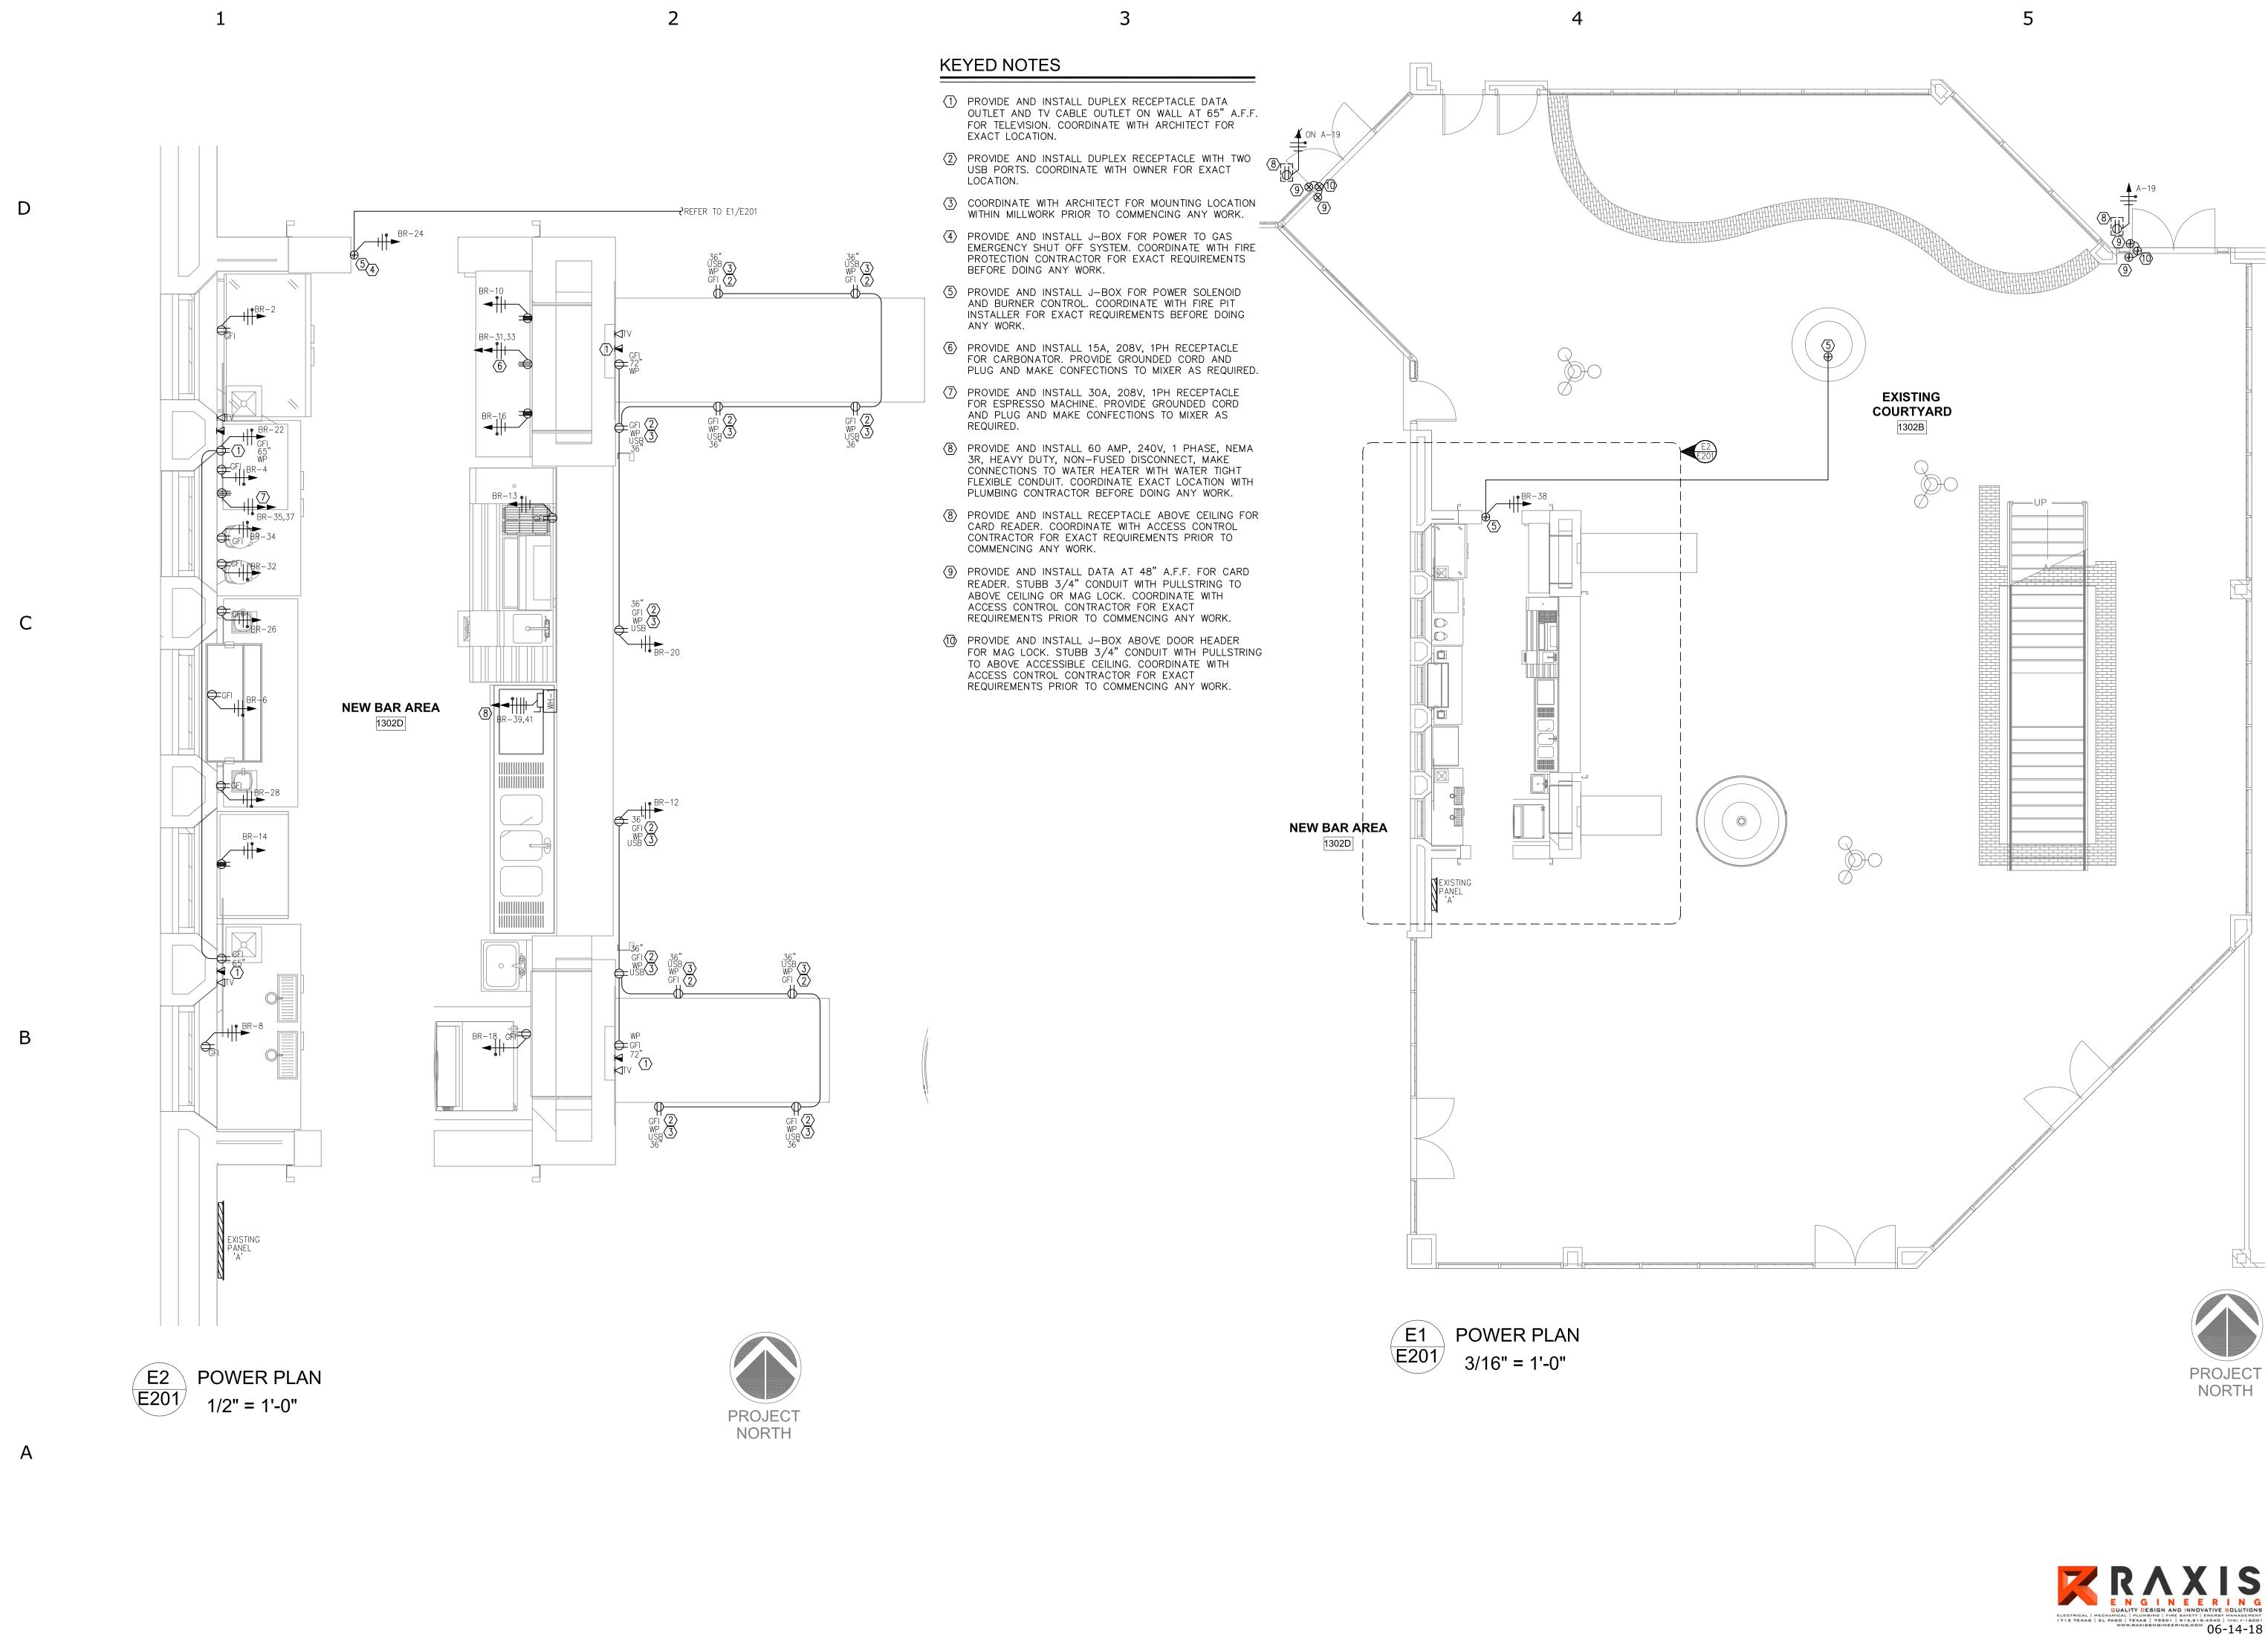


[2] REMOTE MOUNTED EMERGENCY HEAD, CONNECT TO INTERIOR EXIT SIGN.

[3] COORTINATE WITH ARCHITECT FOR EXACT LOCATION

	LIGHTING FIXTURE SCHEDULE									
TVDE	MANUEACTURER/MODEL NO			LAMP		601.00	MOUNTING	T <sub>NOTEC</sub>		
TYPE	MANUFACTURER/MODEL NO.	SUPPLY	QTY.	TYPE	TEMP.	COLOR	MOUNTING	NOTES		
Α	LUMINII LL18WET RGB LENGTH CLIPS EXTRUSION DRIVER	120V	1	3.9W/ FT.			SURFACE	[3]		
В	CELESTIAL HYA STL GC 24 (X) STL-MC (X) STL-CT	120V	1	2W LED EA			PENDANT	[4]		
С	CREE LS8 80L 40 10V	120V	2	88W LED			SURFACE	[3]		
D	LIGHTWAY BRCC-12-LED U 20 2 B99 WSP	120V	1	20W LED			SURFACE	[3]		
X1	MULE LIGHTING N4X-EPX-1-R-6-18-C-2S-IH(120V)-PK	120V		INCLUDED		WH	CEILING/WALL	[1]		
EX	MULE LIGHTING RLED-2-WP	120V	1	INCLUDED		WH	WALL	[2]		
NOTES:	[1] PROVIDE WITH 90 MIN. MINIMUM POWER LIFE BATTERY									

[4] CONTRACTOR TO COORDINATE WITH ARCHITECT FOR EXACT MOUNTING REQUIREMENTS TO EXISTING STRUCTURE.



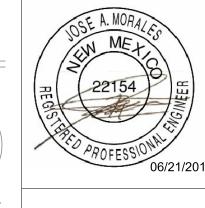
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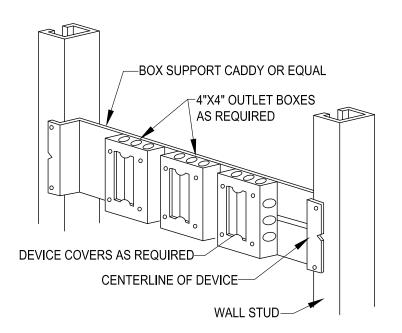
POWER PLAN



PROJECT NO. 206-98 SHEET TITLE


ELECTRICAL DETAILS

SHEET NO.



TYPOICAL FOR ALL OUTLET BOXES


### MULTIPLE OUTLET BOX DETAIL

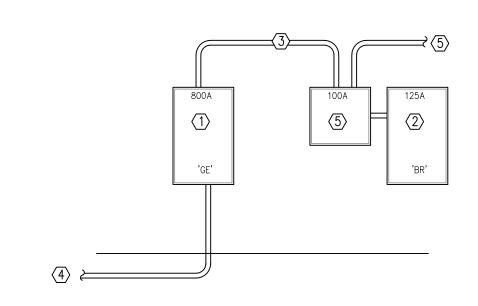


#### ELECTRICAL RISER DIAGRAM SCALE: N.T.S.

#### ELECTRICAL RISER DIAGRAM KEYED NOTES

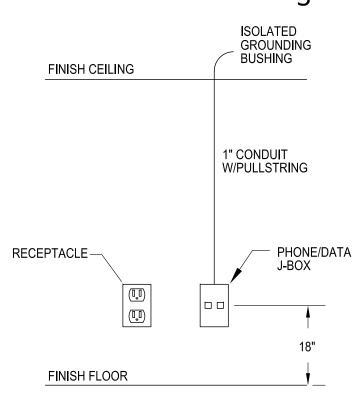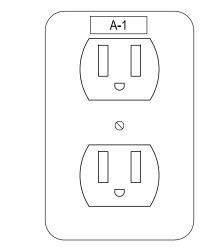- (1) EXISTING PANEL 'GE' 800A, 120/208V, 3PH TO REMAIN.
- (2) EXISTING PANEL 'BR' 125A, 120/208V 3PH TYPE 3R TO REMAIN. REFER TO PANEL SCHEDULE.
- (3) EXISTING 1 1/2" CONDUIT WITH 4-#2 THWN CU. CONDUCTORS AND 1-#8 CU. GROUND TO REMAIN.
- 4 TO 800A, 3POLE C.B. IN EXISTING PANEL 'DPLIB'
- (5) 100 AMP, 3 POLE, 600V, SHUNT TRIP BREAKER AT 12 KAIC WITH SHUNT TRIP ENCLOSURE, ENCLOSURE SHALL BE SIZE FOR SHUNT TRIP, HEDGE LOCKABLE DOOR COVER. SHUNT TRIP BREAKER SHALL BE CONTROL BY FIRE ALARM. COORDINATE WITH FIRE ALARM INSTALLER BEFORE DOING ANY WORK.
- (5) CONDUIT WITH PULLSTRING TO FIRE ALARM CONTROL PANEL. CONTRACTOR TO FIELD VERIFY EXACT LOCATION BEFORE COMMENCING ANY WORK.





### RECEPTACLE AND SWITCH LABEL TYPICAL FOR ALL

NOTE: PROVIDE WITH 1/8" BLACK LETTER WITH WHITE LABELS, INDICATING PANEL AND CIRCUIT FEEDING DEVICE.

A-1

TYP. PHONE/DATA BOX

						I	PANEL O	R LOAD	CENTER	- BR						
LOAD TYPE	CKT. NO.	DESCRIPTION	FEED CODE	AMPS	POLE	LOAD KVA	Α	В	С	LOAD KVA	POLE	AMPS	FEED CODE	DESCRIPTION	CKT. NO.	LOAD TYPE
LT	1	BAR LIGHTS		20	1	0.4	1.2			0.8	1	20		REFRIGERATOR OUTLET	2	RE
LT	3	MARKET LIGHTS		20	1	0.3		1.1		0.8	1	20		REFRIGERATOR OUTLET	4	RE
LT	5	BAR EAVE LIGHT		20	1	0.3			1.1	0.8	1	20		REFRIGERATOR OUTLET	6	RE
LT	7	SIGN		20	1	0.4	1.4			1	1	20		DRAFT BEER DISPENSER OUTLET	8	RE
	9	SPARE		20	1			0.8		0.8	1	20		WORK TABLE OUTLET	10	RE
	11	SPARE		20	1				0.8	0.8	1	20		BAR OUTLETS	12	RE
RE	13	COCKTAIL STATION		20	1	0.8	1.6			0.8	1	20		WORK TABLE OUTLET	14	RE
	15	SPARE		20	1			0.8		0.8	1	20		WORK TABLE OUTLET	16	RE
	17	SPARE		20	1				0.8	0.8	1	20		ICE MACHINE	18	RE
RE	19	CARD READER		20	1	0.4	1.2			0.8	1	20		BAR OUTLETS	20	RE
	21	SPARE		20	1			0.8		0.8	1	20		TVOUTLETS	22	RE
	23	SPARE		20	1				0.4	0.4	1	20		EMERGENCY SHUT OFF	24	ОТ
	25	SPARE		20	1		0.8			0.8	1	20		BLENDER	26	RE
	27	SPARE		20	1			0.8		0.8	1	20		BLENDER	28	RE
	29	SPARE		20	1				0		1	20		SPARE	30	
ОТ	31	CARBONATOR		20	2	0.6	1.2			0.6	1	20		ESPRESSO GRINDER	32	RE
ОТ	33	220V, 1PH		20		0.6		1.2		0.6	1	20		ESPRESSO GRINDER	34	RE
ОТ	35	ESPRESSO MACHINE		30	2	2.4			2.4		1	20		SPACE	36	
ОТ	37	240V, 1PH				2.4	2.4				1	20		SPACE	38	
ОТ	39	WH-1		60	2	4.8		4.8			1	20		SPACE	40	
ОТ	41	240V, 1PH				4.8			4.8		1	20		SPACE	42	
				TOT	AL KVA		9.8	10.3	10.3							
NELBO	DARD IN	IFORMATION		TOTA	L AMPS		81.7	85.8	85.8							
SIGNA	ATION	BR								_				kVA		
ALAL CI		100 ANAD				CONN	ECTED			DECINIC	LOAD		DUA	SF A 0.0		

PANELBOARD INFORMATION		TOTAL AMPS			81.7	85.8 85.8					
DESIGNATION	BR								_		kVA
MAIN SIZE	100 AMP		LOAD TYPE	CONNECTED		DESIGN FACTOR		DESING LOAD		PHASE A	9.8
MAIN TYPE	M.L.O.		LOAD TYPE	KVA	AMPS	DESIGN FACTOR	KVA	AMPS		PHASE B	10.3
VOLTS	120/208		LIGHTS	1.4	3.9	1.25	1.75	4.9		PHASE C	10.3
PHASE	3		RECETACLES	13.00	36.1	1.0	13.00	36.1			_
Wire	4		MOTOR	0.00	0.0	NEC	0.00	0.0		UNBALANCE %	4.85
AIC RATING	12 KAIC		AC	0.00	0.0	1.25	0.00	0.0			
NEMA TYPE	3R		KITCHEN	0.00	0.0	1.0	0.00	0.0			
MOUNTING	SURFACE		OTHER	16.00	44.5	NEC	16.00	44.5			
SERVED FROM	100 AMP, 3P, C.B. IN PANEL 'GE'.		TOTAL	30.40	84.5		30.75	85.5			

BASED UPON MAXIMUM BUILDING TRANSFORMI	
WITH UNLIMITED PRIMARY S.C. CURRENT (INFIN	IIY BUS)
ASSUMING BUILDING TRANSFORMER RATING =	50 KVA
TRANSFORMER IMPEDANCE (%Z)=	3.75 %
SECONDARY VOLTAGE =	208 VOLTS
SECONDARY PHASE=	3 PHASE
FLA = KVA X 1000 =	50 X 1000
E(I-I) X PHASE CORRECTION	208 X SQRT(3)
FLA = 138.79 AMPS	
100	
$MULTIPLIER = \frac{100}{3.75} = 26.67$	
SCA = AMPS X MULTIPLIER =	138.79 X 26.67
SCA = 3700 AMPS AT LOAD S	IDE OF TRANSFORMER

FA	AULT CURRI	ENT A	T MAIN	SERVIC	<u>E</u>	
SCA AT SECC LENGTH TO M "C" (WIRE CO # OF PARALLI	AIN SERVICE = NSTANT) =		3700 AM 200 FT 12844 4	PS		
CALCULATE "	F" FACTOR					
	ASE CORRECTION F PARALLEL WIRE:				OLTAGE L-I	_
F= 0.11 M= 0.89		M= _	1 1 + F			
NEW SCA =	SCA X M					

SCA AT MAIN SERVICE = 3303.745 AMPS

06-14-18

90 DEGREE ELBOW FLANGE CONNECTION BLIND FLANGE PLUMBING FIXTURE & DESIGNATION SEE FIXTURE CONNECTION SCHEDULE

- PLAN/DETAIL NUMBER - SHEET NUMBER PIPE DROP  $\longrightarrow$ PIPE RISE

 $\longrightarrow \bigcirc \longrightarrow$ 

\_\_\_\_

TEE FITTING - SIDE BRANCH CONNECTION TEE FITTING - BOTTOM BRANCH CONNECTION TEE FITTING - TOP BRANCH CONNECTION

CONCENTRIC REDUCER ECCENTRIC REDUCER

BALL JOINT EXPANSION JOINT FLEXIBLE CONNECTION (PIPE) FLOW DIRECTION

PIPE ANCHOR PIPING GUIDE NEW CONNECTION TO EXISTING

FIRE HYDRANT GAS PRESSURE REGULATOR GAS METER WATER METER

THERMOMETER

В

DOMESTIC WATER SUPPLY

SYMBOL DESCRIPTION PIPING TO BE REMOVED NEW COLD WATER PIPE \_\_\_\_\_ NEW HOT WATER (120°) \_\_\_\_\_ NEW HOT WATER RETURN (120°) HOT WATER @ 140°

<u>SA-1</u>

SHOCK ABSORBER SEE PLUMING FIXTURE CONNECTION SCHEDULE GENERAL PIPING SYMBOLS - VALVES

DESCRIPTION SYMBOL VALVE IN BOX BALL VALVE CHECK VALVE GATE VALVE PRESSURE & TEMP. RELIEF VALVE PETE'S PLUG (TYPICAL)

SANITARY SEWER/WASTE/VENT

REDUCED PRESSURE BACK FLOW PREVENTER

PRESSURE REDUCING VALVE

SYMBOL	DESCRIPTION
<del> </del>	CLEANOUT
$\neg$	FLOOR DRAIN & P-TRAP (RISER)
	FLOOR DRAIN, ROOF DRAIN, OR AREA DRAIN (SIZE & TYPE NOTED)
——————————————————————————————————————	HUB DRAIN & P-TRAP
	2-WAY COUNTERSUNK CLEANOUT PLUGS MOUNT IN CONCRETE PAD FLUSH WITH FINISHED GRADE
	SANITARY COMBINATION FITTING
	VENT PIPE (PLUMBING)
D	INDIRECT DRAIN
CD	CONDENSATE DRAIN
——Ø <u>co−1</u>	FLOOR CLEANOUT
RD	ROOF DRAINAGE
SRD	SECONDARY ROOF DRAINAGE
	NEW PIPING (WASTE, WATER, ETC)
<del>/*********</del>	PIPING TO BE REMOVED
	EXISTING PIPING (WASTE, WATER, ETC)(LIGHT LINES)
———EXIST—W ———	EXISTING WATER PIPE
———ESAN ———	EXISTING SANITARY SEWER PIPE
EV	EXISTING VENT PIPE
	NEW VENT PIPE

## NATURAL GAS

DESCRIPTION SYMBOL PIPING TO BE REMOVED EXISTING MED PRESS GAS PIPE ——EXIST-MG —— EXISTING LOW PRESS GAS PIPE ———EG ——— GAS (MEDIUM PRESSURE) GAS (LOW PRESSURE PRESSURE) PLUG VALVE

#### PLUMBING ABBREVIATIONS

BBREV.	DESCRIPTION	ABBREV.	DESCRIPTION
ABV	ABOVE	ID	INSIDE DIMENSION
AC	ABOVE CEILING	ΙE	INVERT ELEVATION (FLOW LINE)
AD	ACCESS DOOR	IN	INCHES
AFF	ABOVE FINISHED FLOOR	INSUL	INSULATION
AP	ACCESS PANEL		
		IN WG	INCHES OF WATER
APPROX	APPROXIMATE	KW	KILOWATT(S)
ARCH	ARCHITECTURAL	L	LONG, LENGTH
ASME	AMERICAN SOCIETY OF MECHANICAL ENGINEERS	L-#	LAVATORY - REF. PLUMB. FIXT. SCHEDULE
ASTM	AMERICAN SOCIETY FOR TESTING MATERIALS	<del>"</del>	POUND
		LB	
AV	ACID VENT	MAX	MAXIMUM
AW	ACID WASTE	MECH	MECHANICAL
BHP	BRAKE HORSEPOWER	MIN	MINIMUM
BLDG	BUILDING	MS	MOTOR STARTER
ВОР	BOTTOM OF PIPE		MOUNTED
		MTD	
BSMT	BASEMENT	NA	NOT APPLICABLE
BTU	BRITISH THERMAL UNIT	NIC	NOT IN CONTRACT
BW-#	BACKWATER VALVE	NTS	NOT TO SCALE
υ π		OC	ON CENTER
CA	COMPRESSED AIR		
CC	CENTER TO CENTER	ОН	OVERHEAD
CAP.	CAPACITY	PCT	PERCENT
CD	CONDENSATE		
CDP	CONDENSATE DRAIN PUMP	PLBG	PLUMBING
CI	CAST IRON	PRESS	PRESSURE
CLG	CEILING	PRV	PRESSURE REDUCING VALVE
CO	CLEANOUT	PSIG	POUNDS PER SQUARE INCH (GAUGE)
	CONNECTION		· · ·
CONN		PVC	POLYVINYL CHLORIDE
CONT	CONTINUATION	PW-#	PRESSURE WASHER - REF. PLUMB. FIXT. SCHED
CW	COLD WATER	RD	ROOF DRAIN
<b>Q</b>	CENTER LINE	REF: 4/P-500	REFER TO DETAIL 4, SHEET P-500
		REQ'D	REQUIRED
D	DRAIN		
DCO	DOUBLE CLEANOUT	RPBP-#	REDUCED PRESSURE BACKFLOW PREVENTER
DIA	DIAMETER	S-#	SINK - REF. PLUMB. FIXT. SCHEDULE
DN	DOMAI	SCHED.	SCHEDULE
DN.	DOWN	SD	STORM DRAIN
DN-#	DOWNSPOUT NOZZLE		
DWG	DRAWING	SEC	SECOND
	5100	SH-#	SHOWER HEAD — REF. PLUMB. FIXT. SCHED.
EA	EACH	SPEC	SPECIFICATION
EQ	EQUAL	SP	SUMP PUMP
EQUIP	EQUIPMENT	SRD	SECONDARY ROOF DRAIN
EXIST	EXISTING		
3" <u>FD-1</u>	3" FLOOR DRAIN TYPE 1	SS	SERVICE SINK/MOP SINK
		STD	STANDARD
F	DEGREES FAHRENHEIT	STL	STEEL
FC0	FLOOR CLEANOUT		
FIXT	FIXTURE	SW	SWITCH
		TEMP	TEMPERATURE
FF	FINISHED FLOOR	TP-#	TRAP PRIMER — REF. PLUMB. FIXT. SCHED.
FG	FINISHED GRADE		
FLG	FLANGE	TYP	TYPICAL
FLR	FLOOR	U-#	URINAL — REF. PLUMB. FIXT. SCHED.
		UF	UNDER FLOOR
FM	FACTORY MUTUAL	UG	UNDER GROUND
FPM	FEET PER MINUTE	UL	UNDERWRITERS LABORATORIES
FT	FEET, FOOT		
		UTIL	UTILITY
FS	FLOOR SINK	VB	VALVE BOX
GA	GAUGE	VCP	VITRIFIED CLAY PIPE
GAL	GALLON	VEL	VELOCITY
GALV	GALVANIZED	VOL	VOLUME
GCO	GROUND CLEANOUT	VOLT	VOLTAGE
GPH	GALLONS PER HOUR	VTR	VENT THRU ROOF
GPM	GALLONS PER MINUTE	W	WIDE, WIDTH
GW	GREASE WASTE	WB-#	WASHER BOX — REF. PLUMB. FIXT. SCHED.
GV	GREASE VENT	WD-#	WATER DEVICE - REF. PLUMB. FIXT. SCHED.
Н	HIGH, HEIGHT	•	
		W/	WITH
HB-#	HOSE BIBB — REF. PLUMB. FIXT. SCHED.	<b>W/</b> 0	WITHOUT
HP	HORSEPOWER	WC-#	WATER CLOSET - REF. PLUMB. FIXT. SCHED.
HR	HOUR	•	
		WCO	WALL CLEANOUT
HTR	HEATER	WD-#	WATERING DEVICE - REF. PLUMB. FIXT. SCHEDU
HWRP	HOT WATER RECIRCULATING PUMP	WH-#	WATER HEATER - REF. PLUMB. FIXT. SCHED.
	HERTZ	<i>"</i>	WATER SOFTENER - REF. SPECIFICATIONS
HZ		1875 17	WATER SUPTEMER - REE SPECIFICATIONS
HZ		WS-#	
HZ		w5-# WTD-#	WIDE TRENCH DRAIN — REF. PLUMB. FIXT. SCHEI

#### PLUMBING GENERAL NOTES

NOTE: FOR THE PURPOSE OF CLEARNESS AND LEGIBILITY, THE DRAWINGS ARE ESSENTIALLY DIAGRAMMATIC AND ALTHOUGH SIZES AND LOCATIONS OF EQUIPMENT ARE DRAWN TO SCALE WHEREVER POSSIBLE, THE CONTRACTOR SHALL MAKE USE OF ALL DATA IN ALL OF THE CONTRACT DOCUMENTS AND VERIFY THIS INFORMATION PRIOR TO ORDERING, FABRICATING OR INSTALLING ANY MATERIALS.

. THE PLUMBING SYSTEM DESIGN, INSTALLATION AND MATERIALS SHALL CONFORM TO ALL FEDERAL, STATE AND LOCAL CODES AND AUTHORITIES HAVING JURISDICTION. 5. PLUMBING QUALITY, WEIGHTS OF MATERIALS AND ALTERNATE METHODS OF CONSTRUCTION SHALL CONFORM TO THE APPLICABLE

PLUMBING CODES, WITH LOCAL JURISDICTION CODE AMENDMENTS. 4. CONTRACTOR SHALL COORDINATE ALL WORK SHOWN ON THESE DRAWINGS AND SPECIFICATIONS WITH ALL DISCIPLINES AND TRADES

PRIOR TO SUBMITTAL OF BID AND INSTALLATION OF SYSTEM. . CONTRACTOR SHALL VISIT SITE PRIOR TO BID TO VERIFY ALL EXISTING CONDITIONS, INCLUDE IN BID THE RELOCATION OF ALL EXISTING

UTILITIES THAT WILL OBSTRUCT NEW CONSTRUCTION. INCLUDE IN BID ALL DEVELOPMENT FEES, DEPOSITS, MEASURING DEVICE FEES, AND ALL OTHER FEES RELATED TO THE ESTABLISHMENT OF UTILITY SERVICES FOR THE NEW STRUCTURE. . CONTRACTOR SHALL MAKE ALL ARRANGEMENTS WITH UTILITY COMPANIES FOR SERVICE AND CONNECTIONS AND SHALL PAY FOR ALL

FEES, CHARGES, PERMITS AND METERS. . THE PLUMBING CONTRACTOR SHALL GUARANTEE ALL MATERIALS AND LABOR (INCLUDING THE COMPLETE PLUMBING SYSTEM) FOR A PERIOD OF ONE YEAR FROM WRITTEN ACCEPTANCE BY THE TENANT. ANY DEFECTS IN MATERIALS AND OR LABOR FOUND WITHIN THE

GUARANTEE PERIOD SHALL BE REMEDIED OR REPAIRED BY THIS CONTRACTOR IN A TIMELY FASHION, AT NO COST TO THE TENANT. 8. CONTRACTOR TO FIELD VERIFY INVERT ELEVATION OF EXISTING GREASE WASTE AND SANITARY SEWER BEFORE COMMENCING ANY WORK. 9. ALL PLUMBING FIXTURE LOCATIONS (WATER CLOSETS, LAVATORIES ETC.) ARE DIAGRAMMATIC. CONTRACTOR SHALL REFER TO FOOD

SERVICE AND ARCHITECTURAL DRAWINGS FOR EXACT PLACEMENT AND MOUNTING HEIGHTS. 10. ANY DEVIATIONS FROM THE DRAWINGS OR SPECIFICATIONS SHALL BE BROUGHT TO THE ATTENTION OF THE ARCHITECT AND ENGINEER PRIOR TO INSTALLATION.

11. CONTRACTOR SHALL VISIT SITE PRIOR TO SUBMITTAL OF BID AND FAMILIARIZE HIMSELF WITH EXISTING CONDITIONS. SUBMITTAL OF BID WILL VERIFY THAT THE CONTRACTOR HAS VISITED THE SITE.

12. PIPING SHALL BE INSTALLED PARALLEL TO BUILDING LINES AND SUPPORTED AND ANCHORED AS REQUIRED TO FACILITATE EXPANSION AND CONTRACTION. THE INSTALLATION SHALL MEET ALL CONSTRUCTION CONDITIONS AND ALLOW FOR THE INSTALLATION OF OTHER

13. SUPPORT PIPING WITH CLEVIS OR SPLIT RING TYPE PIPE HANGERS WITH 3/8" ALL THREAD ROD AND BEAM CLAMPS. "PLUMBERS TAPE AND WIRE" NOT PERMITTED. 14. TRAP PRIMERS FOR FLOOR DRAINS AND FLOOR SINKS AND WATER HAMMER ARRESTORS TO BE INSTALLED AS PER APPLICABLE

PLUMBING CODES, WITH LOCAL JURISDICTION CODE AMENDMENTS AND THE LATEST EDITION OF THE AMERICAN SOCIETY OF SANITARY ENGINEERING (ASSE 1010) SIZING AND INSTALLATION REQUIREMENTS. 15. ALL VALVES, TRAP PRIMERS, WATER HAMMER ARRESTORS OR OTHER EQUIPMENT SHOWN IN WALLS OR ABOVE NON-ACCESSIBLE

CEILINGS SHALL BE INSTALLED BEHIND AN ACCESS PANEL 16. ALL SERVICE WATER HEATING EQUIPMENT TO BE IN COMPLIANCE WITH THE APPLICABLE PLUMBING CODES, WITH LOCAL JURISDICTION

CODE AMENDMENT REQUIREMENTS AND LABELED AS SUCH. 17. ALL ITEMS PROJECTING THROUGH THE ROOF SHALL BE FLASHED THROUGH CURBS OR PIPE SEALS A MINIMUM OF 12" ABOVE THE

ROOF. THE PIPE CURBS AND SEALS SHALL BE INSTALLED BY THE ROOFING CONTRACTOR. ENSURE THAT AMPLE BOOT OPENINGS ARE PROVIDED TO ACCOMMODATE ANY ELECTRICAL CONDUIT PENETRATIONS REQUIRED FOR POWER. 18. CONTRACTOR SHALL PROVIDE: FAUCETS, TRAPS, STOPS, BALL VALVES, BACKFLOW DEVICES FOR KITCHEN EQUIP. GASCOCKS, WATER HAMMER ARRESTORS, CLEANOUT COVERS AND INDIRECT WASTE TO AN APPROVED RECEPTOR AND ALL NECESSARY TRIM FOR A

COMPLETELY CONNECTED PLUMBING SYSTEM. (SEE SCHEDULES). 19. ALL CLEANOUTS SHALL BE INSTALLED WHERE READILY ACCESSIBLE AND LOCATED AS PER CODE REQUIREMENTS. THE CONTRACTOR SHALL COORDINATE ALL CLEAN OUT LOCATIONS WITH EQUIPMENT, MILLWORK, ETC., PRIOR TO INSTALLATION.

20. ALL PLUMBING FIXTURE VENTS TO TERMINATE A MINIMUM OF 12 INCHES FROM ANY VERTICAL SURFACE AND 10'-0" FROM OR 3'-0" ABOVE ANY MECHANICAL EQUIPMENT OUTSIDE AIR INTAKE.

21. ALL VALVES, UNIONS, ETC. TO BE SAME SIZE AS CONNECTED SUPPLY LINE UNLESS OTHERWISE NOTED ON DRAWINGS. 22. UNIONS SHALL BE PROVIDED AND INSTALLED AFTER EACH SCREW-TYPE VALVE AND PRIOR TO EQUIPMENT CONNECTIONS.

23. PIPING SHALL BE INSTALLED COMPLETE WITH DIELECTRIC UNIONS BETWEEN CONNECTIONS OF NON-FERROUS MATERIALS. 24. PROVIDE DIELECTRIC INSULATION FOR COPPER PIPE ANYWHERE IT CONTACTS DISSIMILAR METAL. THIS INCLUDES THE WATER HEATER

25. PROVIDE ACCESSIBLE WATER SUPPLY STOP VALVE(S) AT EACH PLUMBING FIXTURE. 26. PROVIDE A LINE SIZED PRESSURE REDUCING VALVE AT THE BUILDING SERVICE CONNECTION SHOULD THE SUPPLY PRESSURE EXCEED

27. ALL UNDERGROUND METALLIC PIPE AND FITTINGS SHALL BE PROTECTED IN ACCORDANCE WITH THE SOILS ENGINEER'S

RECOMMENDATIONS. 28. NO PIPING SHALL BE DIRECTLY EMBEDDED IN CONCRETE, MASONRY WALLS, OR CONCRETE FOOTINGS.

29. THE PLUMBING CONTRACTOR SHALL COORDINATE ALL REQUIREMENTS FOR ALL POINTS OF CONNECTION WITH THE GENERAL CONTRACTOR AND OTHER TRADES PRIOR TO START OF WORK. 30. VERIFY EXACT LOCATIONS, DEPTH AND SIZE OF ALL PIPING TO WHICH CONNECTIONS ARE REQUIRED. COORDINATE ALL CONNECTIONS

WITH SITE CONDITIONS AND SITE UTILITY CONTRACTOR/ REPRESENTATIVE. 31. CONTRACTOR SHALL BE RESPONSIBLE FOR THE COMPLETE INSTALLATION OF ALL WORK RELATED TO PLUMBING UTILITIES INCLUDING:

TRENCHING, BACKFILL, SUPPORTS, CLEAN-OUT PADS, SERVICE VALVES AND BOXES, SERVICE LINES, TESTING, CLEANING, AND 32. ALL HORIZONTAL PIPING LINES EXTENDED AND CONNECTED TO EQUIPMENT SHALL BE RUN AT THE HIGHEST POSSIBLE ELEVATIONS AND

NOT LESS THAN 6" ABOVE THE FLOOR TO PROVIDE CLEARANCE FOR CLEANING. 33. ALL CUTTING OF EXISTING PAVING, WALKS AND/OR FLOORS SHALL UTILIZE MACHINE SAW CUTTING EQUIPMENT. HOLES FOR PIPES IN

CONCRETE WALLS OR FLOORS SHALL UTILIZE CORE DRILLING EQUIPMENT. COORDINATE WITH ARCHITECTURAL DETAILS FOR FLOOR CUTTING AND PATCHING.

34. THE PLUMBING CONTRACTOR IS TO PROVIDE ALL ADDITIONAL STEEL, HANGER MATERIALS, RODS AND CLAMPS AS REQUIRED FOR COORDINATION WITH WORK OF OTHER TRADES.

35. PIPING LAYOUT IS SCHEMATIC ONLY, EXACT ROUTING AND INSTALLATION OF PIPES TO BE COORDINATED WITH THE BUILDING STRUCTURE AND THE WORK OF OTHER CONTRACTORS. NO WATER OR DRAIN LINES ARE PERMITTED TO BE INSTALLED OVER OR UNDER ELECTRICAL PANELS.

36. NO LIQUID TRANSMISSION PLUMBING PIPING SHALL BE INSTALLED ABOVE ELECTRICAL SWITCH GEAR, EQUIPMENT, OR PANELS. MAKE ADJUSTMENTS NECESSARY TO REROUTE PIPING FOR ACTUAL INSTALLATION OF ELECTRIC EQUIPMENT. 37. WHENEVER FOUNDATION WALLS, EXTERIOR WALLS, ROOFS, ETC. ARE PENETRATED FOR THE INSTALLATION OF PLUMBING SYSTEMS, THEY

SHALL BE PATCHED TO MATCH EXISTING CONSTRUCTION AND SEALED WEATHER TIGHT. 38. ANY EXPOSED PIPING IN GUEST OR PUBLIC AREAS SHALL BE PAINTED TO MATCH THE WALL COLOR. ANY EXPOSED GAS PIPING IN KITCHENS SHALL BE PAINTED WHITE.

39. DURING THE PROGRESS OF THE WORK, MAINTAIN AN ACCURATE RECORD OF ALL CHANGES MADE IN THE PLUMBING SYSTEMS. THE RECORD DRAWING SHALL SHOW CHANGES IN MANUFACTURER (WITH NUMBERS AND TRADE NAMES). MATERIALS, SIZES, LOCATIONS AND

HOOK-UP POINTS. AS-BUILTS SHALL BE GIVEN TO OWNER'S CONSTRUCTION MANAGER AT COMPLETION OF JOB. 40. UPON COMPLETION OF JOB, THIS CONTRACTOR SHALL INSPECT ALL EXPOSED PORTIONS OF THE PLUMBING INSTALLATION AND COMPLETELY REMOVE ALL EXPOSED LABELS, SOIL, MARKINGS AND FOREIGN MATERIAL EXCEPT PRODUCT LABELS AND THOSE REQUIRED

41. PLUMBING CONTRACTOR SHALL BE ON SITE AND PRESENT AT THE DATE OF THE PROJECT TURNOVER.

42. PLUMBING CONTRACTOR SHALL PROVIDE MANUFACTURER'S OPERATION LITERATURE FOR ALL INSTALLED EQUIPMENT AND FIXTURES AT THE DATE OF PROJECT TURNOVER.

43. ALL PLUMBING FIXTURES SHALL MEET AND BE INSTALLED AT DIMENSIONS REQUIRED BY ACCESSIBILITY STANDARDS FOR HANDICAPPED PERSONS. 44. ANY PLASTIC PIPING (PVC PIPE) LOCATED IN A RETURN CEILING SPACE (OPEN CEILING) OR PLENUM SHALL BE ENCLOSED IN GPB OR

WRAPED WITH 3M FIREMASTER BLANKET OR UL910 STANDARD COVER.

45. ALL UNDERGROUND WATER PIPING SHALL BE SOFT COPPER PIPING. THERE SHALL NOT BE ANY UNDERGROUND JOINT FITTINGS. 46. ALL DENTAL SPECIALTY PIPING SHALL BE COPPER PIPING.

47. DENTAL SPECIALTY PIPING SHALL BE INSTALLED BY A CERTIFIED MED GAS INSTALLER WITH 5 YEARS EXPERIENCE. 48. ALL PIPING IN FINISHED ROOMS OR SPACES SHALL BE CONCEALED IN FURRED CHASES OR INSTALLED ABOVE SUSPENDED CEILING

49. ALL FLOOR BRANCHES OFF PIPE RISERS SHALL BE PROVIDED W/ SHUT OFF VALVES AND CAPPED DRAIN CONNECTION.

50. INSULATED PIPEWORK SHALL BE INSTALLED SO THAT FULL THICKNESS INSULATION CAN BE APPLIED TO EACH PIPE.

51. ALL PIPING INSTALLED ON THE ROOF MUST BE SUPPORTED, WITH PIPE SUPPORTS EVERY 10'-00". PIPE SUPPORT TO BE DURA-BLOCK, CONTRACTOR TO PROVIDED SIZED AND ACCESSORIES REQUIRED.

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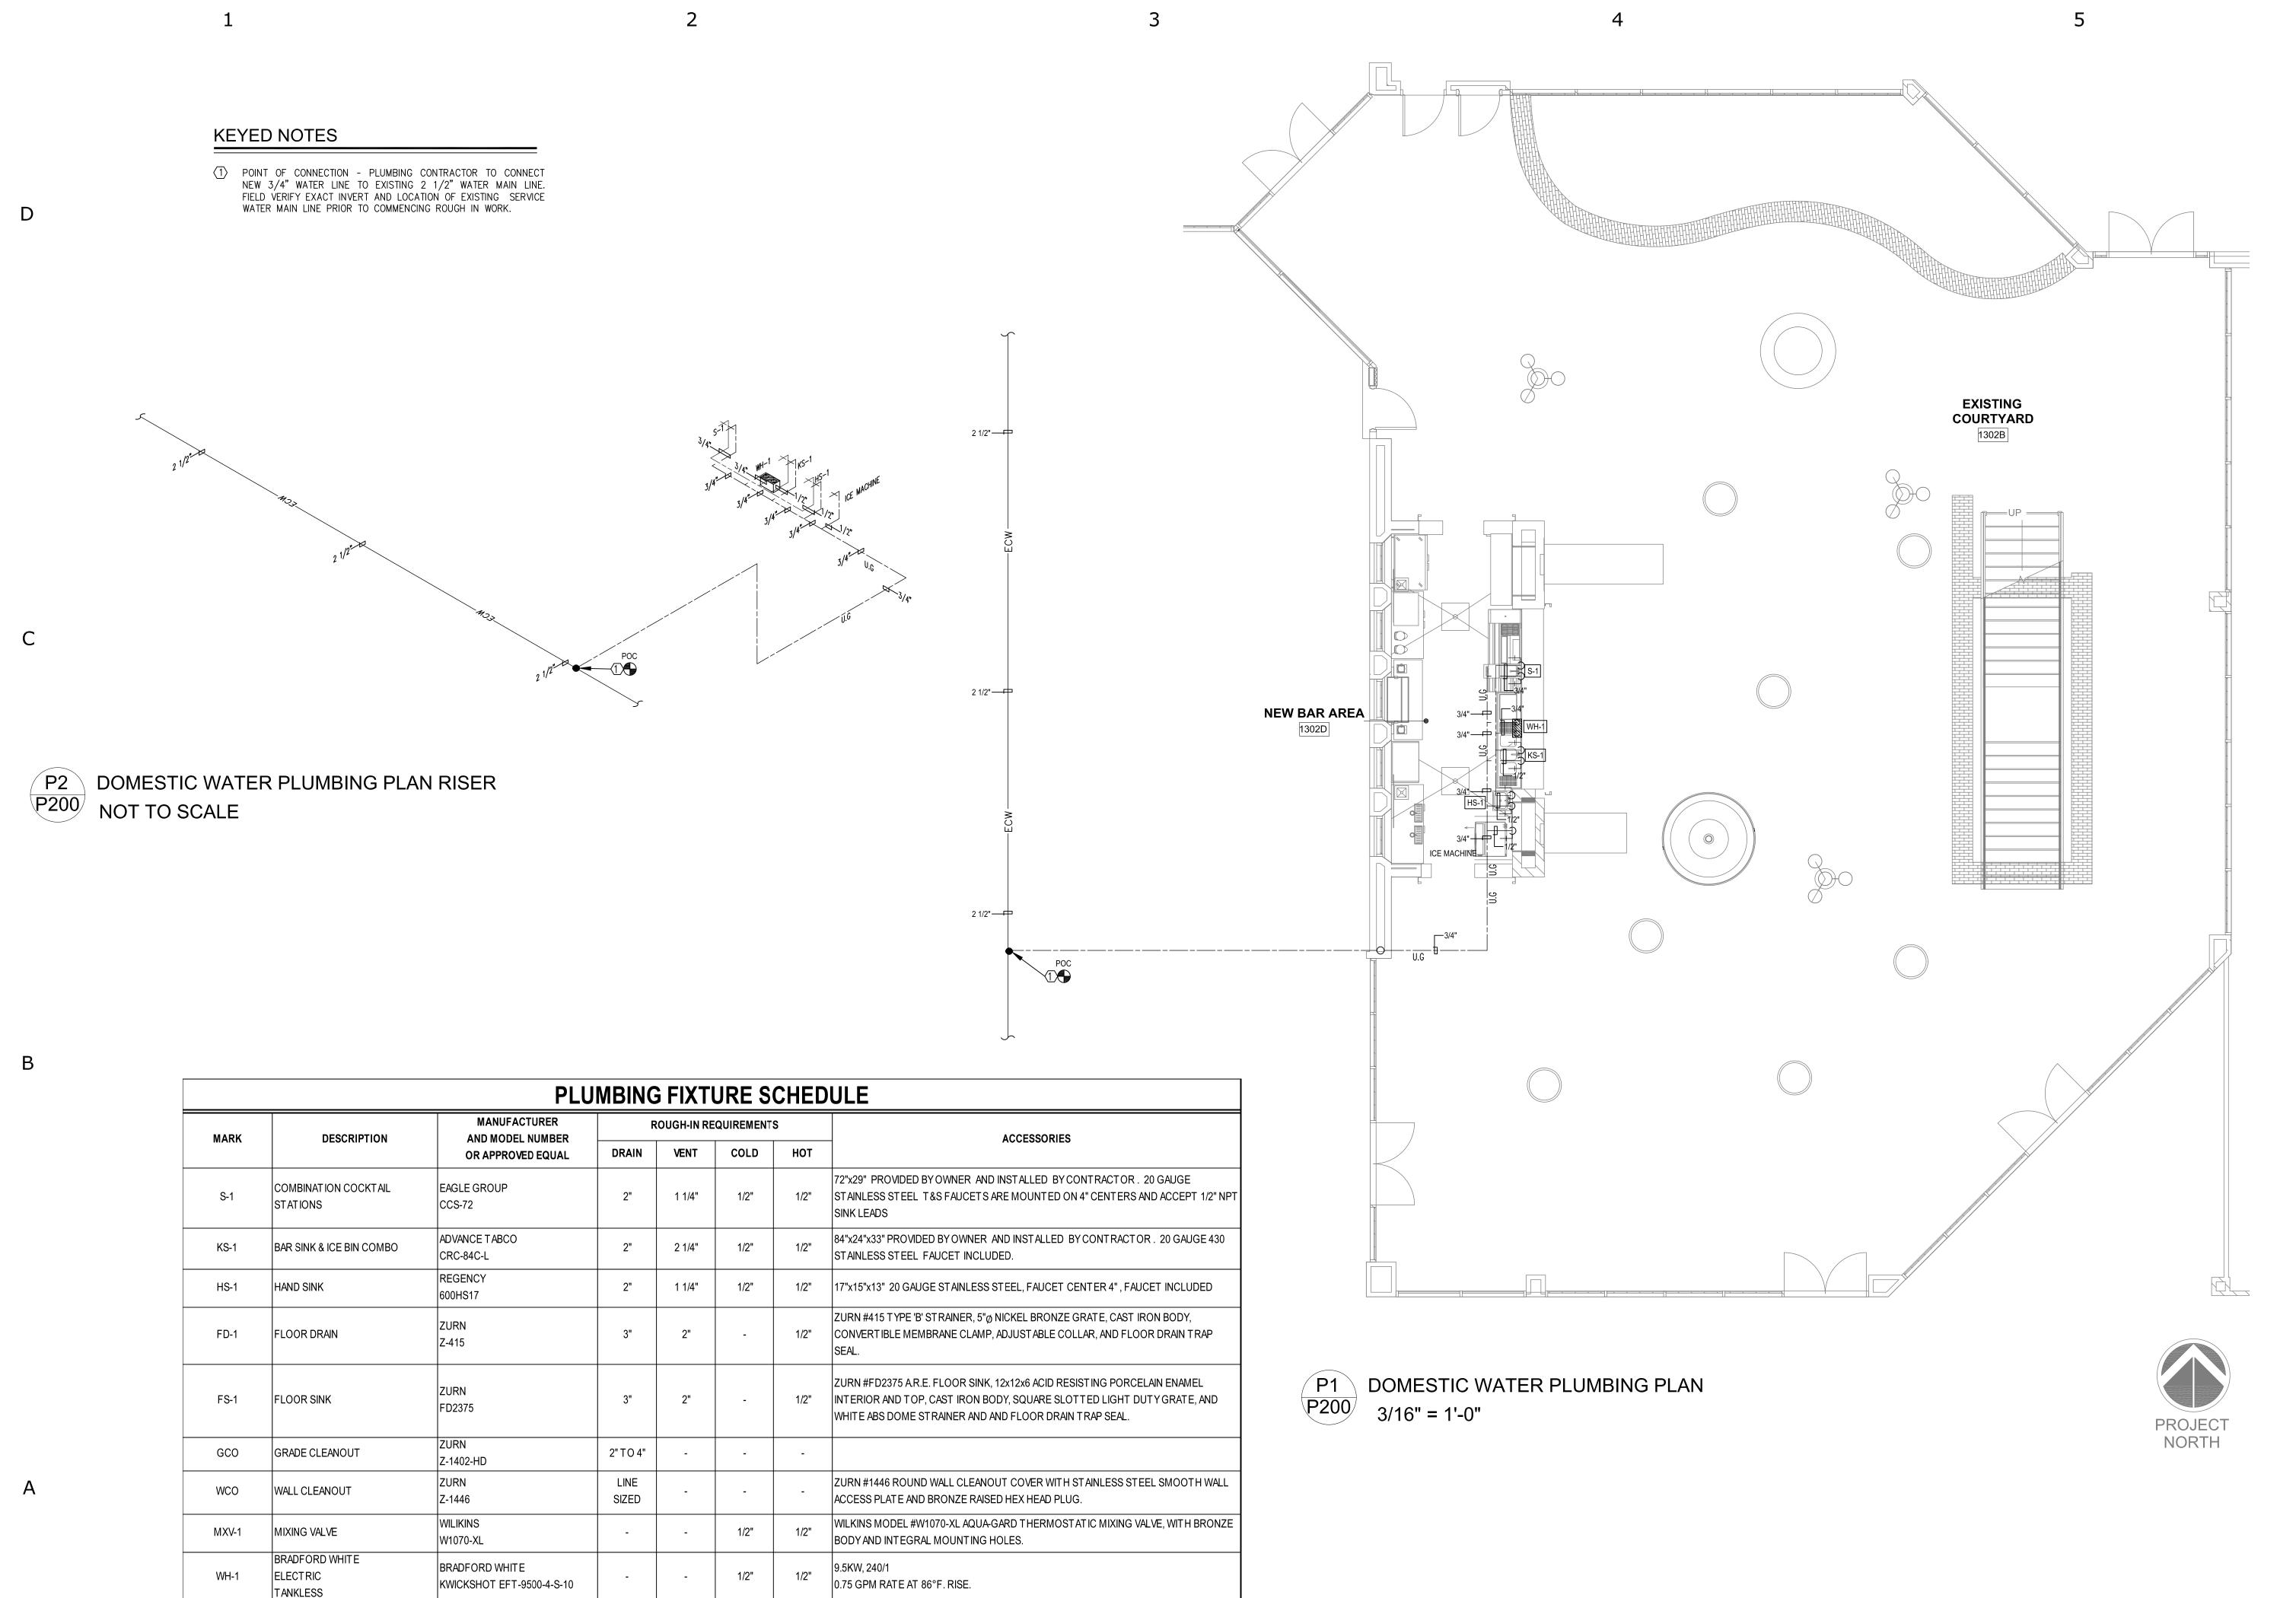
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PROJECT NO. 206-98

SHEET TITLE

PLUMBING GENERAL





CORBETT COURTYARD BAR
CORBETT CENTER STUDENT UNION
LAS CRUCES, NM. 88003

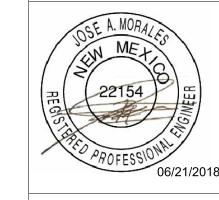
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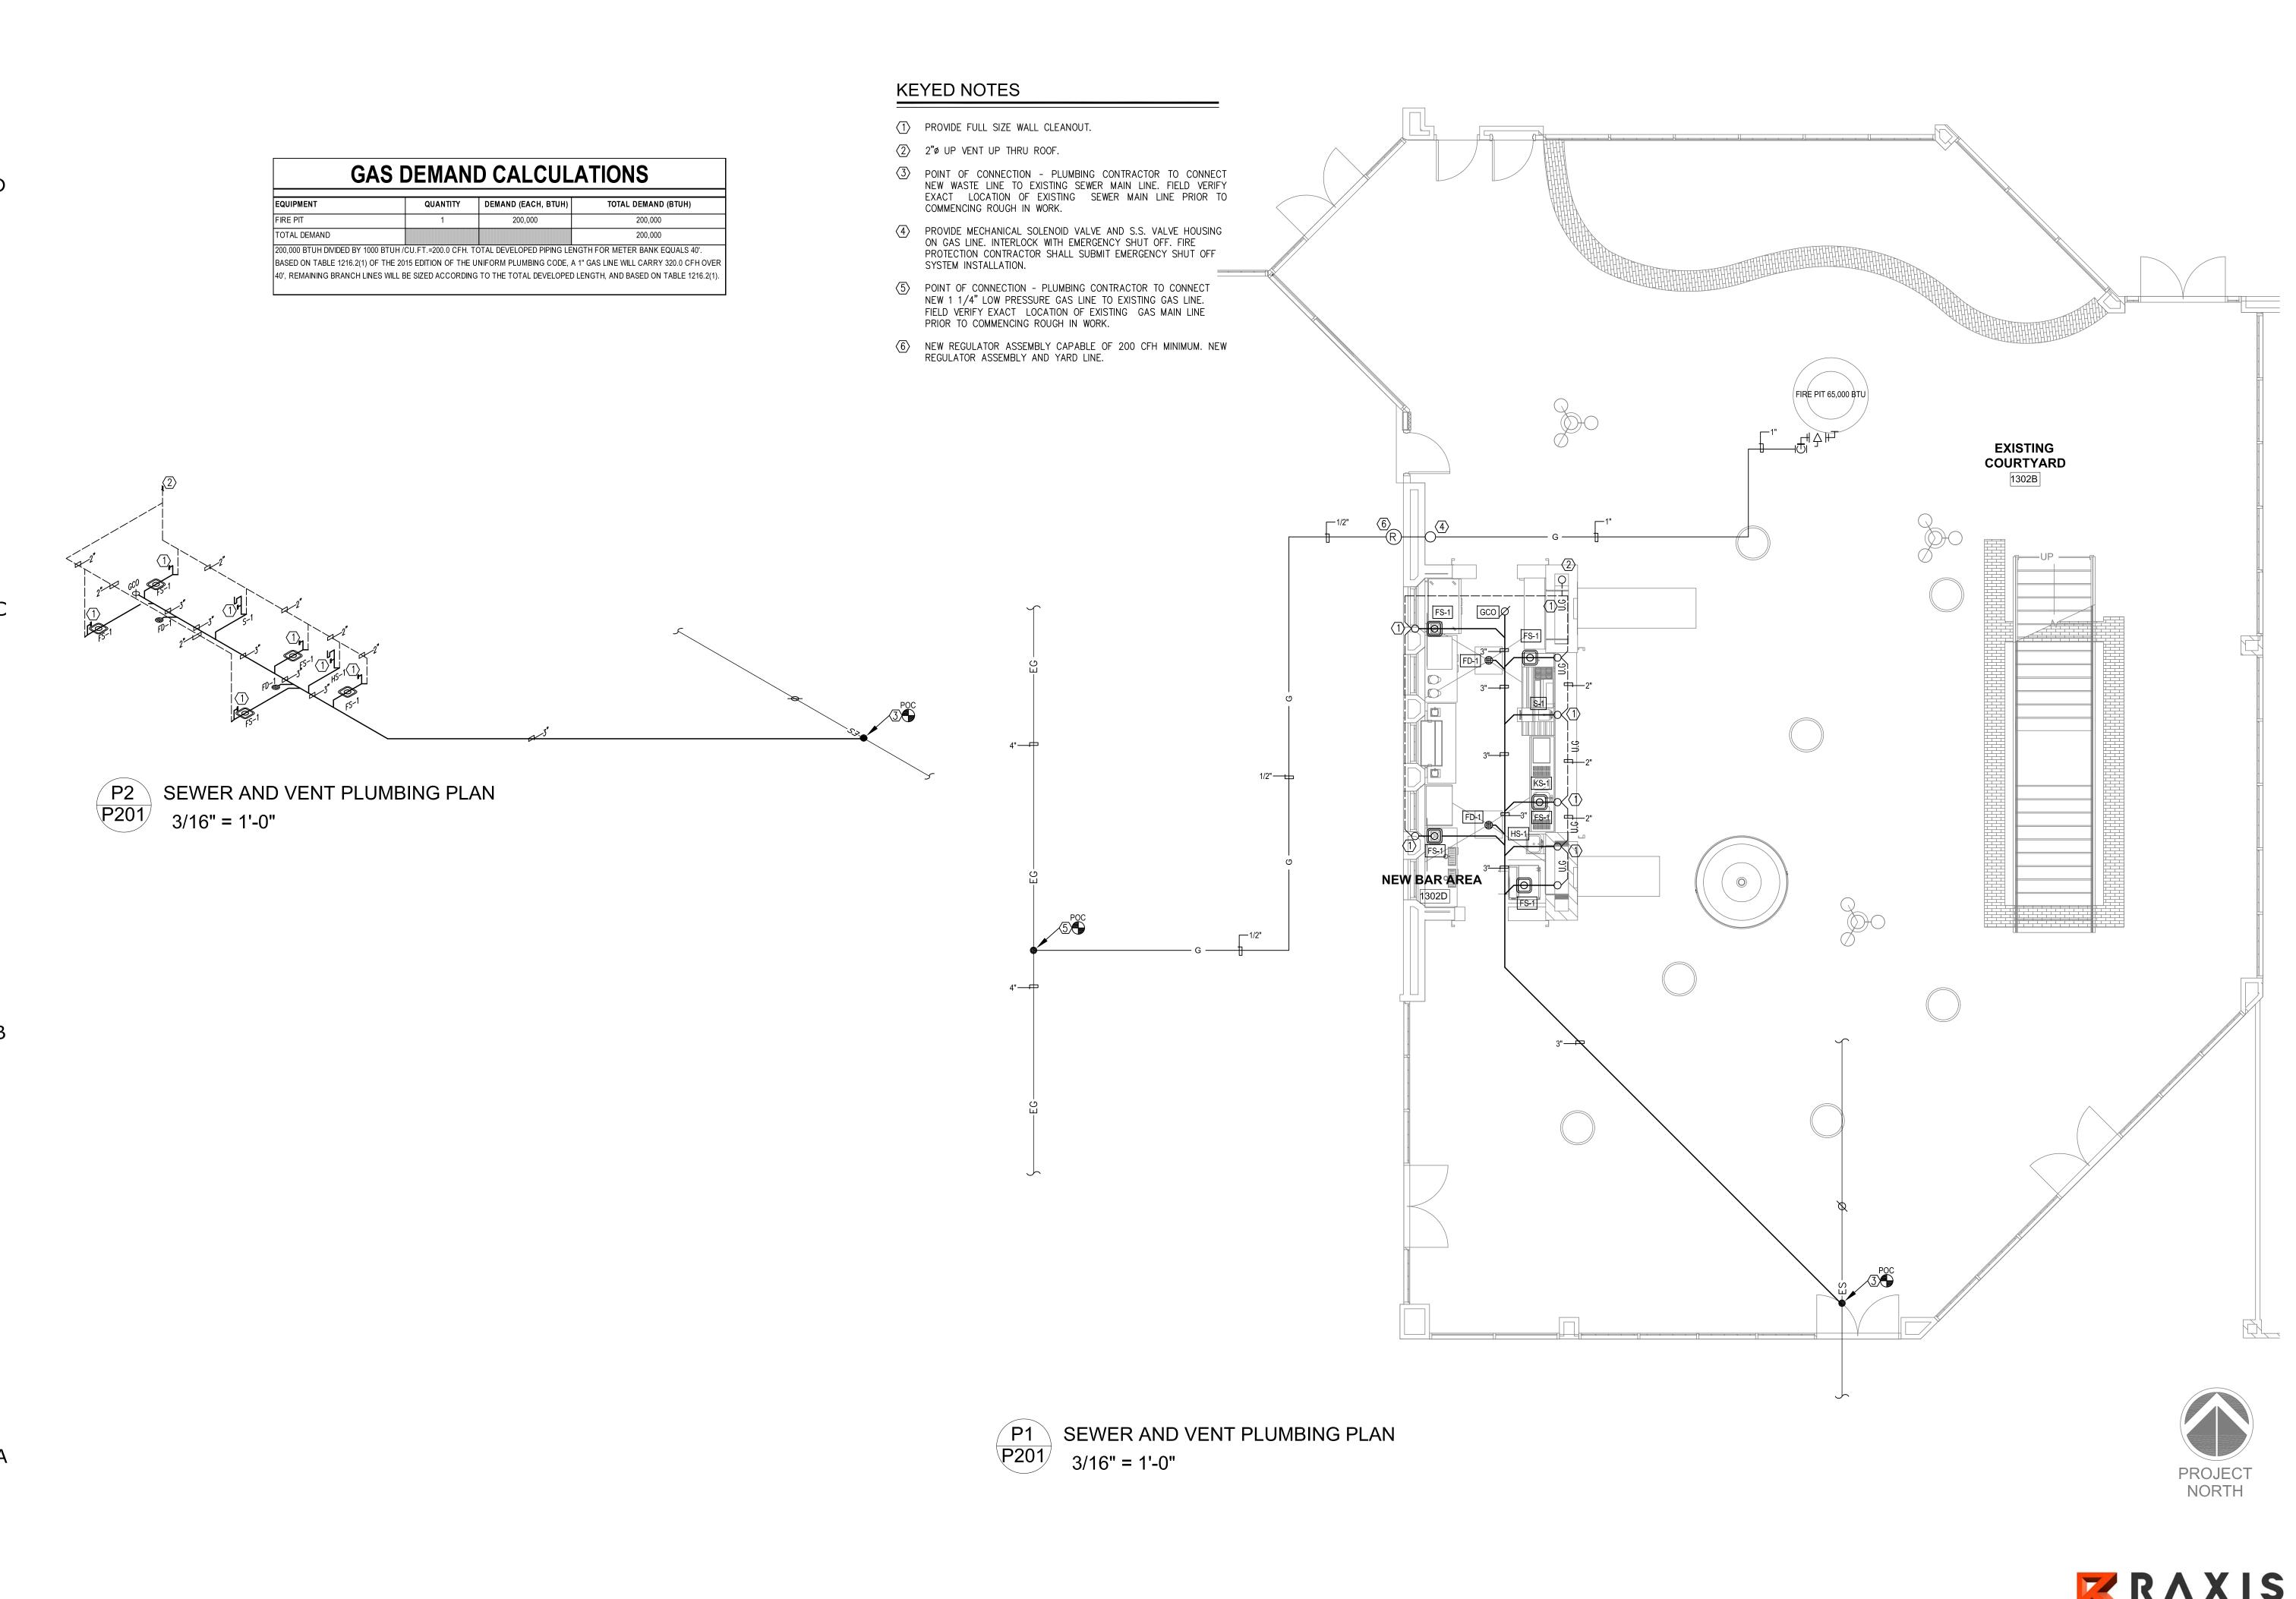
PROJECT NO. 206-98

DOMESTIC WATER PLUMBING PLAN

SHEET NO.



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PROJECT NO. 206-98

SEWER AND VENT PLUMBING PLAN

SHEET NO.


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PROJECT NO. 206-98 SHEET TITLE

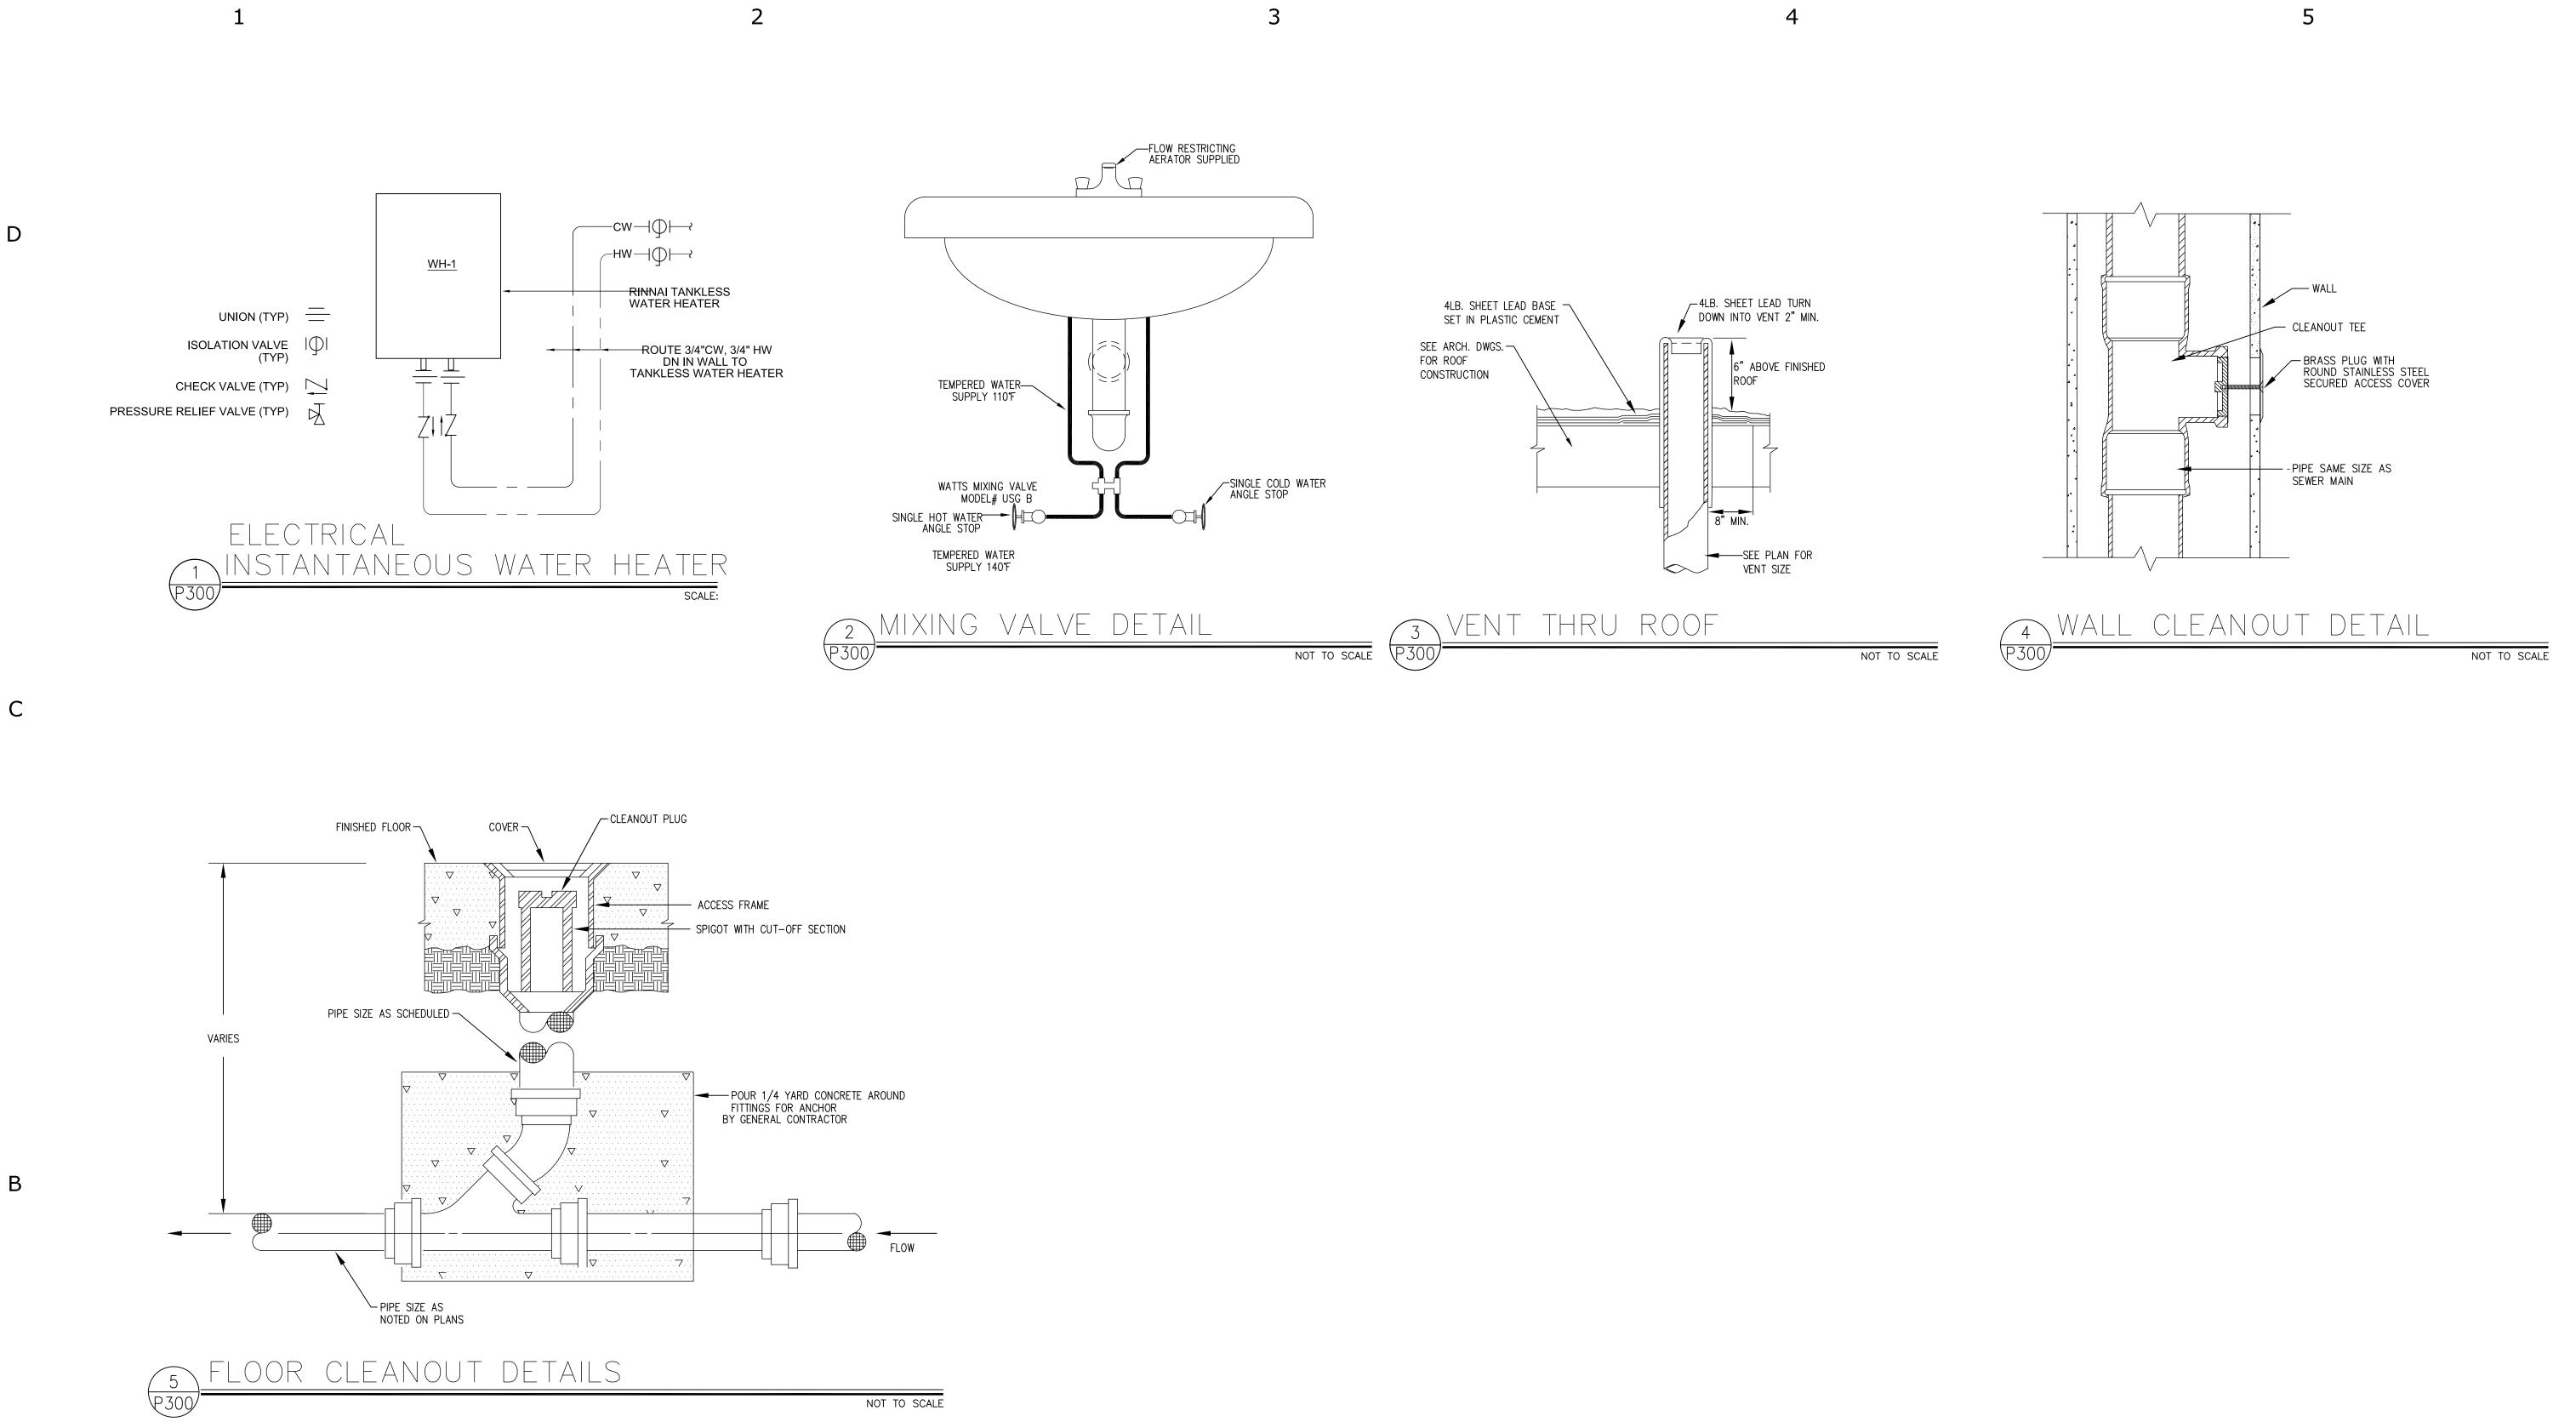PLUMBING DETAILS

