

24'X32' 3 CAR GARAGE POLE BARN STYLE FRAME

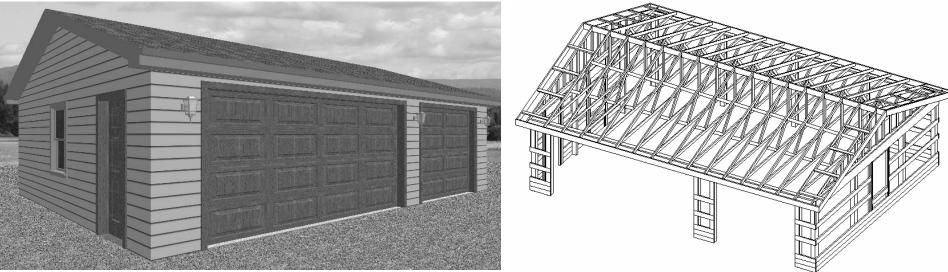

•3' ENTRY DOOR
•2 WINDOWS, 1 @ EA. END
•1-16'X7' GARAGE DOOR
•1-9'X7' GARAGE DOOR
•4" CONCRETE SLAB


•8' WALLS •4/12 PITCH SHINGLED ROOF •VINYL OR ALUMINUM SIDING

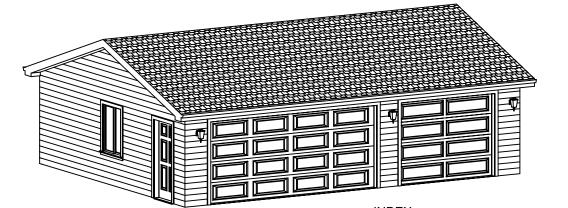



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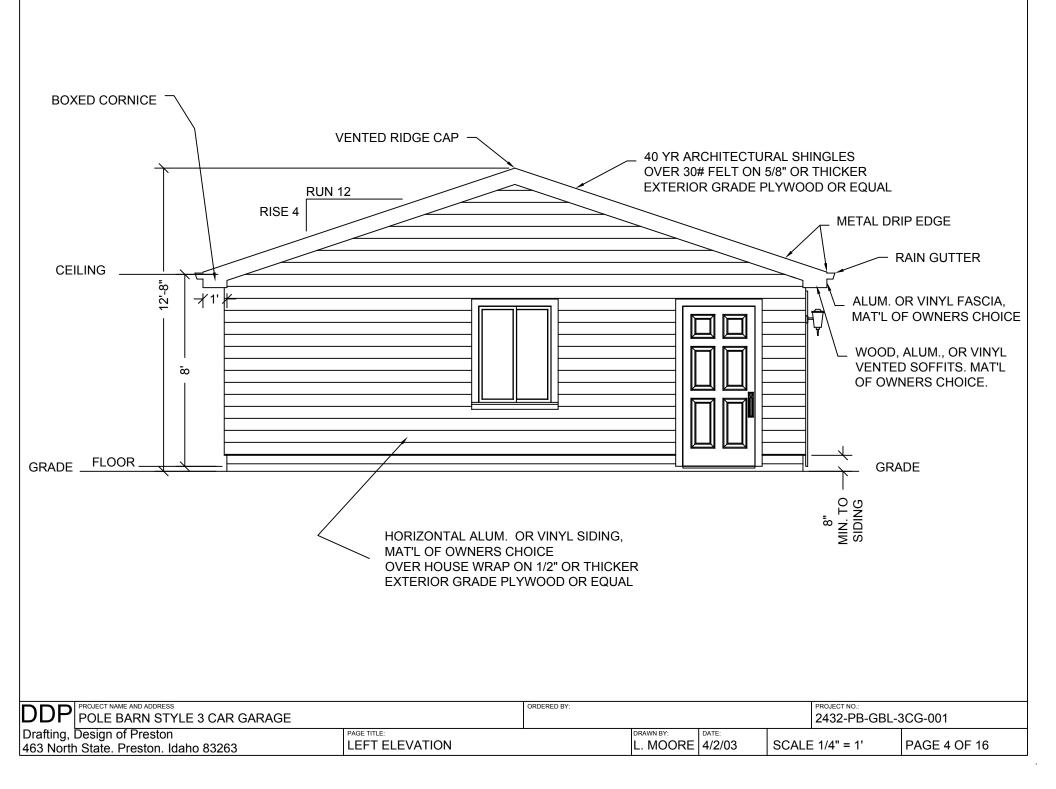
- PAGE DESCRIPTION
- 1 FRONT ELEVATION
- 2 RIGHT ELEVATION
- 3 BACK ELEVATION
- 4 LEFT ELEVATION
- 5 FLOOR PLAN
- 6 ELECTRICAL PLAN
- 7 SECTION A-A
- 8 SECTION B-B
- 9 SECTION C-C, D-D, H1 DETAIL, APRON SECTION
- 10 POLE DETAILS
- 11 DOORWAY FRAME DETAILS, SECTIONS H-H, J-J
- 12 SECTIONS E-E, F-F, G-G WINDOW FRAME ELEVATION DETAIL
- 13 OPTIONAL POLE FOOTING DETAILS
- 14 FRAME PICTORIAL, DOOR & WINDOW SCHEDULE
- 15 SPECIFICATIONS
- 16 BILL OF MATERIALS


DP PROJECT NAME AND ADDRESS POLE BARN STYLE 3 CAR GARAGE						PROJECT NO.: 2432-PB-GBL-3CG-001		
Drafting, Design of Preston 463 North State. Preston. Idaho 83263	PAGE TITLE: TITLE PAGE		drawn by: L. MOORE	DATE: 4/2/03	SCALE	ENTS	PAGE OF	



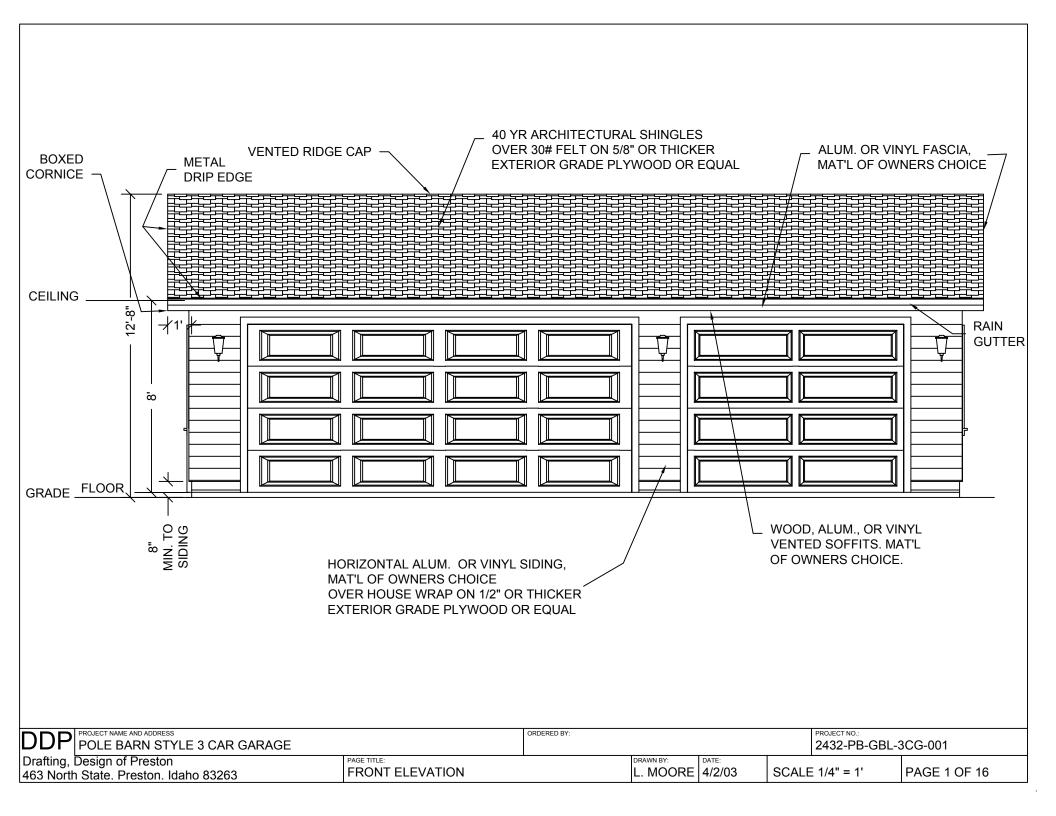


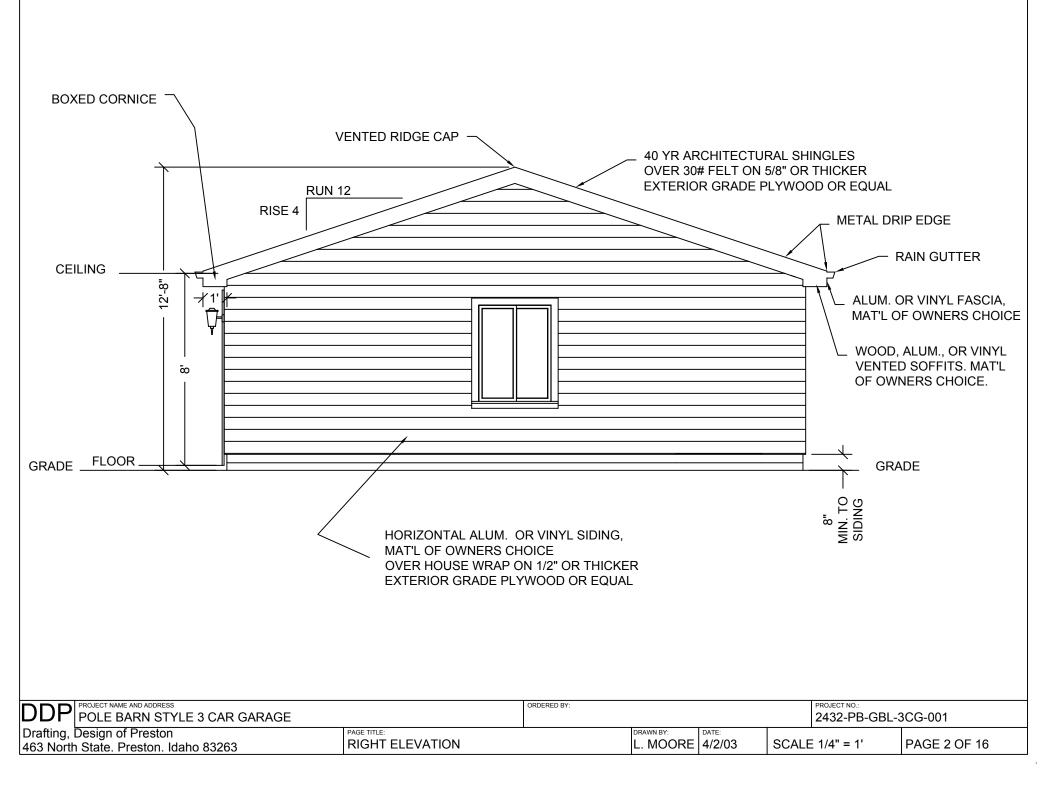


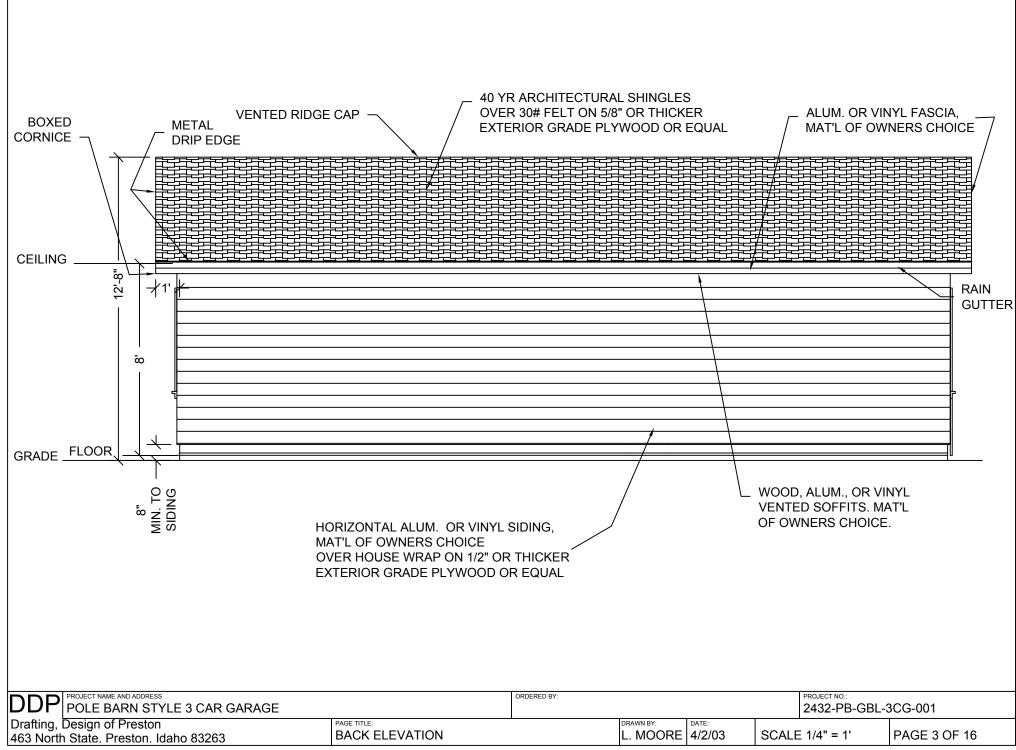


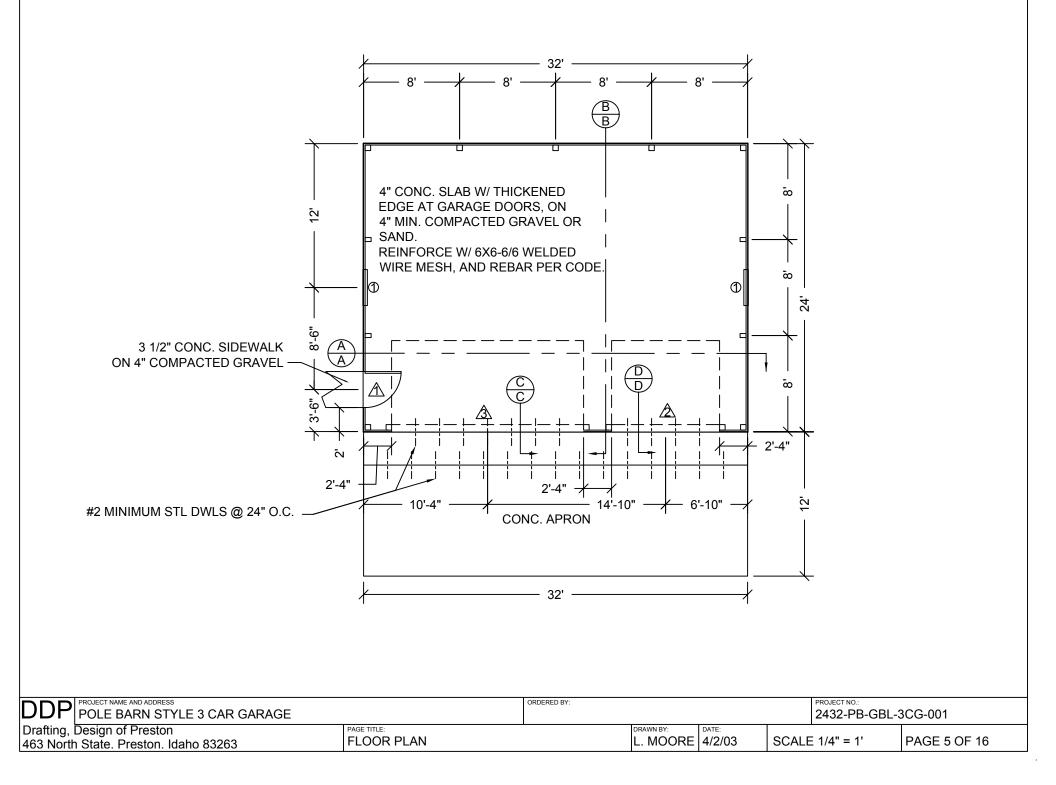


	LEGEND						
Ð	DUPLEX CONVENIENCE OUTLET						
€ ^{WP}	WEATHERPROOF DUPLEX OUTLET						
•	CEILING MOUNT OUTLET						
\$	SWITCH	Note					
o	GARAGE DOOR OPENER SWITCH	NOTE: 1. MOUNT CONV	ENIENCE OUTLE	S @ OWNER D	DESIGNA	TED DISTANCE ABC	VE FLOOR.
-¢-	CEILING LIGHT FIXTURE, OWNERS CHOICE	3. MOUNT SWIT	CHES @ OWNER	DESIGNATED D	ISTANC	NATED DISTANCE A E ABOVE FLOOR.	
<u>ل</u>	WALL MOUNT LIGHT FIXTURE, OWNERS CHOI	4. CONVENIENC	E AND WEATHER	PROOF OUTLE	TS SHAL	L BE ON GFCI CIRCI	UITS.
	BREAKER BOX						
DDP	PROJECT NAME AND ADDRESS POLE BARN STYLE 3 CAR GARAGE		ORDERED BY:			PROJECT NO.: 2432-PB-GB	8L-3CG-001
Jrafting,	Design of Preston			DRAWN BY: L. MOORE 4/2	[™] E: 2/03	SCALE 1/4" = 1'	PAGE 6 OF 16

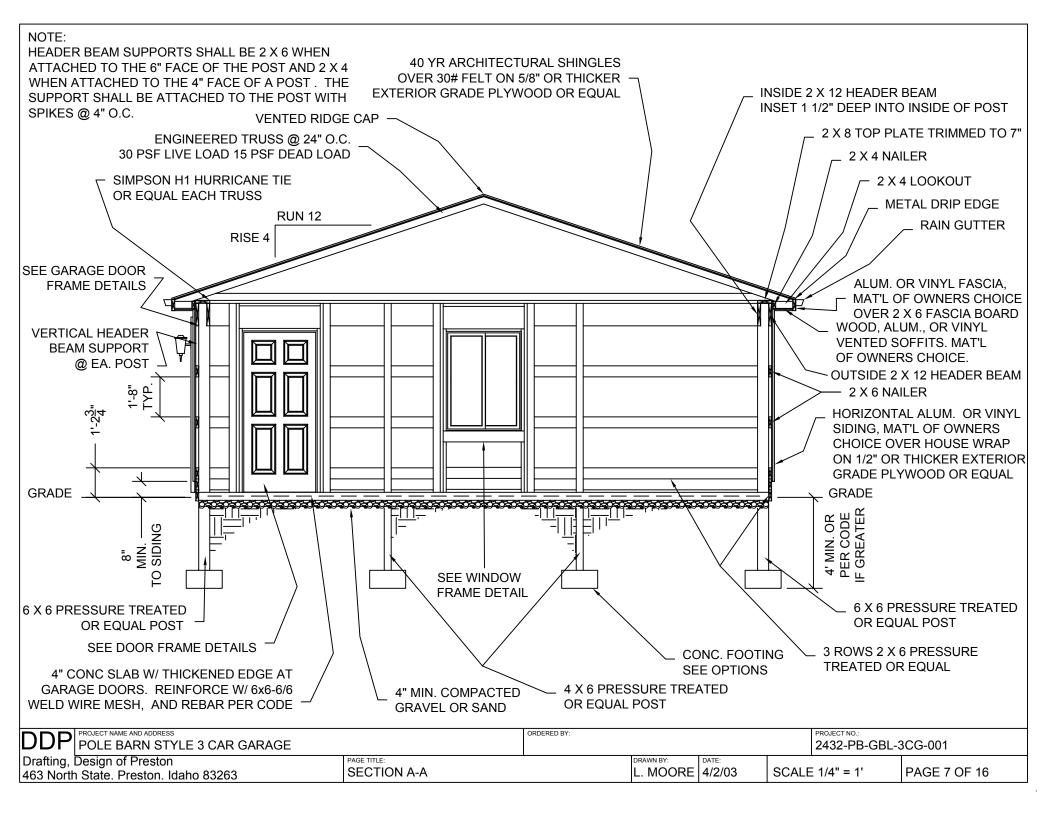


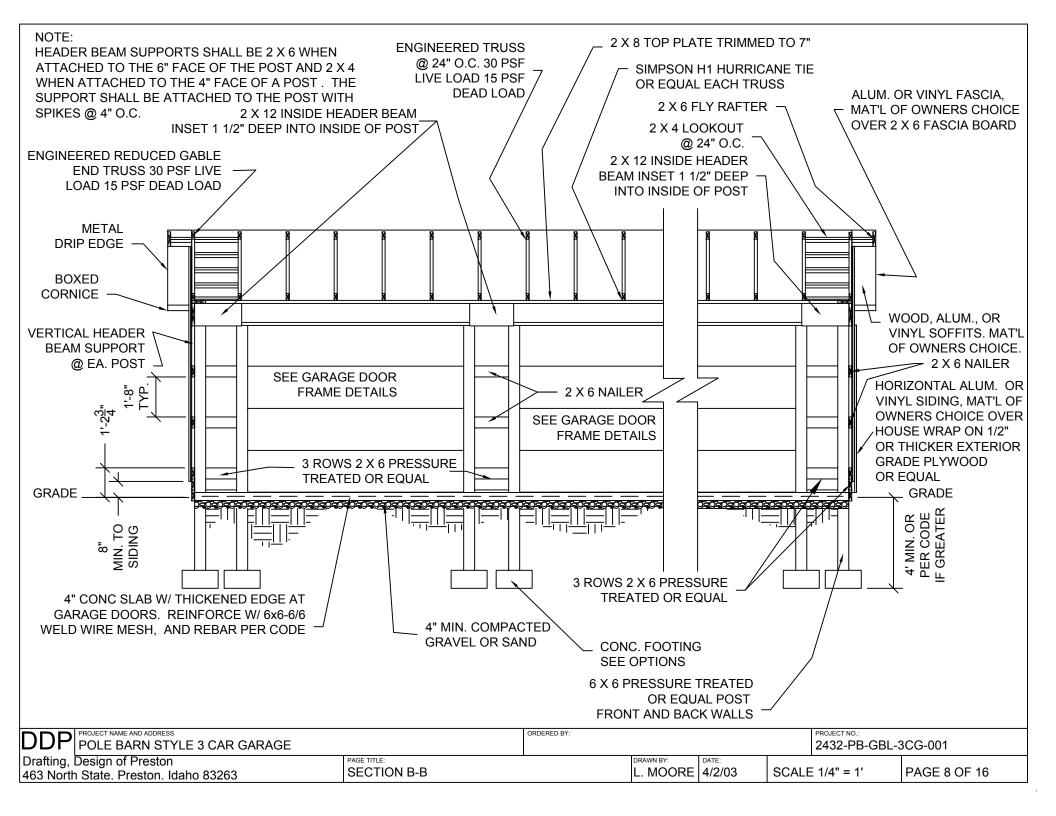


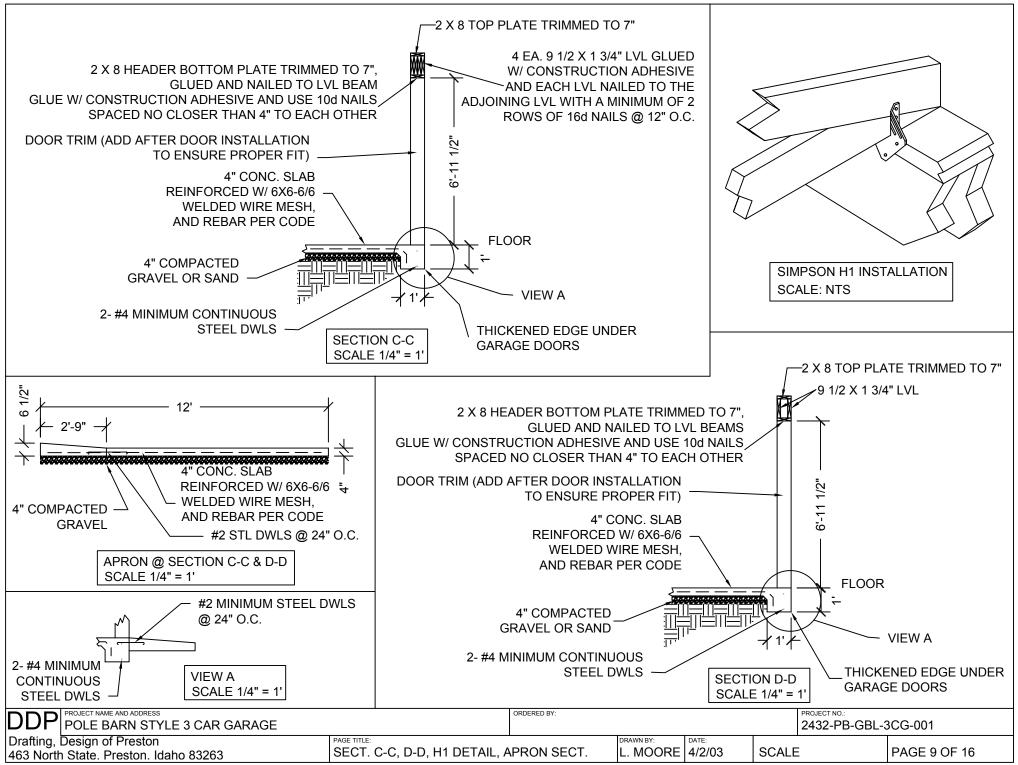



- .

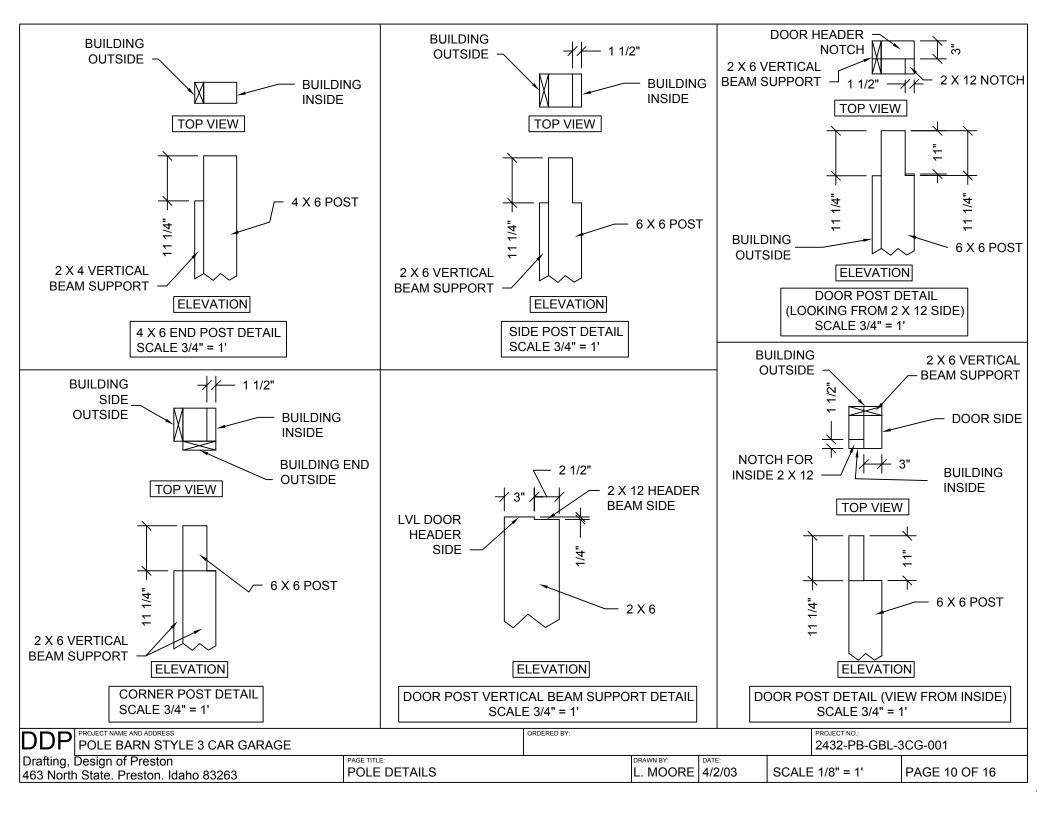

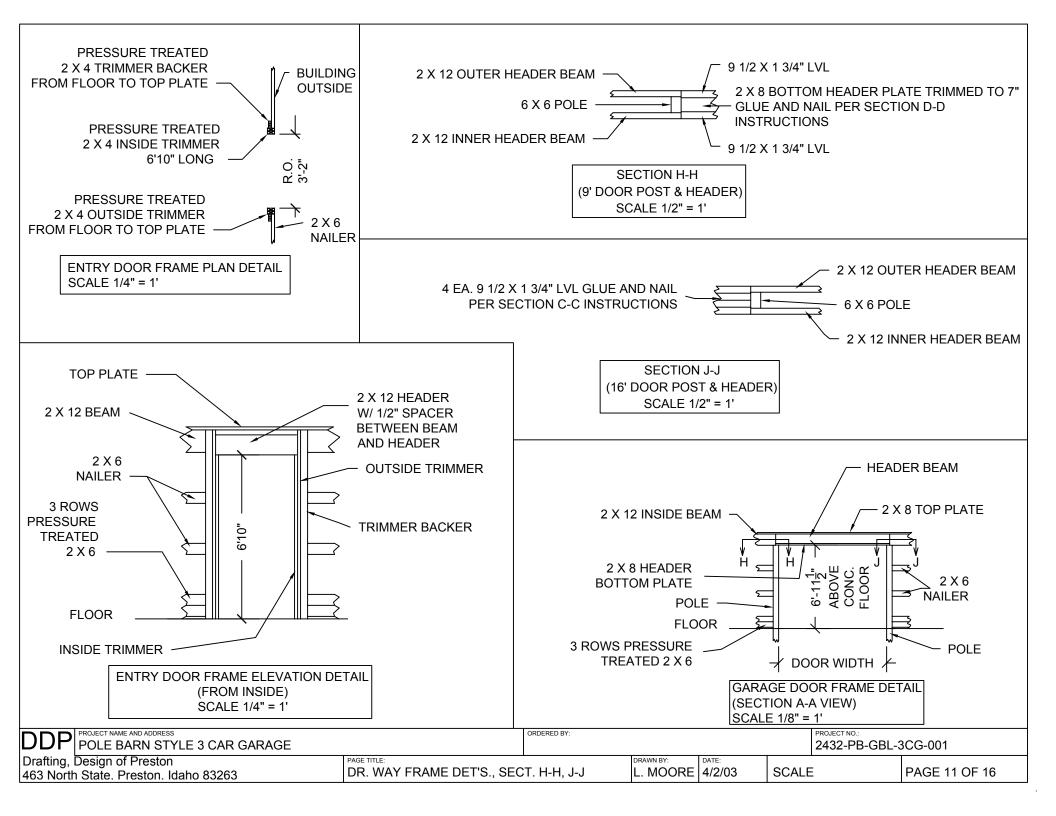

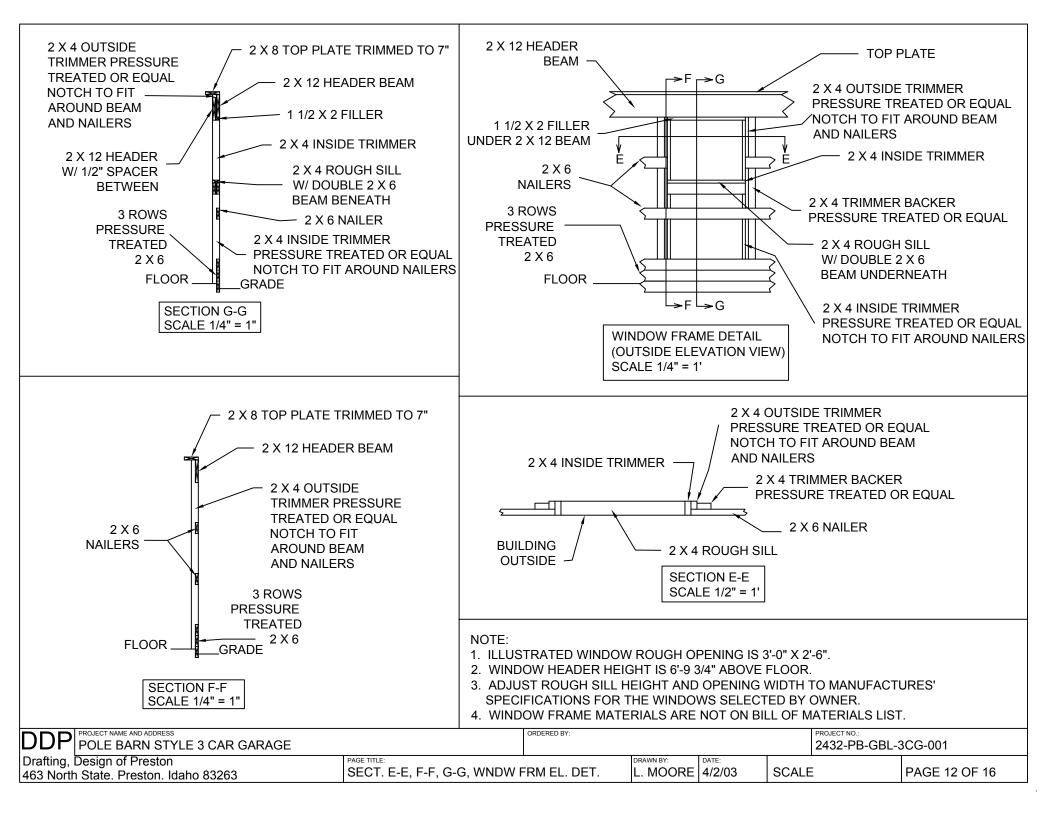

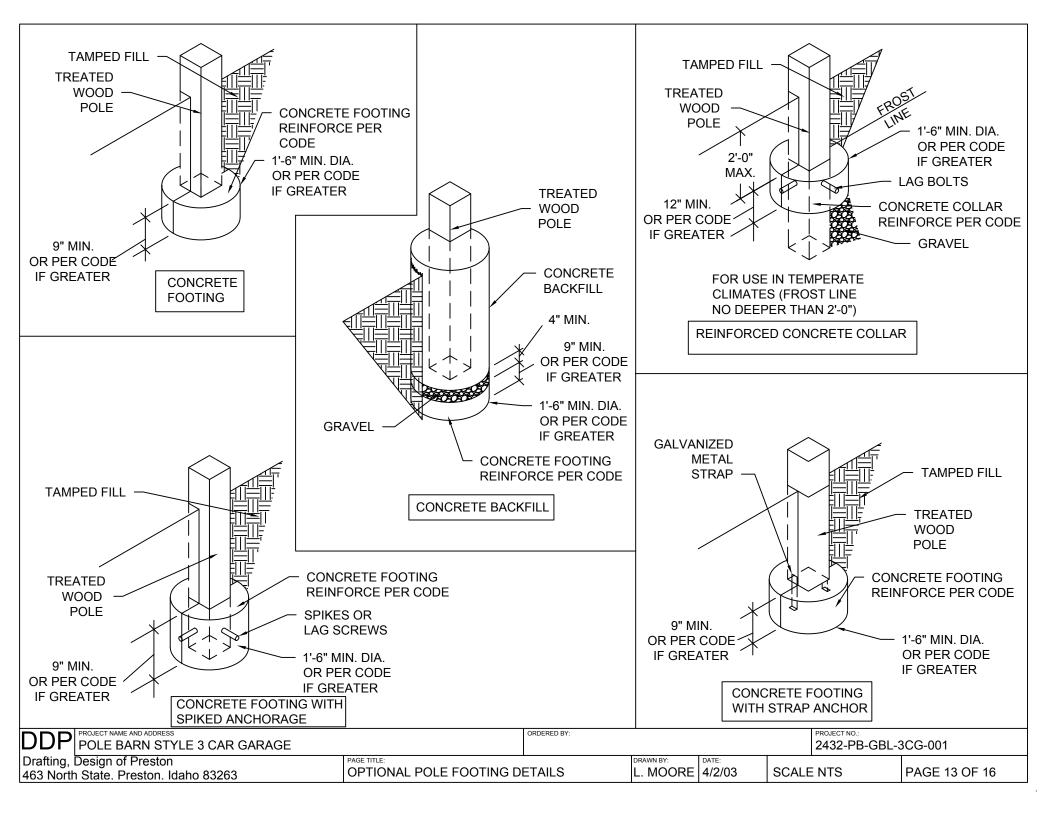

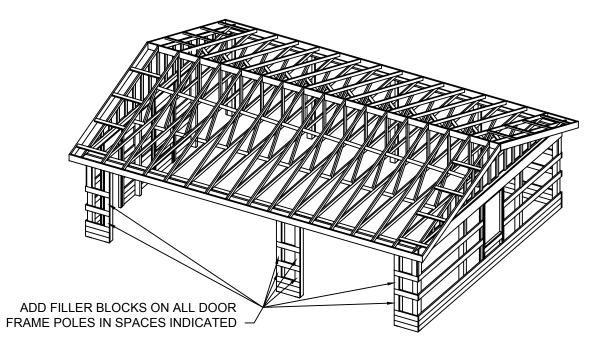

NOTE:				DOOR AND WINDOW SCHEDULE						
FRAME PICTORIAL IS ONLY TO GIVE A GENERAL IDEA OF HOW FRAME PARTS FIT TOGETHER IT IS NOT AN ACTUAL REPRESENTATION OF THE FINISHED FRAME. USE THE DETAILED DRAWINGS FOR ACTUAL CONSTRUCTION INFORMATION, WITH THE EXCEPTION AS SHOWN ABOVE.			5	SYMBOL SIZE		DI	DESCRIPTION		QTY	
				\triangle	3' X 6'-8"	EX	KTERIOR EN	TRY DOOR LH	1	
				\triangle	9' X 7'	SE	ECTIONAL G	ARAGE DOOR	1	
			Γ	ß	16' X 7'	SE	ECTIONAL G	ARAGE DOOR	1	
				1	OWNERS		WINDOW		2	
					CHOICE	0	WNER CHOIC	CE OF STYLE		
DDP PROJECT NAME AND ADDRESS POLE BARN STYLE 3 CAR GARAGE	GE ORDERED BY:						PROJECT NO.: 2432-PB-GBL-3CG-001			
Drafting, Design of Preston 463 North State. Preston. Idaho 83263	FRAME PICT., DOOR AND WINDOW SCHED.		drawn by: L. MOO	RE 4/2/0			CALE NTS PAGE 14 O		F 16	

General Specifications and Notes

General:

Construction shall meet all applicable codes and ordinances.

Site Work:

- 1. Make sure setbacks are in compliance with local building codes.
- 2. All stumps, roots, and organic matter shall be removed from the soil in the area of the building.
- 3. Lot must be graded to insure proper drainage away from building.
- 4. Soil should not be a highly expansive soil type without having a soil report preformed by a soils engineer and receiving approval from local building department to construct building on said type soil.

Concrete:

- 1. All slabs are to be 4" concrete over 4" gravel unless otherwise noted on the plans.
- 2. Concrete to be ACI 301-66, Type II cement, 2500 psi at 28 days, 5" maximum slump.
- 3. Reinforcing to be ASTM A 615-Bars with Fy=60 ksi lap 30 diameter minimum at splices or weld per ACI Std. in footings.
- 4. Reinforcing to be ASTM A 185-welded wire mesh in slabs.

Roof Framing:

- 1. For spans and dimensions refer to plans.
- 2. Use Simpson or equal anchors at each truss to wall connection

General framing: (Douglas Fir)

- 1. Exterior wall framing to be as shown on drawings.
- 2. Framing lumber shall be Douglas Fir construction grade Fb 1450 or better unless otherwise noted.
- 3. Use redwood or pressure treated posts and use redwood or pressure treated lumber for beams closer than 8" to the ground and for any other use where the lumber is closer than 8" to the ground or on cement.

Door and window framing:

1. Door and window manufacturer specified rough opening dimensions shall take precedence over drawing rough opening dimensions if there is a conflict.

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BILL OF MATERIALS

Size	Item	Count	
2x8-16ft	top plate, trimmed to 7"	6	ea.
2x8-8ft	top plate, trimmed to 7"	4	ea.
2x8-16'-6"	garage door beam bottom plate, trimmed to 7"	1	ea.
2x8-9'6"	garage door beam bottom plate, trimmed to 7"	1	ea.
2x6-16ft	nailers back wall	4	ea.
2x6-12ft	nailers end wall	6	ea.
2x6-8ft	nailers end wall	2	ea.
2x6-8ft	nailers front wall	2	ea.
2x6-20 in	vertical supports/filler blocks	19	ea.
2x6-20 1/4 in	vertical supports/filler blocks	4	ea.
2x4-20in	vertical supports/filler blocks	4	ea.
2x12-16ft	header beam	6	ea.
2x12-8ft	header beam	4	ea.
2x12-38in	ex door header beam	1	ea.
1 3/4"x9 1/2"-16'-6"	lvl garage door header	4	ea.
1 3/4"x9 1/2"-9'-6"	lvl garage door header	2	ea.
2x4-8ft	pressure treated fir stud, ex door frame	6	ea.
2x6-16ft	pressure treated bottom nailers	12	ea.
2x6-8ft	pressure treated bottom nailers	9	ea.
8" wide	Siding, Vinyl	1472	ft.
4x8x1/2	Sheet Plywood-exterior	34	ea.
	house wrap		sqft.
1x4-16ft+	garage door casing	56	ft.
7 in	garage door jamb	56	ft.
1x4-16ft+	ext. door casing	18	ft.
7 in	ext. door jamb	18	ft.
	roof truss	15	ea.
	roof truss, reduced gable, end	2	ea.
2x6"	ridge board - lumber	33	ft.
2x4"-34'	soffit nailer - lumber	2	ea.
2x6"-14'	fly rafters - lumber	4	ea.
2x4"-8'	lookout rafters - lumber	16	ea.
2x4"-1'	soffit lookout - lumber	34	ea.
	ridge vent	34	ft.
	ridge cap	34	ft.
	Roofing Dimensional Comp.		sqft.
4x8x5/8 sheets	roof sheathing	30	ea.
2x6"	gable fascia	55	ft.
2x6"	eave fascia	68	ft.
	metal drip edge	123	ft.
	gutter	68	ea.
	downspout	2	ea.
	window	2	ea.
108x84	garage door	1	ea.
192x84	garage door	1	ea.
36x80x1 3/4L	ext. entry door	1	ea.
wall mount	Porch Lantern	3	ea.
ceiling mount	light fixture	3	ea.
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