






INDUSTRIAL DEVELOPMENT MARIO CUDA **BLOCK 7 SECTION 6 14 SPONGOLITE STREET BEARD ACT**

DRAWING A001 TITLE PAGE A101 SITE PLAN A102 LANDSCAPE PLAN A201 BUILDING 1 GROUND FLOOR A202 BUILDING 1 UPPER FLOOR A203 ROOF PLAN A204 BUILDING 1 ELEVATIONS A205 BUILDING 1 ELEVATIONS & SECTION A206 BUILDING 1 SECTIONS A301 BUILDING 2 GROUND FLOOR A302 BUILDING 2 UPPER FLOOR A303 ROOF PLAN A304 BUILDING 2 ELEVATIONS A305 BUILDING 2 ELEVATIONS A306 BUILDING 2 SECTIONS A401 BIN ENCLOSURE & LETTERBOX DETAILS A701 VERGE MANAGEMENT PLAN A702 SEDIMENT & EROSION PLAN

> DA SUBMISSION NOT FOR CONSTRUCTION

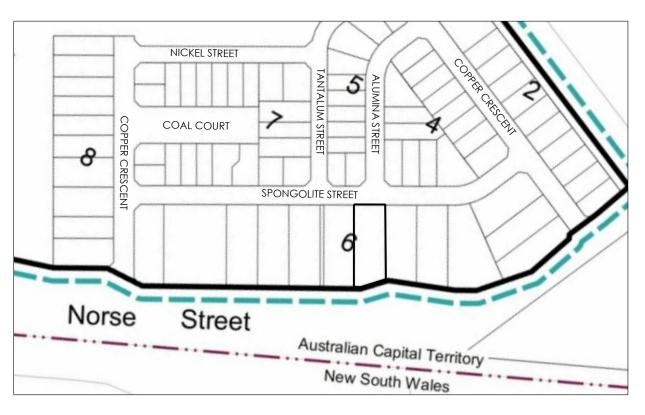

NTS

UMINAIRE SCHEDULE - CARPARK LIGHTING (TO COMPLY WITH AS1158.3.1:2005)							
SYMBOL DESCRIPTION Qty LUMINAIRE WATTS/ MAINT. LUMEN OUTPUT LUMINAIRE FACTOR							
KIM "ARCHETYPE" AR4 250W METAL HALIDE WITH CLEAR FLAT GLASS LENS WALL MOUNTED 9 23000 250 0.8							

GENERAL NOTES THIS DRAWING SHALL BE READ IN CONJUNCTION WITH THE ENGINEERS DETAILS.

CONFIRM STEEL SIZES PRIOR TO CONSTRUCTION

ALL MATERIALS AND FINISHES SHALL BE APPROVED BY THE OWNERS VARIATIONS TO PLAN AND SPECIFICATION SHALL NOT BE MADE WITHOUT THE CONSENT OF THE OWNERS ALL DIMENSIONS SHALL BE VERIFIED ON SITE ALL WORK SHALL BE CARRIED OUT IN ACCORDANCE WITH THE BCA DO NOT SCALE OFF DRAWINGS FIRE PRECAUTIONS DURING CONSTRUCTION SHALL BE IN ACCORDANCE WITH SECTION E CLAUSE E1.6 OF THE BCA PROVIDE PORTABLE FIRE EXTINGUISHES IN ACCORDANCE WITH SECTION E CLAUSE E1.6 OF THE BCA FIRE EXTINGUISHERS SHALL COMPLY WITH AS 2444 ALL MATERIALS AND ASSEMBLIES SHALL COMPLY WITH C1.10 OF THE BCA ALL WET AREA FLOORS SHALL BE GRADED AND DRAINED TO FLOOR WASTES TO PLUMBLING CODES AND THE BCA PROVIDE IMPERVIOUS WALL TO FLOOR JOINT TO THE PERIMETER OF ALL WET AREAS WATERPROOFING SHALL COMPLY WITH C1. F1.7 OF THE BCA CONFIRM LOCATION OF ALL SERVICES PRIOR TO CONSTRUCTION EGRESS REQUIRED PATHS OF EXIT BE IN ACCORDANCE WITH PART D1.6 OF THE BCA THE UNOBSTURCTED HEIGHT MUST BE NO LESS THEN 2.0M EXCEPT AT DOORWAYS WHERE THE HEIGHT MAY BE REDUCED TO 1.98M. THE UNOBSTRUCTED WIDTH OF EACH EXIT OR PATH OF TRAVEL TO AN EXIT, EXCEPT AT DOORWAYS MUST BE 1.0M MINIMUM REQUIRED EXIT SIGNS SHALL BE IN ACCORDANCE WITH PART E4 OF THE BCA PROVIDE EMERGENCY ILLUMINATED EXIT SIGNS TO REQUIRED EXITS TO AS 2293.1 EXITS MUST NOT BE BLOCKED AT THE POINT OF DISCHARGE, AND WHERE NECCESARY SUITABLE BARRIERS MUST BE PROVIDED TO PREVENT VEHICLES FROM BLOCKING EXITS OPERATION OF LATCHES MUST BE IN ACCORDANCE WITH PART D2.1 OF THE BCA A REQUIRED EXIT DOOR MUST BE READILY OPENABLE WITHOUT A KEY FROM THE SIDE THAT FACES THE PERSON SEEKING EGRESS BY A SINGLE HAND DOWNWARD ACTION OR PUSHING ACTION ON A SINGLE DEVICE WHICH IS

LOCATED BETWEEN 900MM AND 1200MM FROM THE FLOOR LIGHTING INSTALL EMERGENCY LIGHTING IN ACCORDANCE WITH AS

2293.1 AND PART E4.2 OF THE BCA INCLUDING DIRECTIONAL SIGNAGE (NOT SHOWN ON PLANS) TO BCA REQUIREMENTS PROVIDE ARTIFICIAL LIGHTING TO AS 1680

ACESSIBILITY ACESS FOR PEOPLE WITH DISABLITIES SHALL COMPLY WITH PART D3 OF THE BCA AND AS 1428.1 DISABLED PERSON TOILETS SHALL COMPLY WITH AS 1428.1 DISABLED PERSON WC SHALL HAVE ADEQUATE FACILITIES FOR THE DISPOSAL OF SANITARY TOWELS AND A SHELF MUST ALSO

BE PROVIDED DISABLED PERSON CAR APRKING SHALL BE IN ACCORDANCE WITH D3.5 TACTILE INDICATORS

PROVIDE TACTILE INDICATORS IN ACCORDANCE WITH D3.8 OF THE BCA AND AS 1428.1 AT THE ENTRANCE TO THE CARPARK AREA AND AT THE APPROACH TO THE STAIRWAY THE BUILDING ACCESS SHALL HAVE A SLIP RESISTANT SURFACE

PROVIDE BRAILLE AND TACTILE SIGNS TO IDENTIFY SANITARY FACILITIES

INSTALL ROOF SARKING TO AS/NZS 4200 PARTS 1 AND 2

THIS PLAN IS PREPARED FOR THE CLIENT FROM A COMBINATION OF FIELD SURVEYS AND EXISTING RECORDS PROVIDED BY THE CLIENT SERVICES AND INFORMATION SHOWN HEREON HAVE BEEN LOCATED WHERE POSSIBLE BY FIELD SURVEY. IF NOT ABLE TO BE LOCATED, SERVICES HAVE BEEN PLOTTED FROM RECORDS OF RELEVANT AUTHORITIES WHERE AVAILABLE AND HAVE

PRIOR TO ANY DEMOLITION, EXCAVATION OR CONSTRUCTION ON THE SITE, RELEVANT AUTHORITY SHOULD BE CONTACTED FOR THE POSSIBLE LOCATION OF FURTHER UNDERGROUND SERVICES AND DETAILED LOCATION OF ALL SERVICES. THIS NOTE IS AN INTEGRAL PART OF THIS PLAN

BEEN NOTED ACCORDINGLY ON THIS PLAN

<u>STAIRS</u>

GOINGS AND RISERS SHALL BE INACCORDANCE WITH PART D OF THE BCA NOMINAL DIMENSIONS OF RISERS AND TREAD MUST CONSISTANT FOR EACH FLIGHT OF STAIRS AND THERE MUST BE NO MORE THEN 18 RISERS PER FLIGHT RISER AND GOINGS SHALL BE IN ACCORDANCE WITH THE

RISER 190 MAX, 115 MIN GOINGS 355 MAX 250 MIN

QUANTITY (2xRISER+GOING) 700MAX, 550 MIN STAIR SHALL BE BALUSTRADED WHERE HEIGHT TO FINISHED GROUND LEVEL EXCEEDS 1.0M BALUSTRADE SHALL BE 1000 HIGH AND NOT LESS THEN 865MM ABOVE STAIR NOSINGS, NO OPENING IN BALUSTRADE MUST ALLOW A 125MM SPHERE TO PASS THROUGH. LOADING

WHERE HEIGHT OF STAIR IS GREATER THAN 570 ABOVE FINISHED GROUND LEVEL A LANDING IN ACCORDANCE WITH CLAUSE 3.9.1.3 SHALL BE PROVDIED

FORCES MUST BE IN ACCORDANCE WITH AS 1170.1

SAFETY IN DESIGN STATEMENT

WE DO NOT BELIEVE THAT THERE ARE ANY DESIGN ELEMENTS ASSOCIATED WITH THIS PROJECT THAT WOULD POSE ANY UNUSUAL RISKS TO HEALTH AND SAFETY THAT WOULD BE CONSIDERED OUTSIDE OF THOSE NORMALLY EXPECTED FOR THIS BUILDING TYPE. IF ANY PERSONS CONNECTED WITH THIS PROJECT CAN IDENTIFY ANY UNUSUAL RISKS THAT NEED TO BE ADDRESSED PLEASE CONSULT THE DESIGNER

DISABLED COMPLIANCE STATEMENT

THIS BUILDING HAS BEEN DESIGNED TO COMPLY WITH THE REQUIREMENTS OF DISABLED ACCESS AND MOBILITY IN ACCORDANCE WITH THE BCA AND AS 1428. ACCESS TO ALL AREAS OF THE GROUND FLOOR IS PROVIDED THROUGH THE PRIMARY ENTRY. THE THRESHOLD AND DOOR OPENINGS WILL BE CONSTRUCTED TO COMPLY WITH AS 1428. DISABLED TOILET FACILITIES HAVE BEEN INCORPORATED INTO THE PRIMARY UNISEX TOILET. THE TOILET WILL BE CONSTRUCTED AND FITTED OUT TO COMPLY WITH AS 1428.

ONE DISABLED CAR PARK HAS BEEN PROVIDED CLOSE TO THE ENTRY OF THE BUILDING TO THE DIMENSIONS OF THE ACT PARKING AND VEHICLE ACCESS GUIDELINES

AREA ANALYSIS:

SITE AREA3356m²BUILDING 1 GFA:
GROUND FLOOR712.8m²
118.0m²GROUND FLOOR ANCILLARY OFFICE118.0m²
830.8m²MEZZ LEVEL ANCILLARY OFFICE121.2m²
952.0m²

 BUILDING 2 GFA:

 GROUND FLOOR UNIT 1
 452m²

 GF ANCILLARY OFFICE UNIT 1
 79m²

 MEZZ LEVEL ANCILLARY OFFICE UNIT 1
 91m²

 UNIT 1 TOTAL
 622m²

 GROUND FLOOR UNIT 2
 405m²

FUTURE GF ANCILLARY OFFICE UNIT 279m²FUTURE MEZZ ANCILLARY OFFICE UNIT 291m²UNIT 2 TOTAL575m²BUILDING 2 GFA TOTAL1197m²GRAND TOTAL GFA2149m²


CAR PARKING ANALYSIS:

WAREHOUSE AND WAREHOUSE OFFICE AREAWAREHOUSE AREA1570m²WAREHOUSE OFFICE AREA579m²CAR PARKING REQUIREDWAREHOUSE - 1 PARKING SPACE PER 100m²1570 / 100 x 1 = 15.70

ANCILLARY OFFICE AREA - 2.5 PARKING SPACES PER 100m² 579 / 100 x 2.5 = 14.47 15.70 + 14.47 = 30.17 30 CAR PARKING SPACES ARE REQUIRED

CAR PARKING PROVIDED A TOTAL OF 32 CAR PARKING SPACES HAVE BEEN PROVIDED INCLUDING 2 ACCESSIBLE SPACES.




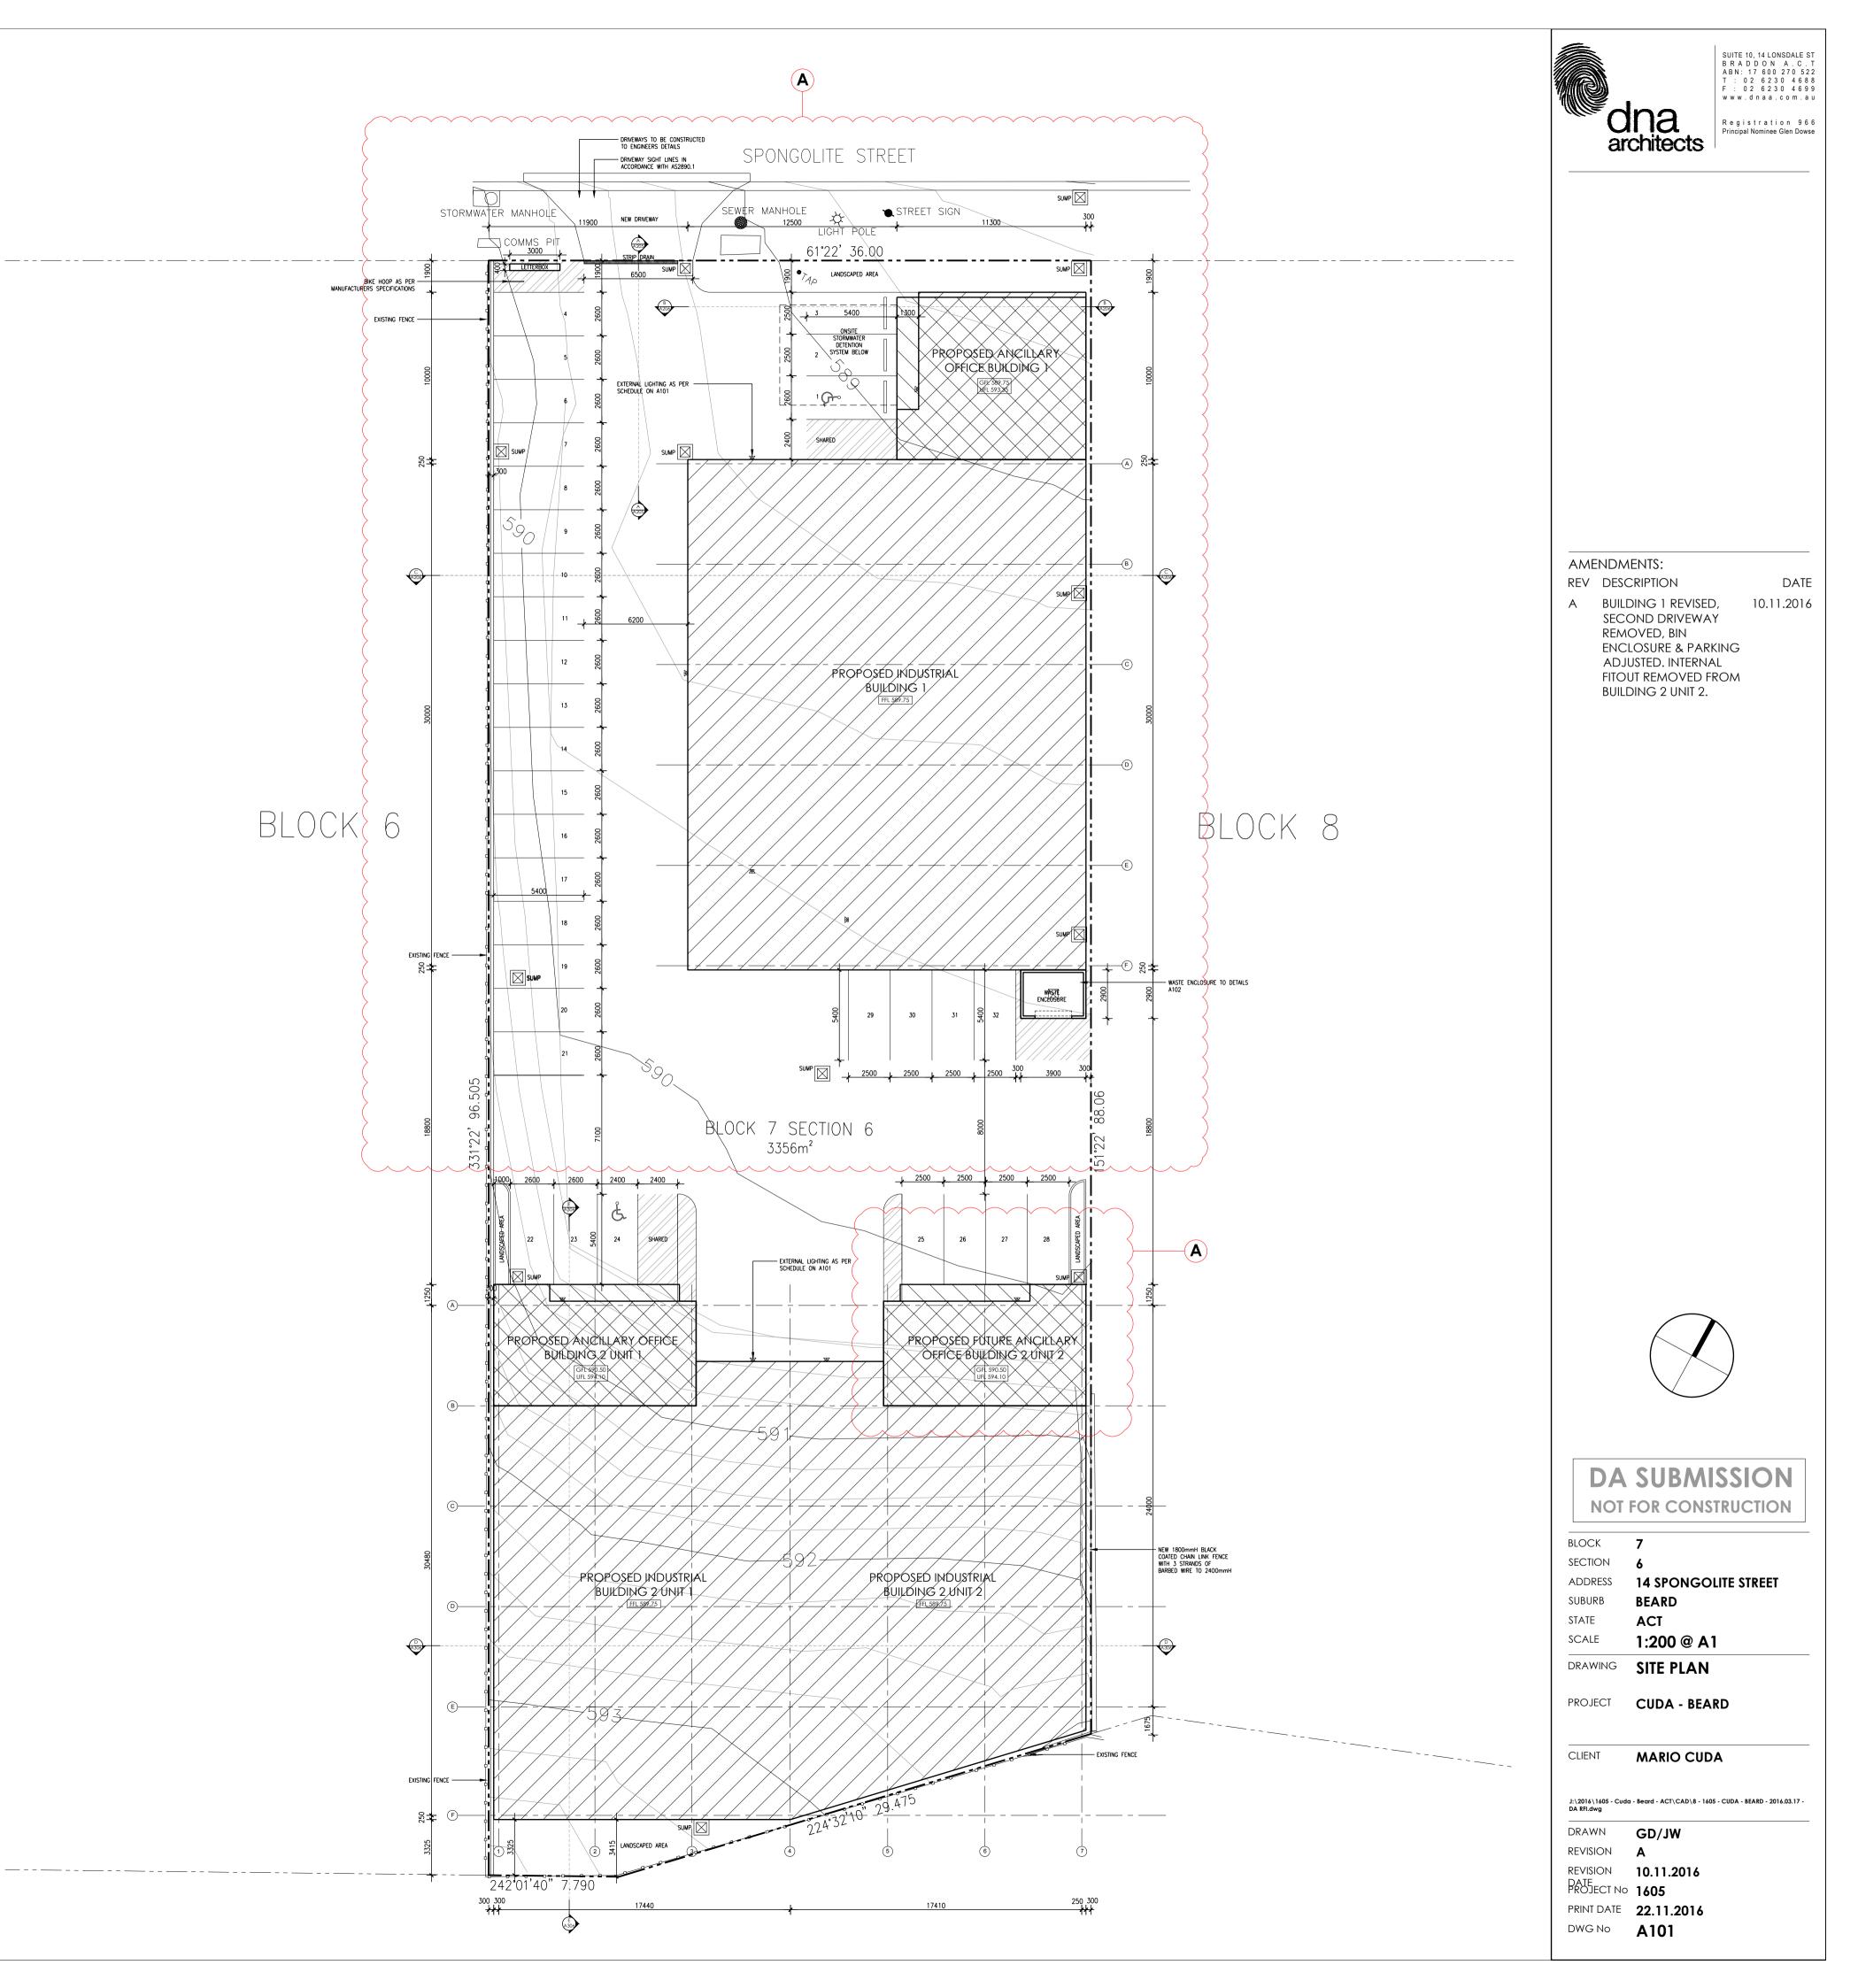


LEGEND	
	CONCRETE DRIVEWAY OR PARKING
	LANDSCAPED AREA


NOTE: ALL PLANTING TO COMPLY WITH CRIME PREVENTION THROUGH ENVIRONMENTAL DESIGN GENERAL CODE




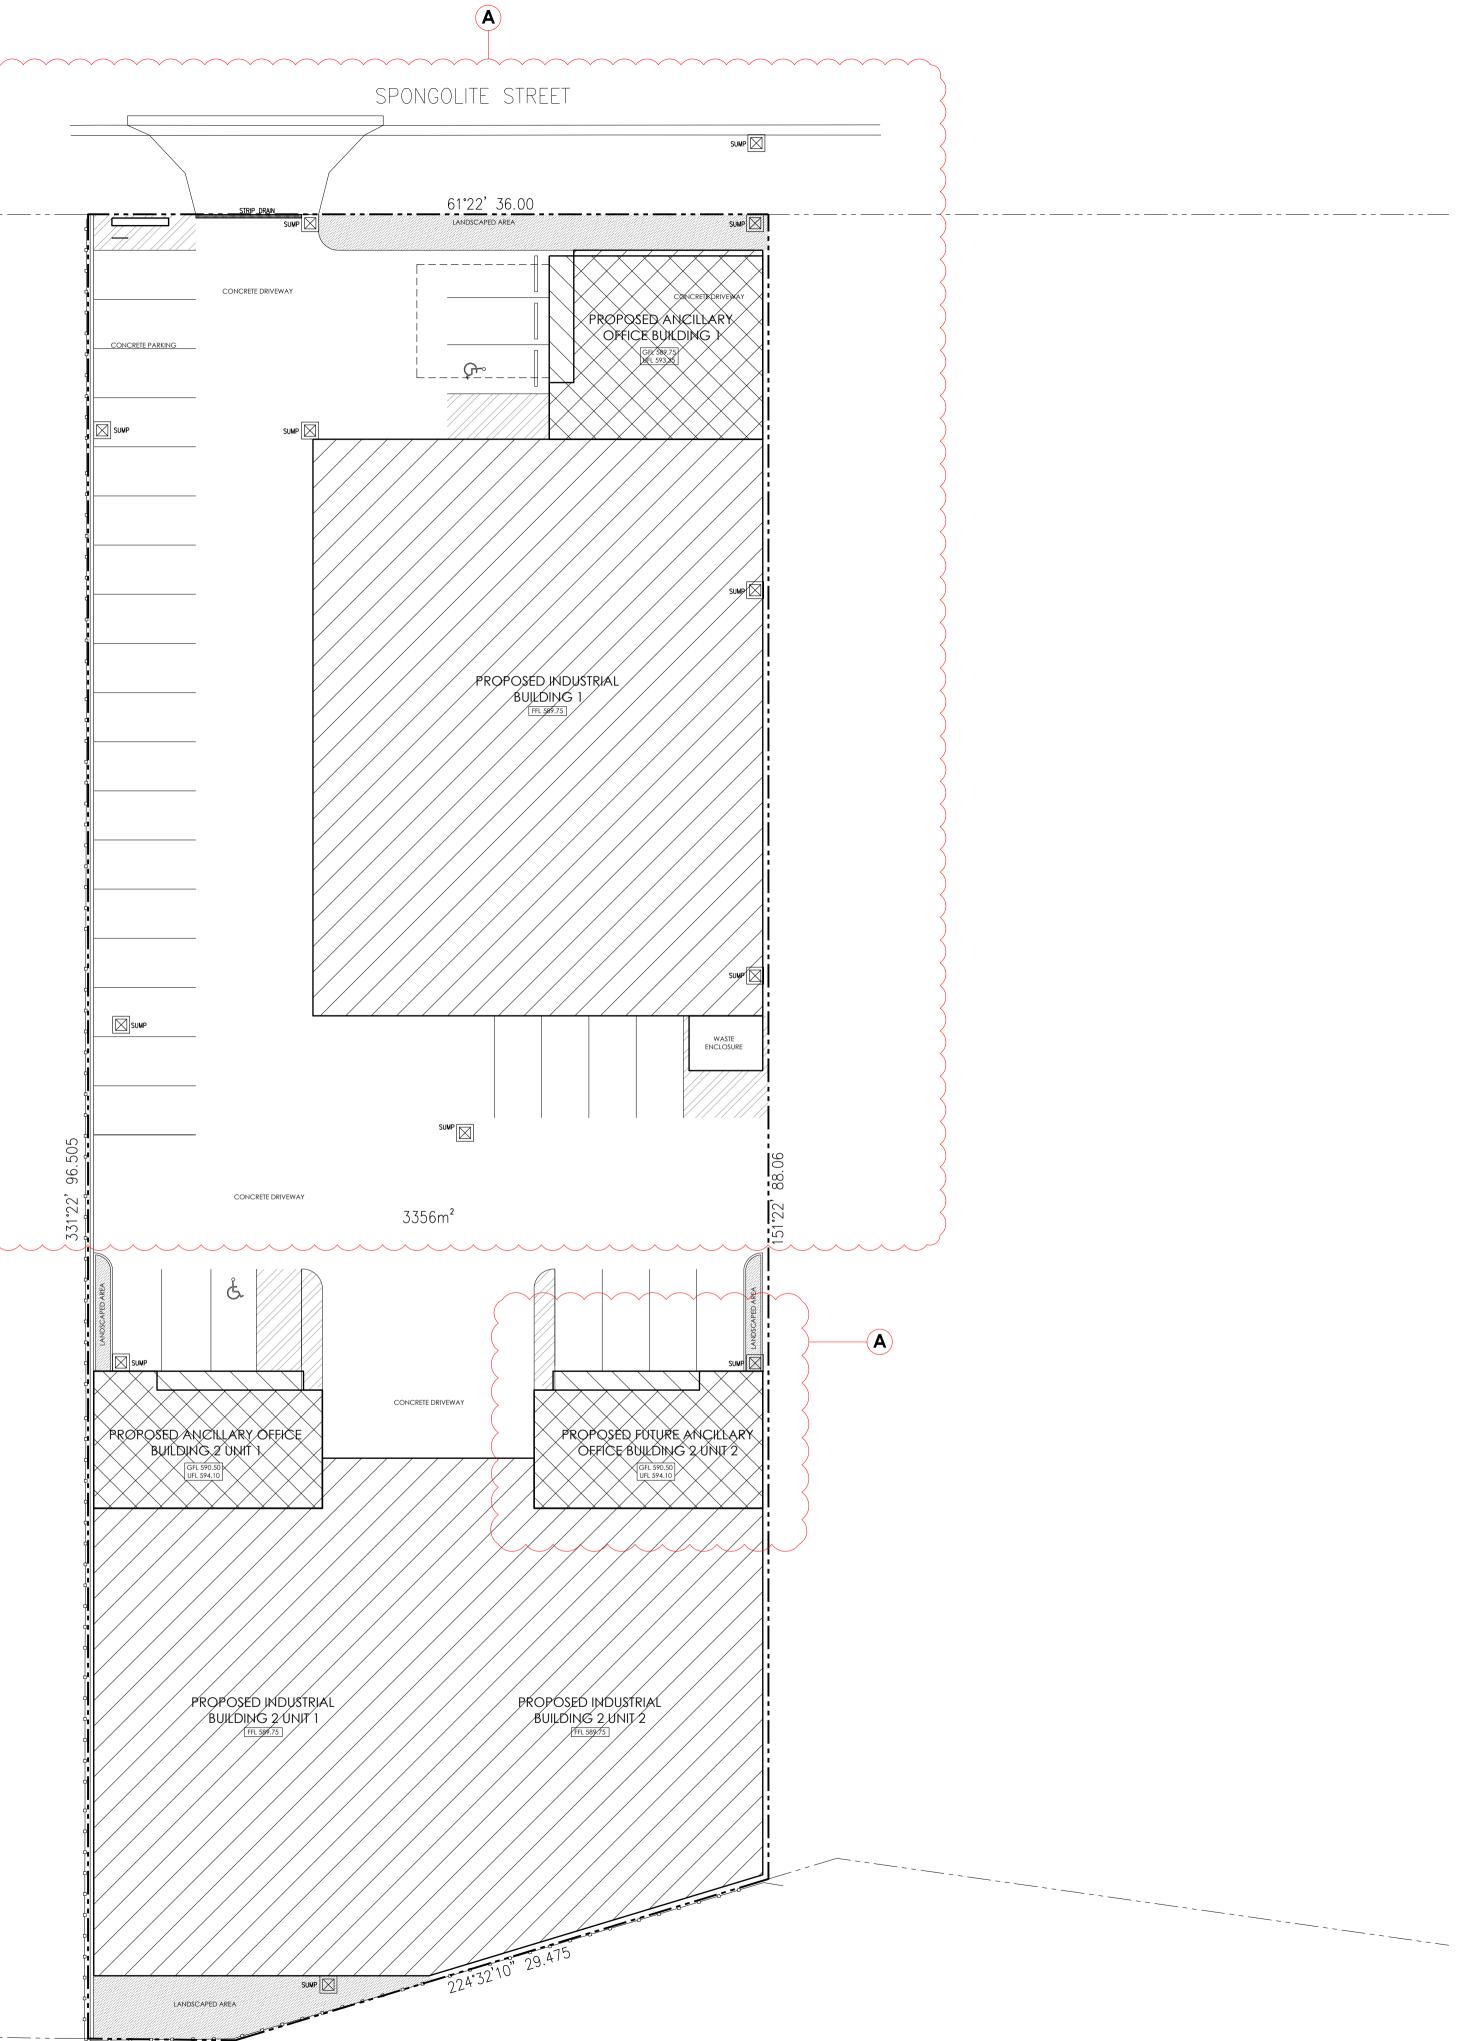



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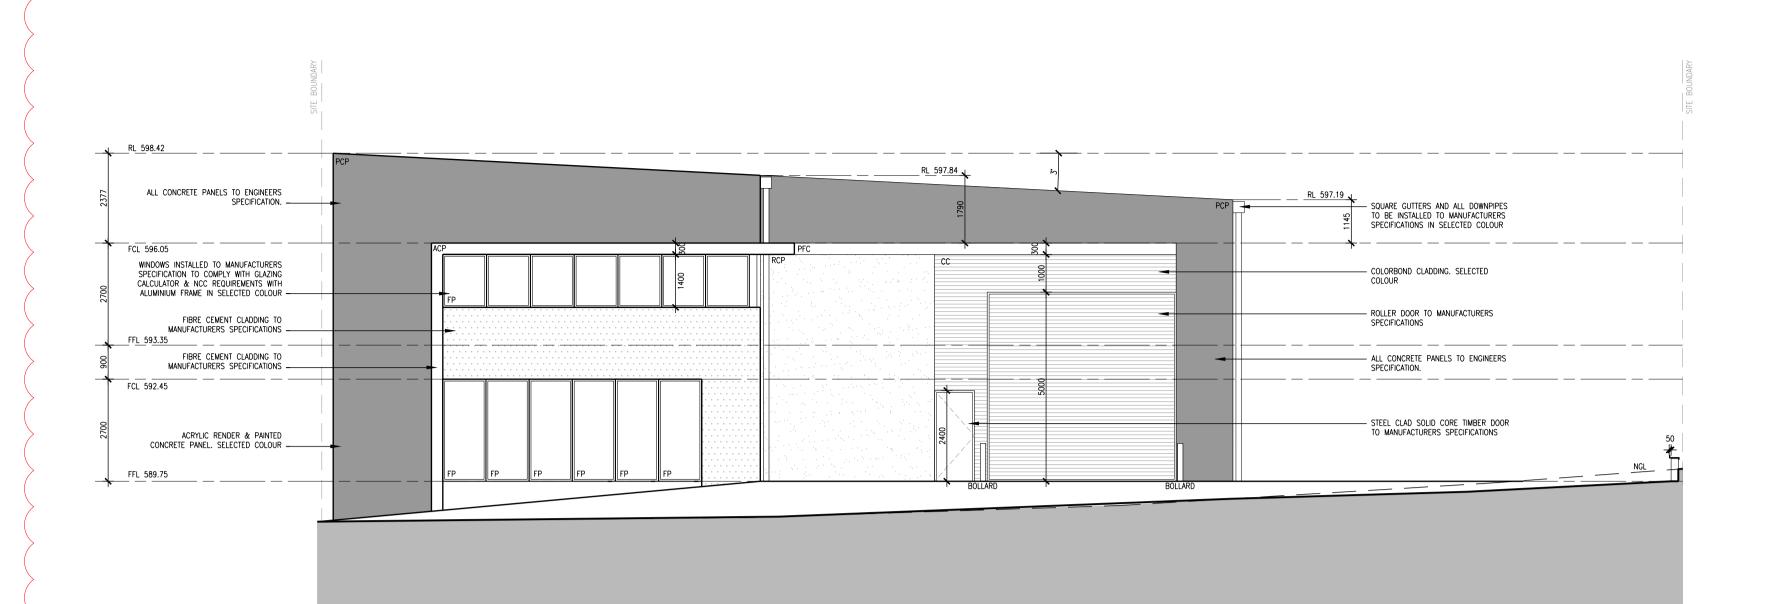


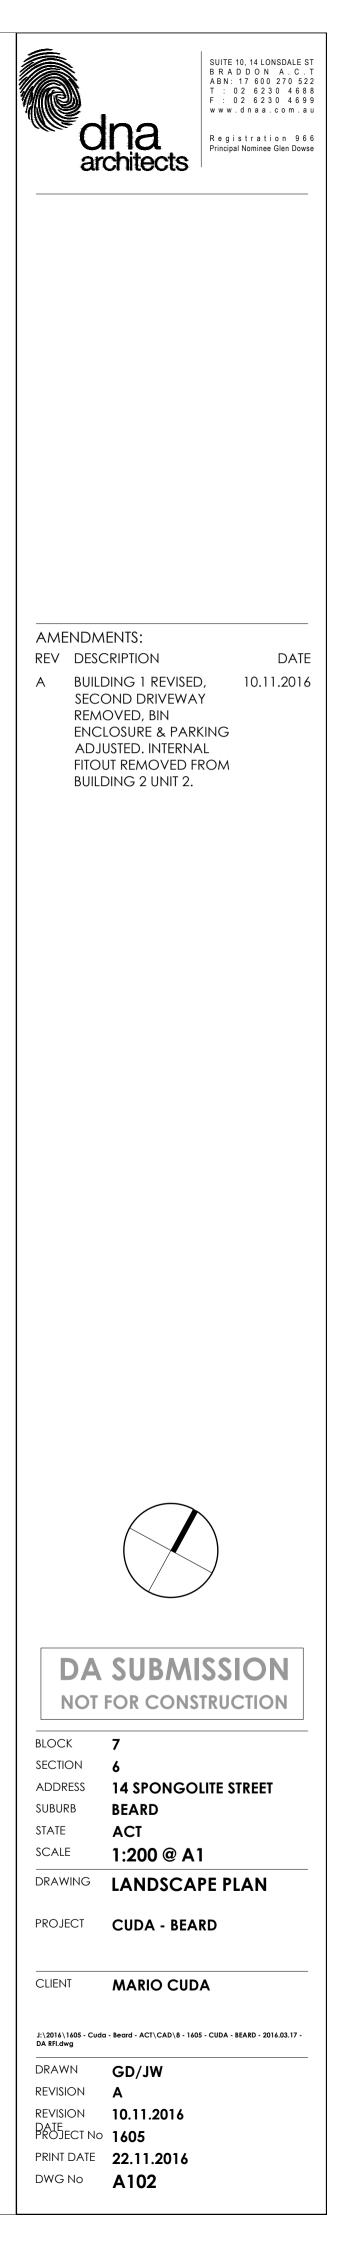

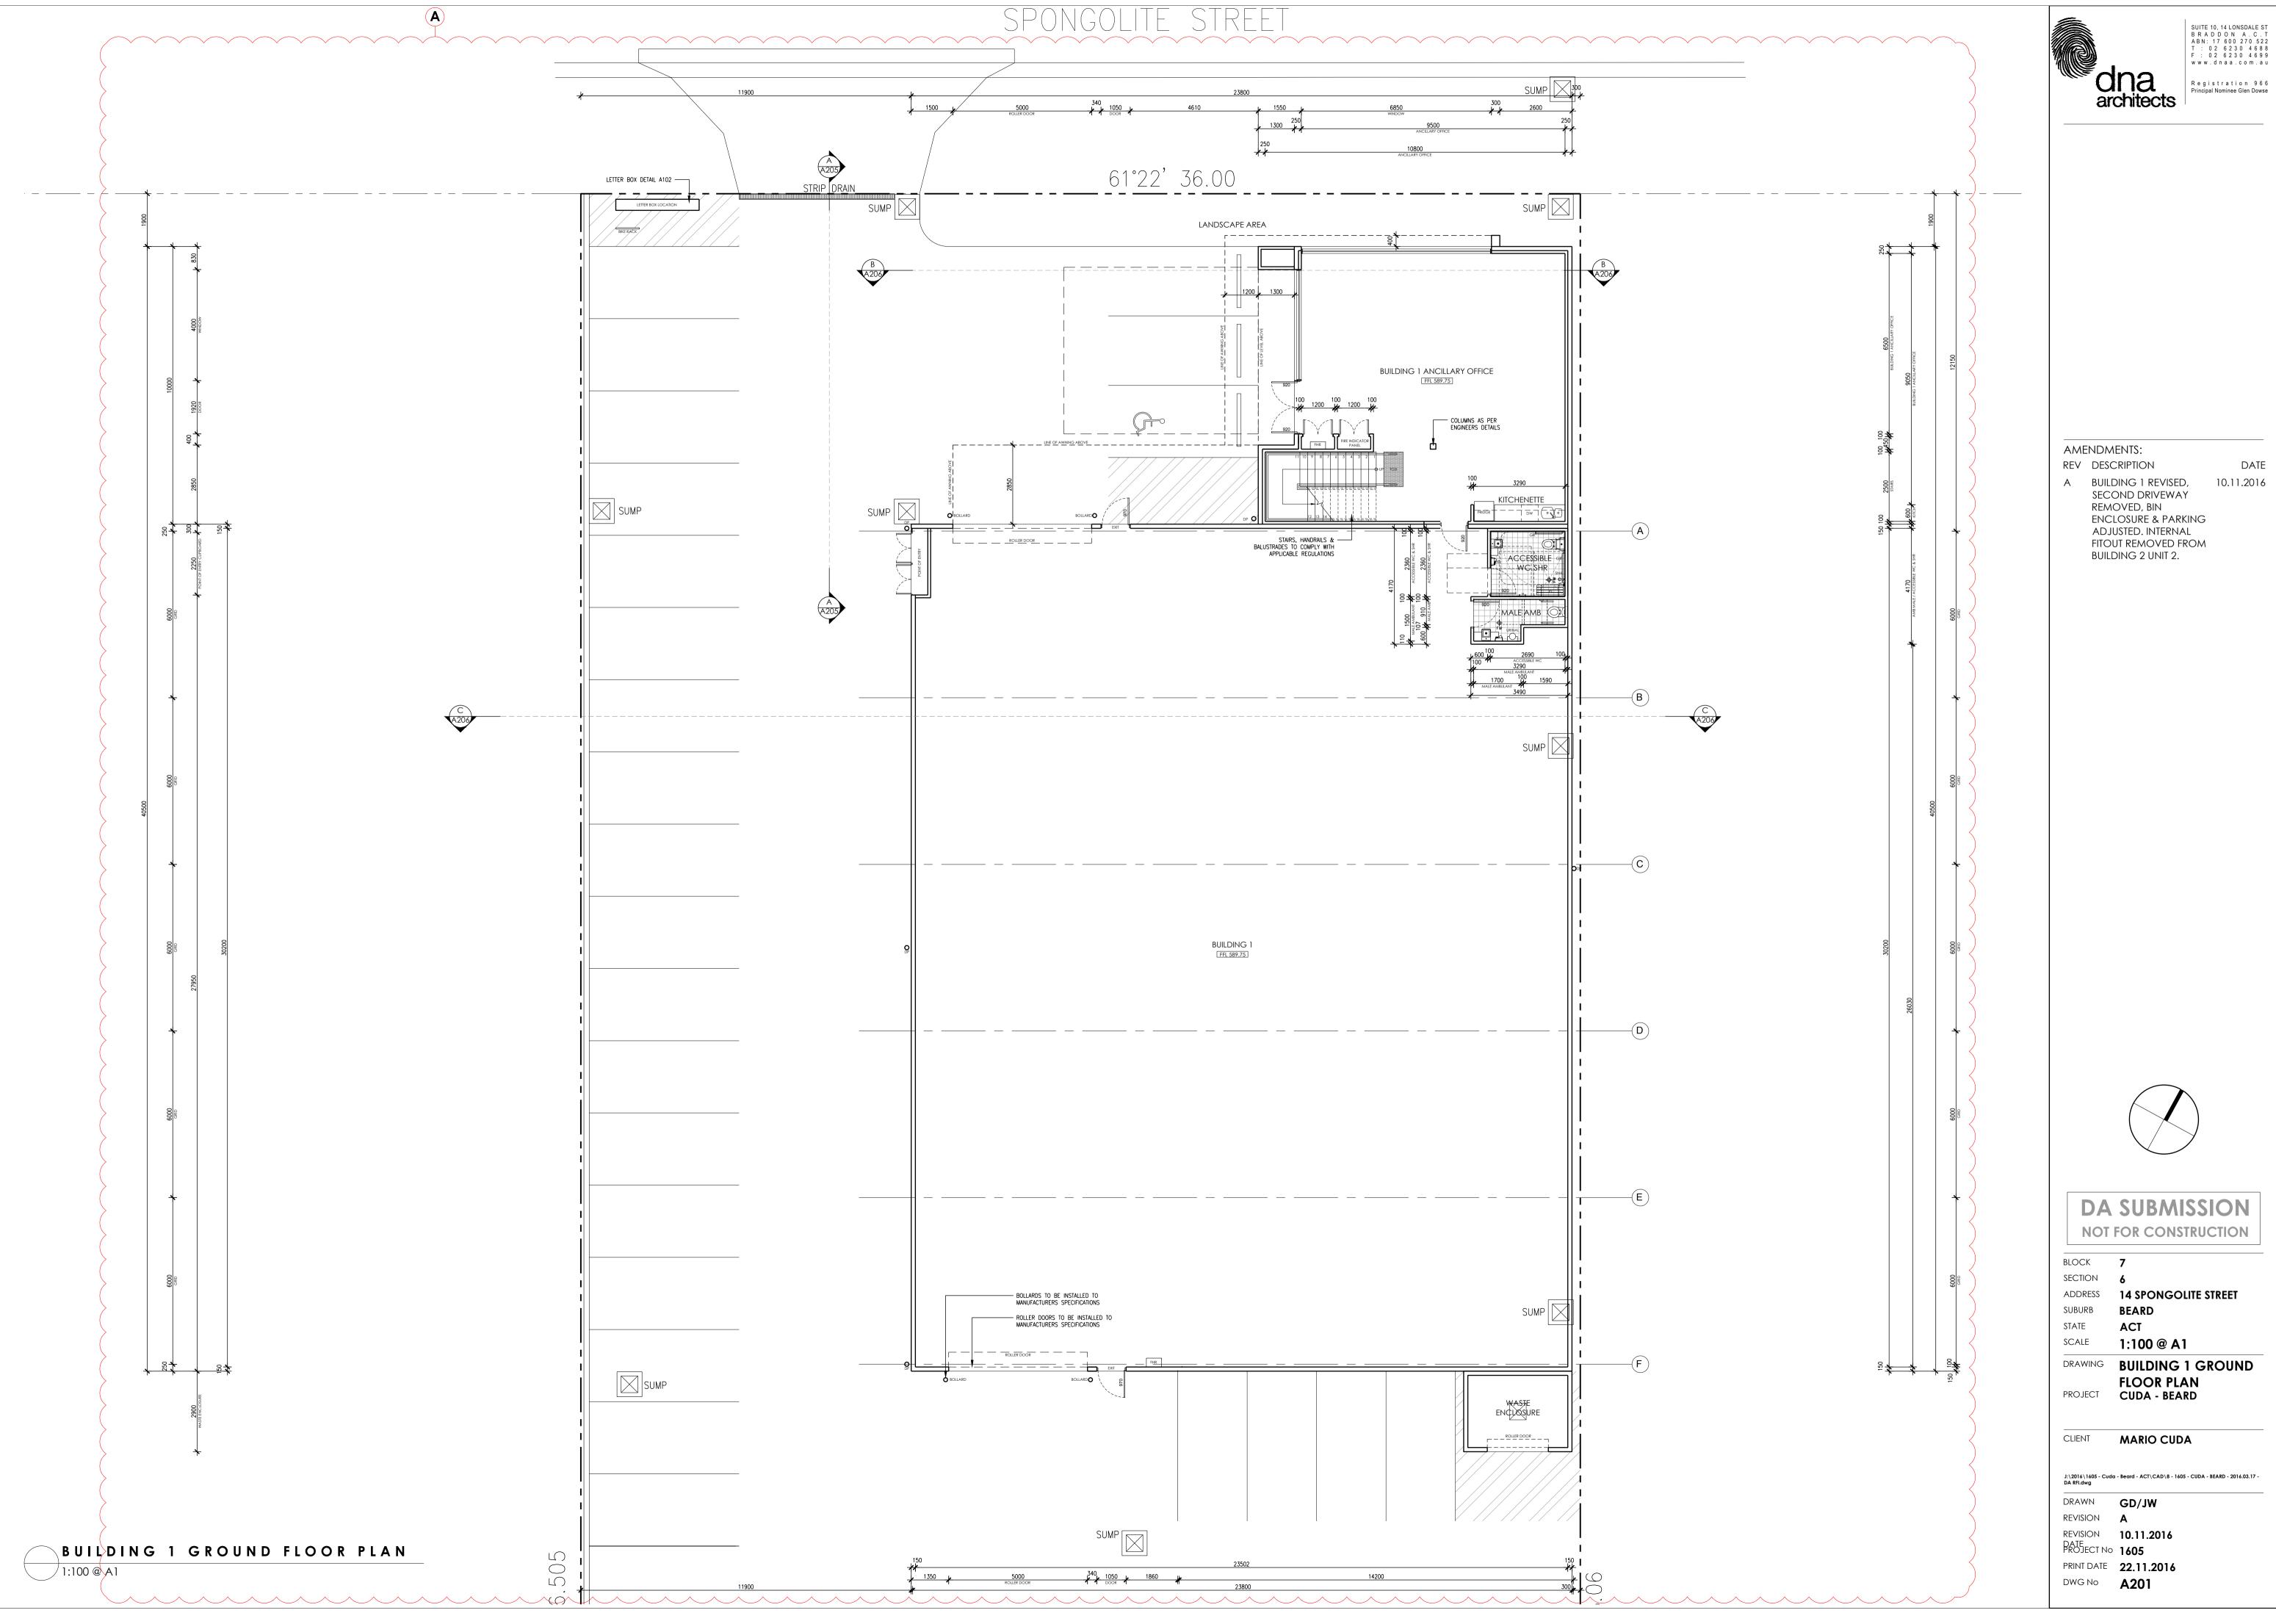

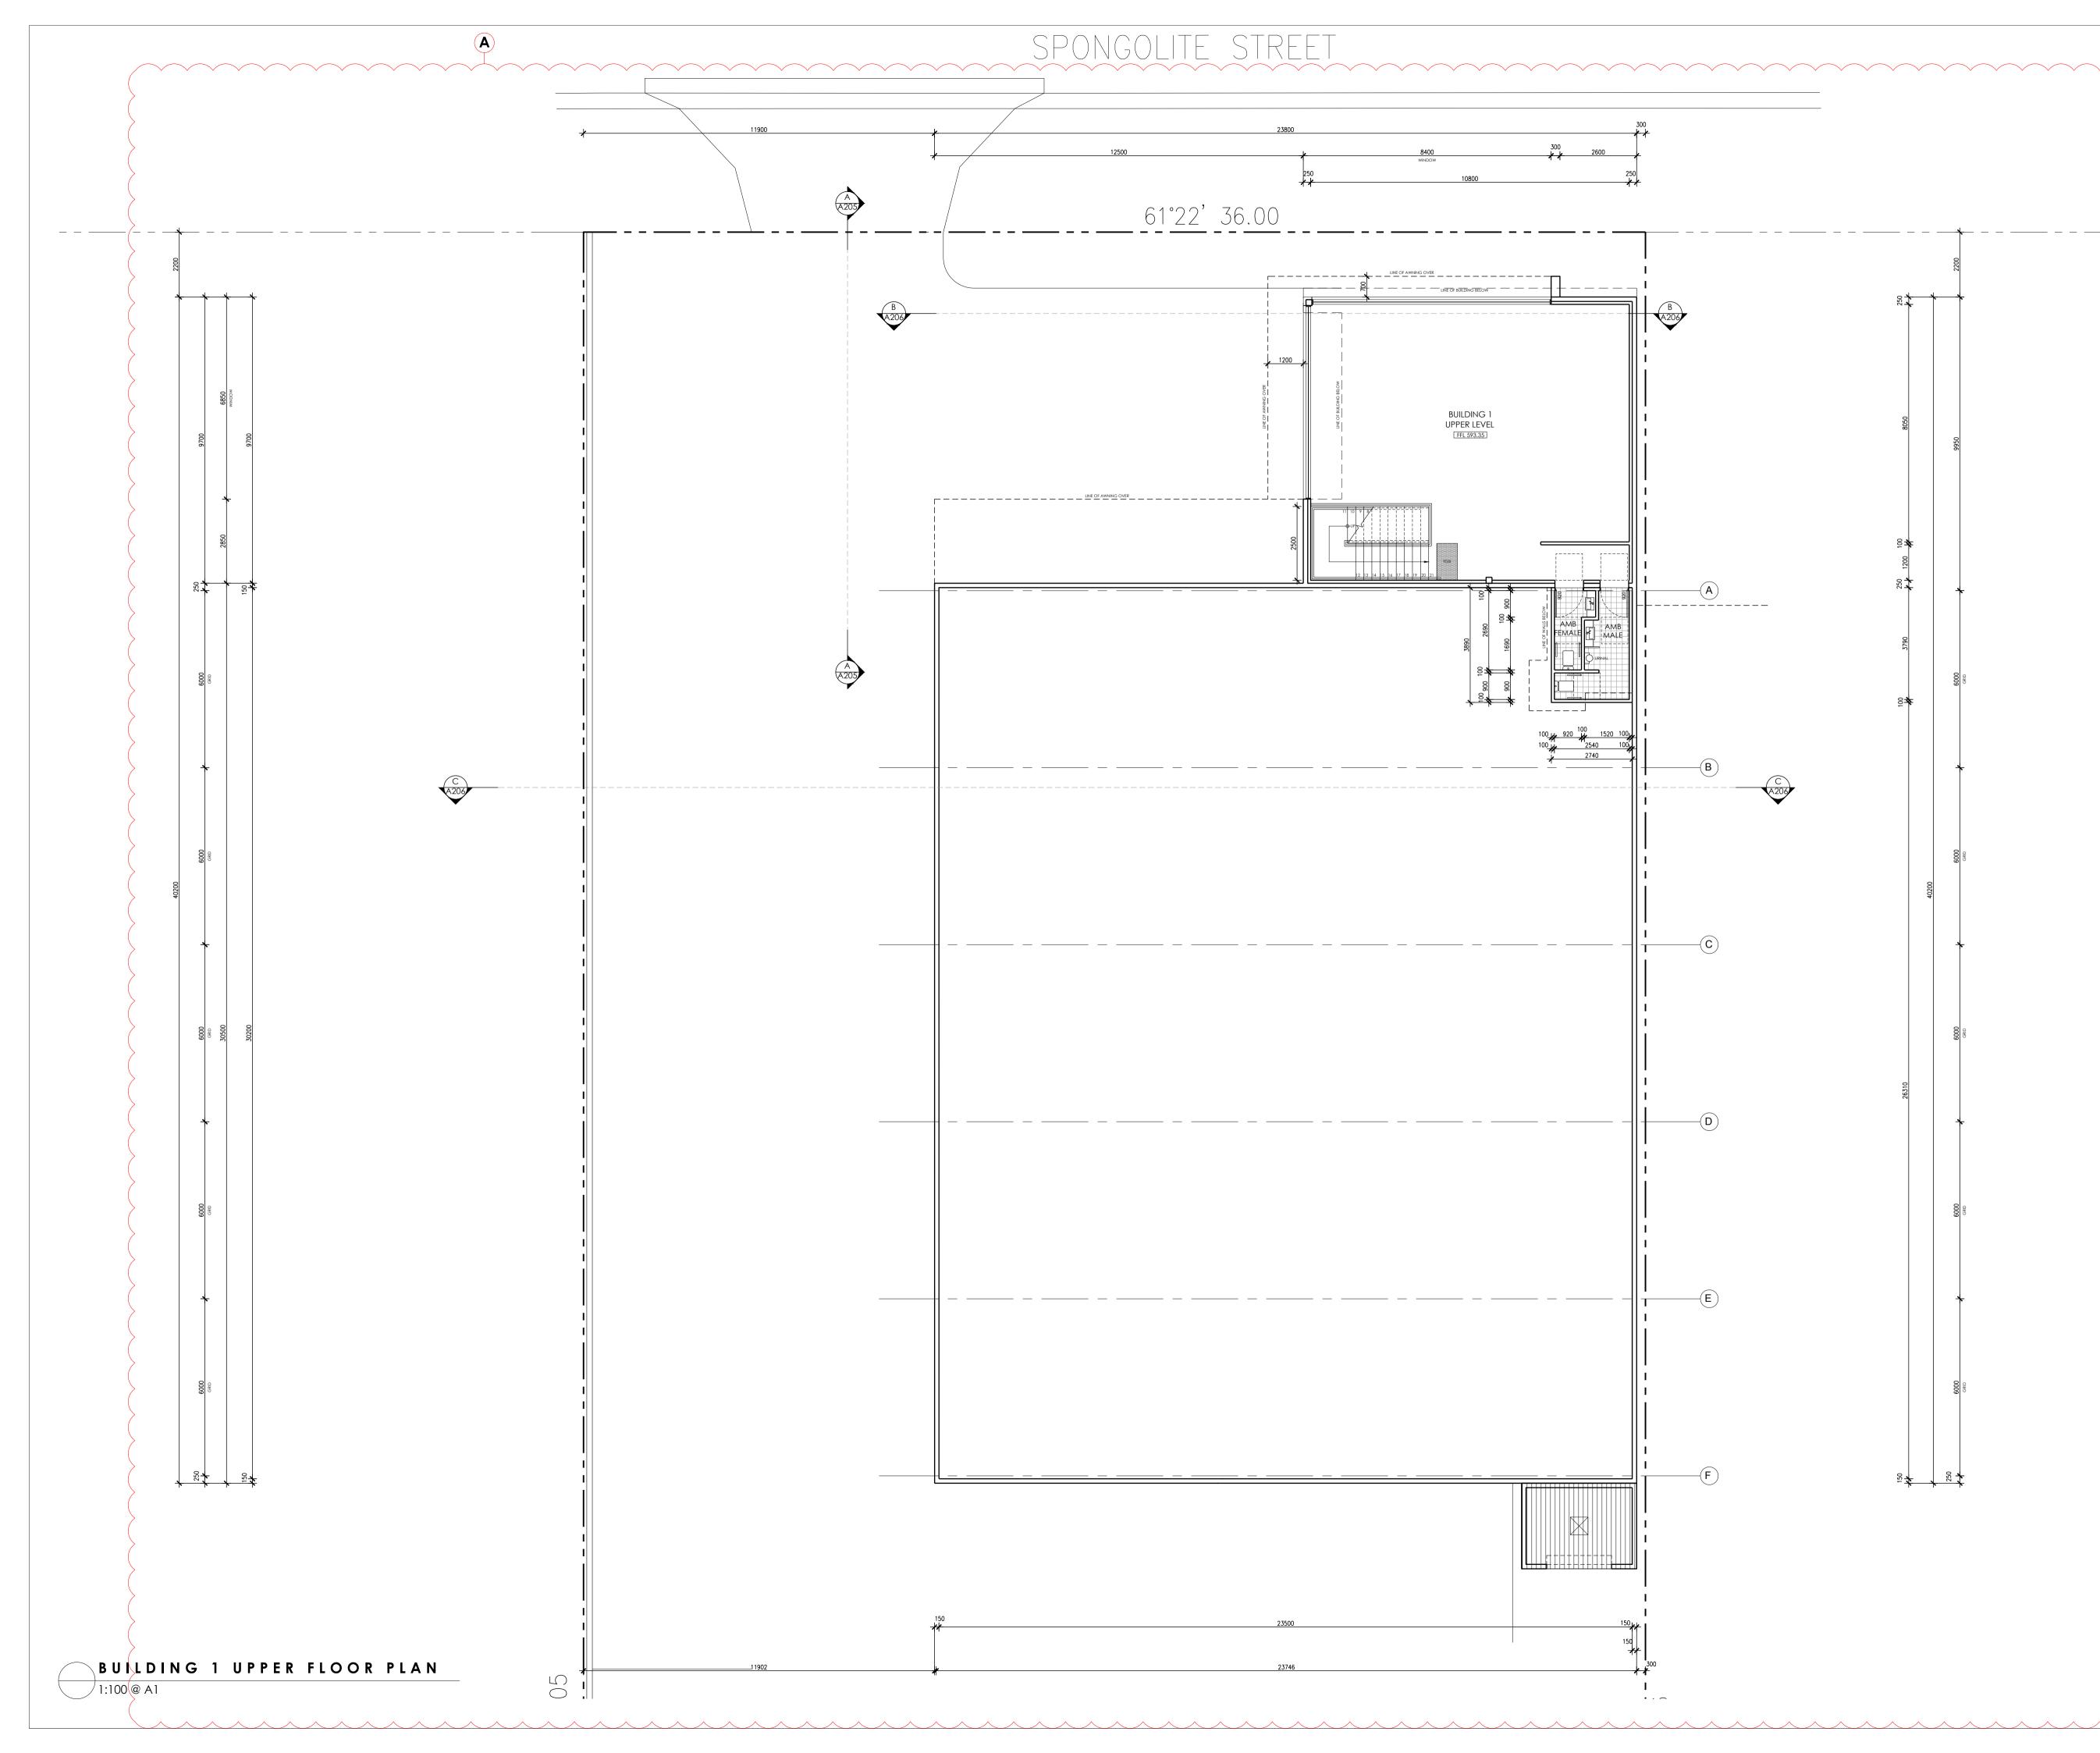


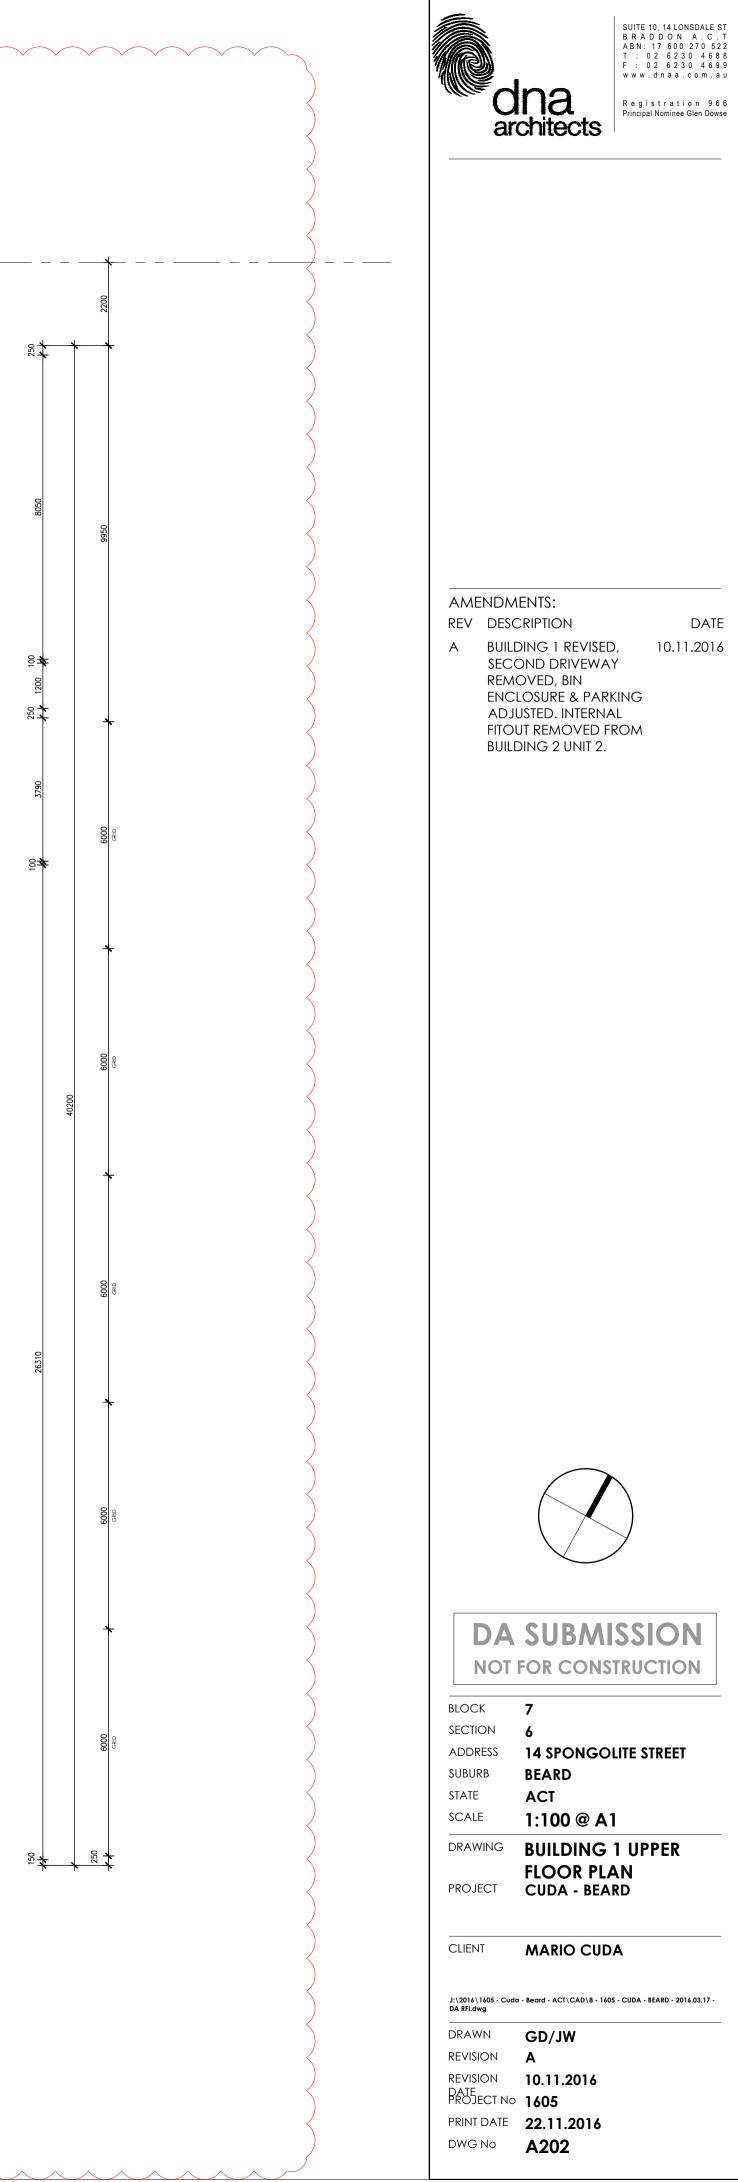SUITE 10, 14 LONSDALE ST B R A D D O N A . C . T ABN: 17 600 270 522 T : 02 6230 4688 F : 02 6230 4699 w w w . d n a a . c o m . a u dna architects Registration 966 Principal Nominee Glen Dowse AMENDMENTS: **REV DESCRIPTION** DATE A BUILDING 1 REVISED, 10.11.2016 SECOND DRIVEWAY REMOVED, BIN ENCLOSURE & PARKING ADJUSTED. INTERNAL FITOUT REMOVED FROM BUILDING 2 UNIT 2. **DA SUBMISSION** NOT FOR CONSTRUCTION BLOCK 7 SECTION 6 ADDRESS 14 SPONGOLITE STREET SUBURB BEARD STATE ACT SCALE 1:100 @ A1 DRAWING ROOF PLAN PROJECT CUDA - BEARD CLIENT MARIO CUDA J:\2016\1605 - Cuda - Beard - ACT\CAD\8 - 1605 - CUDA - BEARD - 2016.03.17 -DA RFI.dwg DRAWN GD/JW revision A REVISION 10.11.2016 PROJECT NO 1605 PRINT DATE 22.11.2016 DWG No **A203**

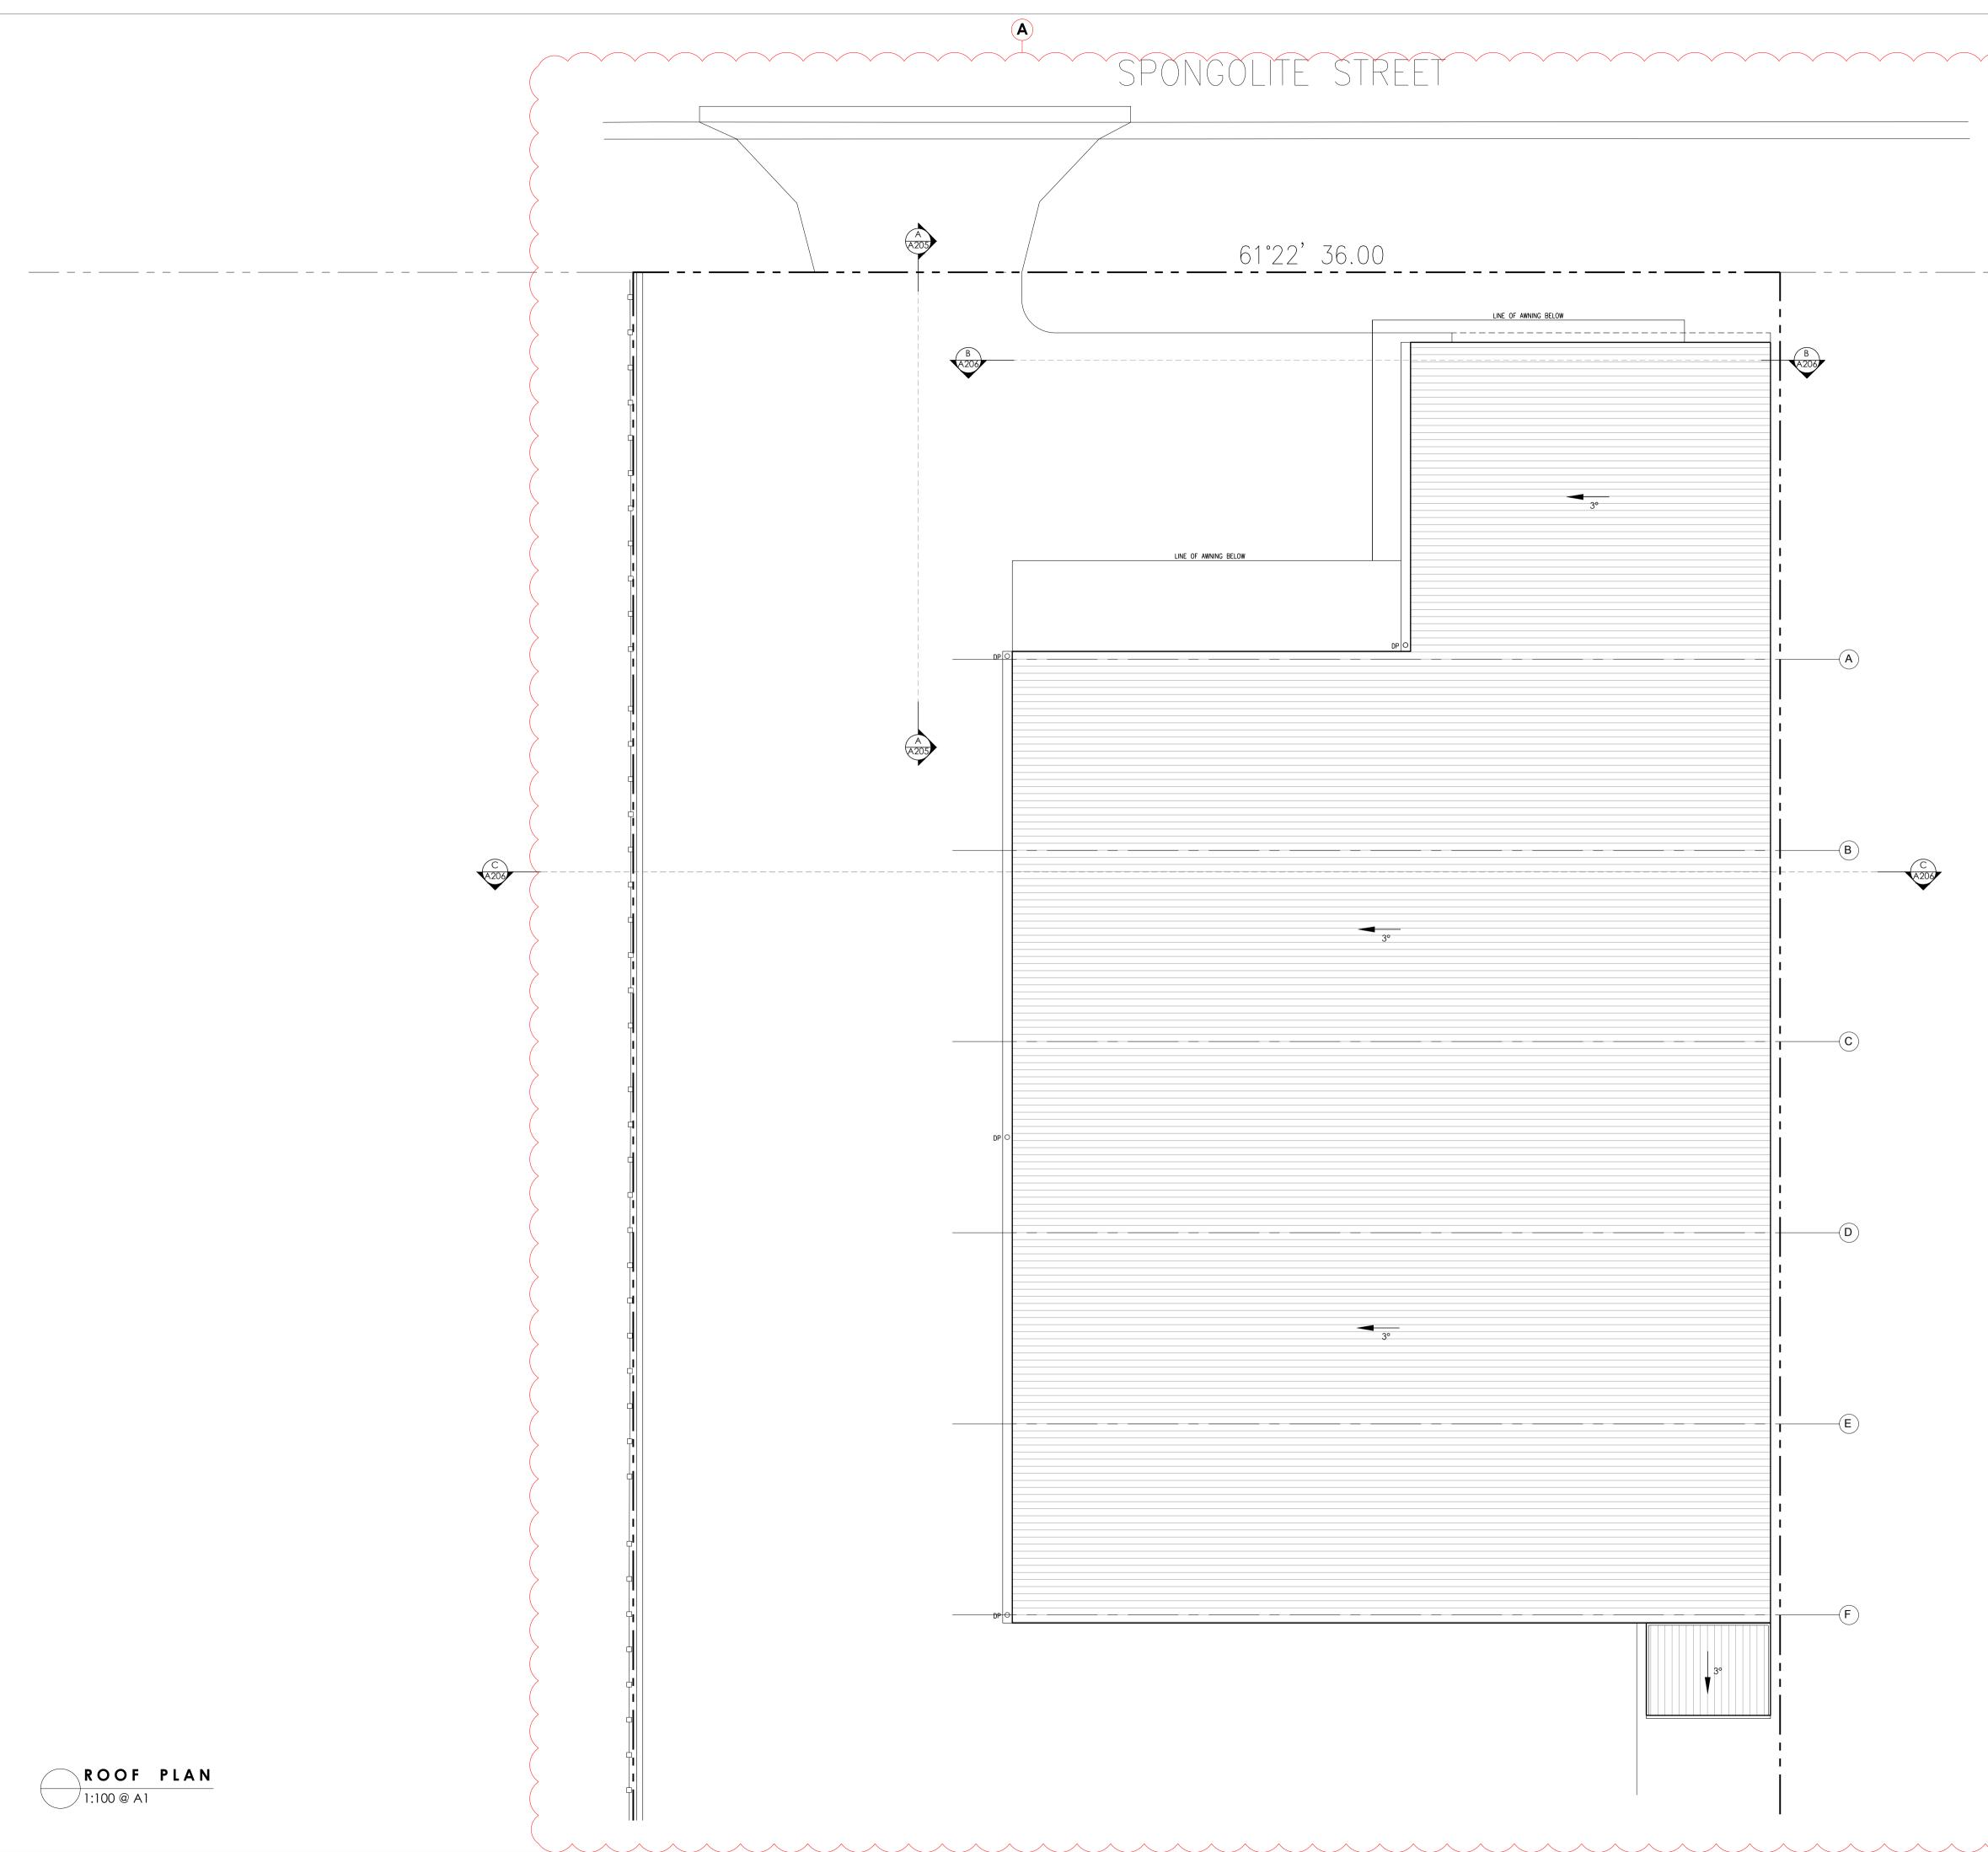

B1 NORTH WEST ELEVATION 1:100 @ A1

1.100 @ A1

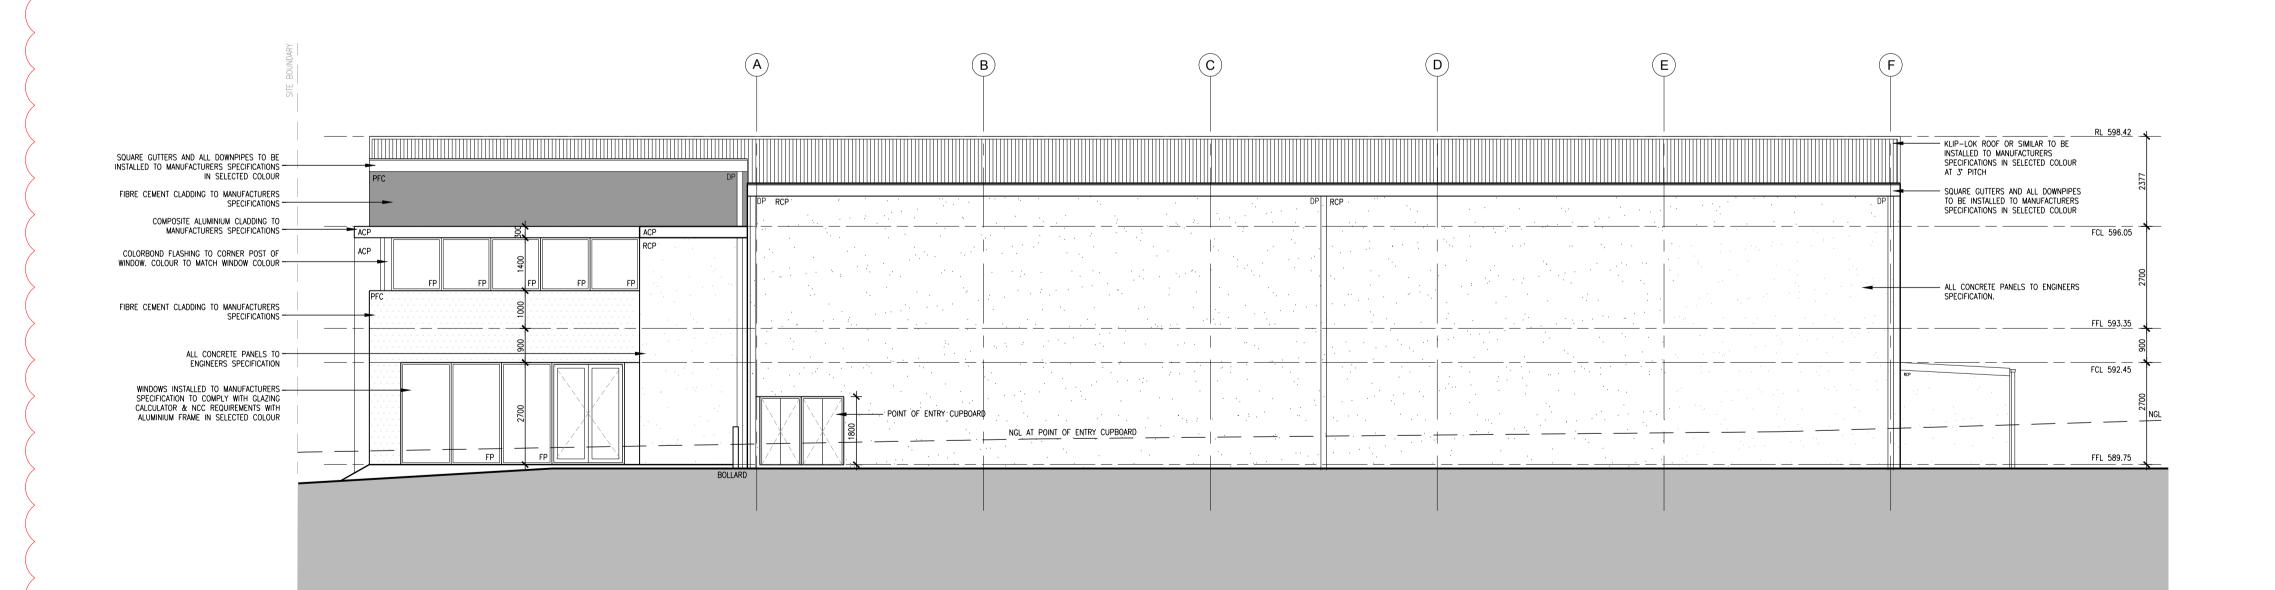


B1 SOUTH WEST ELEVATION

1:100 @ A1

SUITE 10, 14 LONSDALE ST B R A D D O N A . C . T ABN: 17 600 270 522 T : 02 6230 4688 F : 02 6230 4699 www.dnaa.com.au dna architects Registration 966 Principal Nominee Glen Dowse AMENDMENTS: **REV DESCRIPTION** DATE A BUILDING 1 REVISED, 10.11.2016 SECOND DRIVEWAY REMOVED, BIN ENCLOSURE & PARKING ADJUSTED. INTERNAL FITOUT REMOVED FROM BUILDING 2 UNIT 2. **DA SUBMISSION** NOT FOR CONSTRUCTION BLOCK 7 SECTION 6 ADDRESS 14 SPONGOLITE STREET SUBURB BEARD STATE ACT SCALE 1:100 @ A1 DRAWING BUILDING 1 ELEVATIONS PROJECT CUDA - BEARD CLIENT MARIO CUDA J:\2016\1605 - Cuda - Beard - ACT\CAD\8 - 1605 - CUDA - BEARD - 2016.03.17 - DA RFI.dwg DRAWN **GD/JW** LEGEND: REVISION A CONCRETE PANEL - PAINTED FINISH CONCRETE PANEL - RAW FINISH PCP REVISION **10.11.2016** RCP DATE PROJECT NO 1605 PFC RFC FIBRE CEMENT SHEET - PAINTED FINISH FIBRE CEMENT SHEET - RAW FINISH PRINT DATE 22.11.2016 COLORBOND CLADDING ALUMINIUM COMPOSITE PANEL CC ACP DWG No **A204**

<u>RL 598.4</u>2 SQUARE GUTTERS AND ALL DOWNPIPES TO BE INSTALLED TO MANUFACTURERS SPECIFICATIONS IN SELECTED COLOUR _____ FCL 596.05 ALL CONCRETE PANELS TO ENGINEERS _ SPECIFICATION _____ ROLLER DOOR TO MANUFACTURERS SPECIFICATIONS _ ____ FCL 592.45 STEEL CLAD SOLID CORE TIMBER DOOR _ TO MANUFACTURERS SPECIFICATIONS BOLLARDS TO BE INSTALLED TO ______ MANUFACTURERS SPECIFICATIONS 589.7 _____


B1 SOUTH EAST ELEVATION / 1:100 @ A1

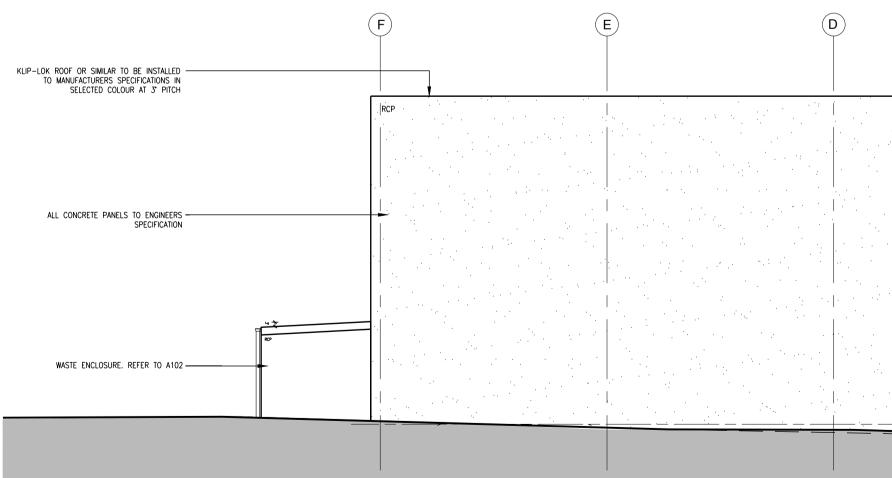


B1 NORTH EAST ELEVATION


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RCP			




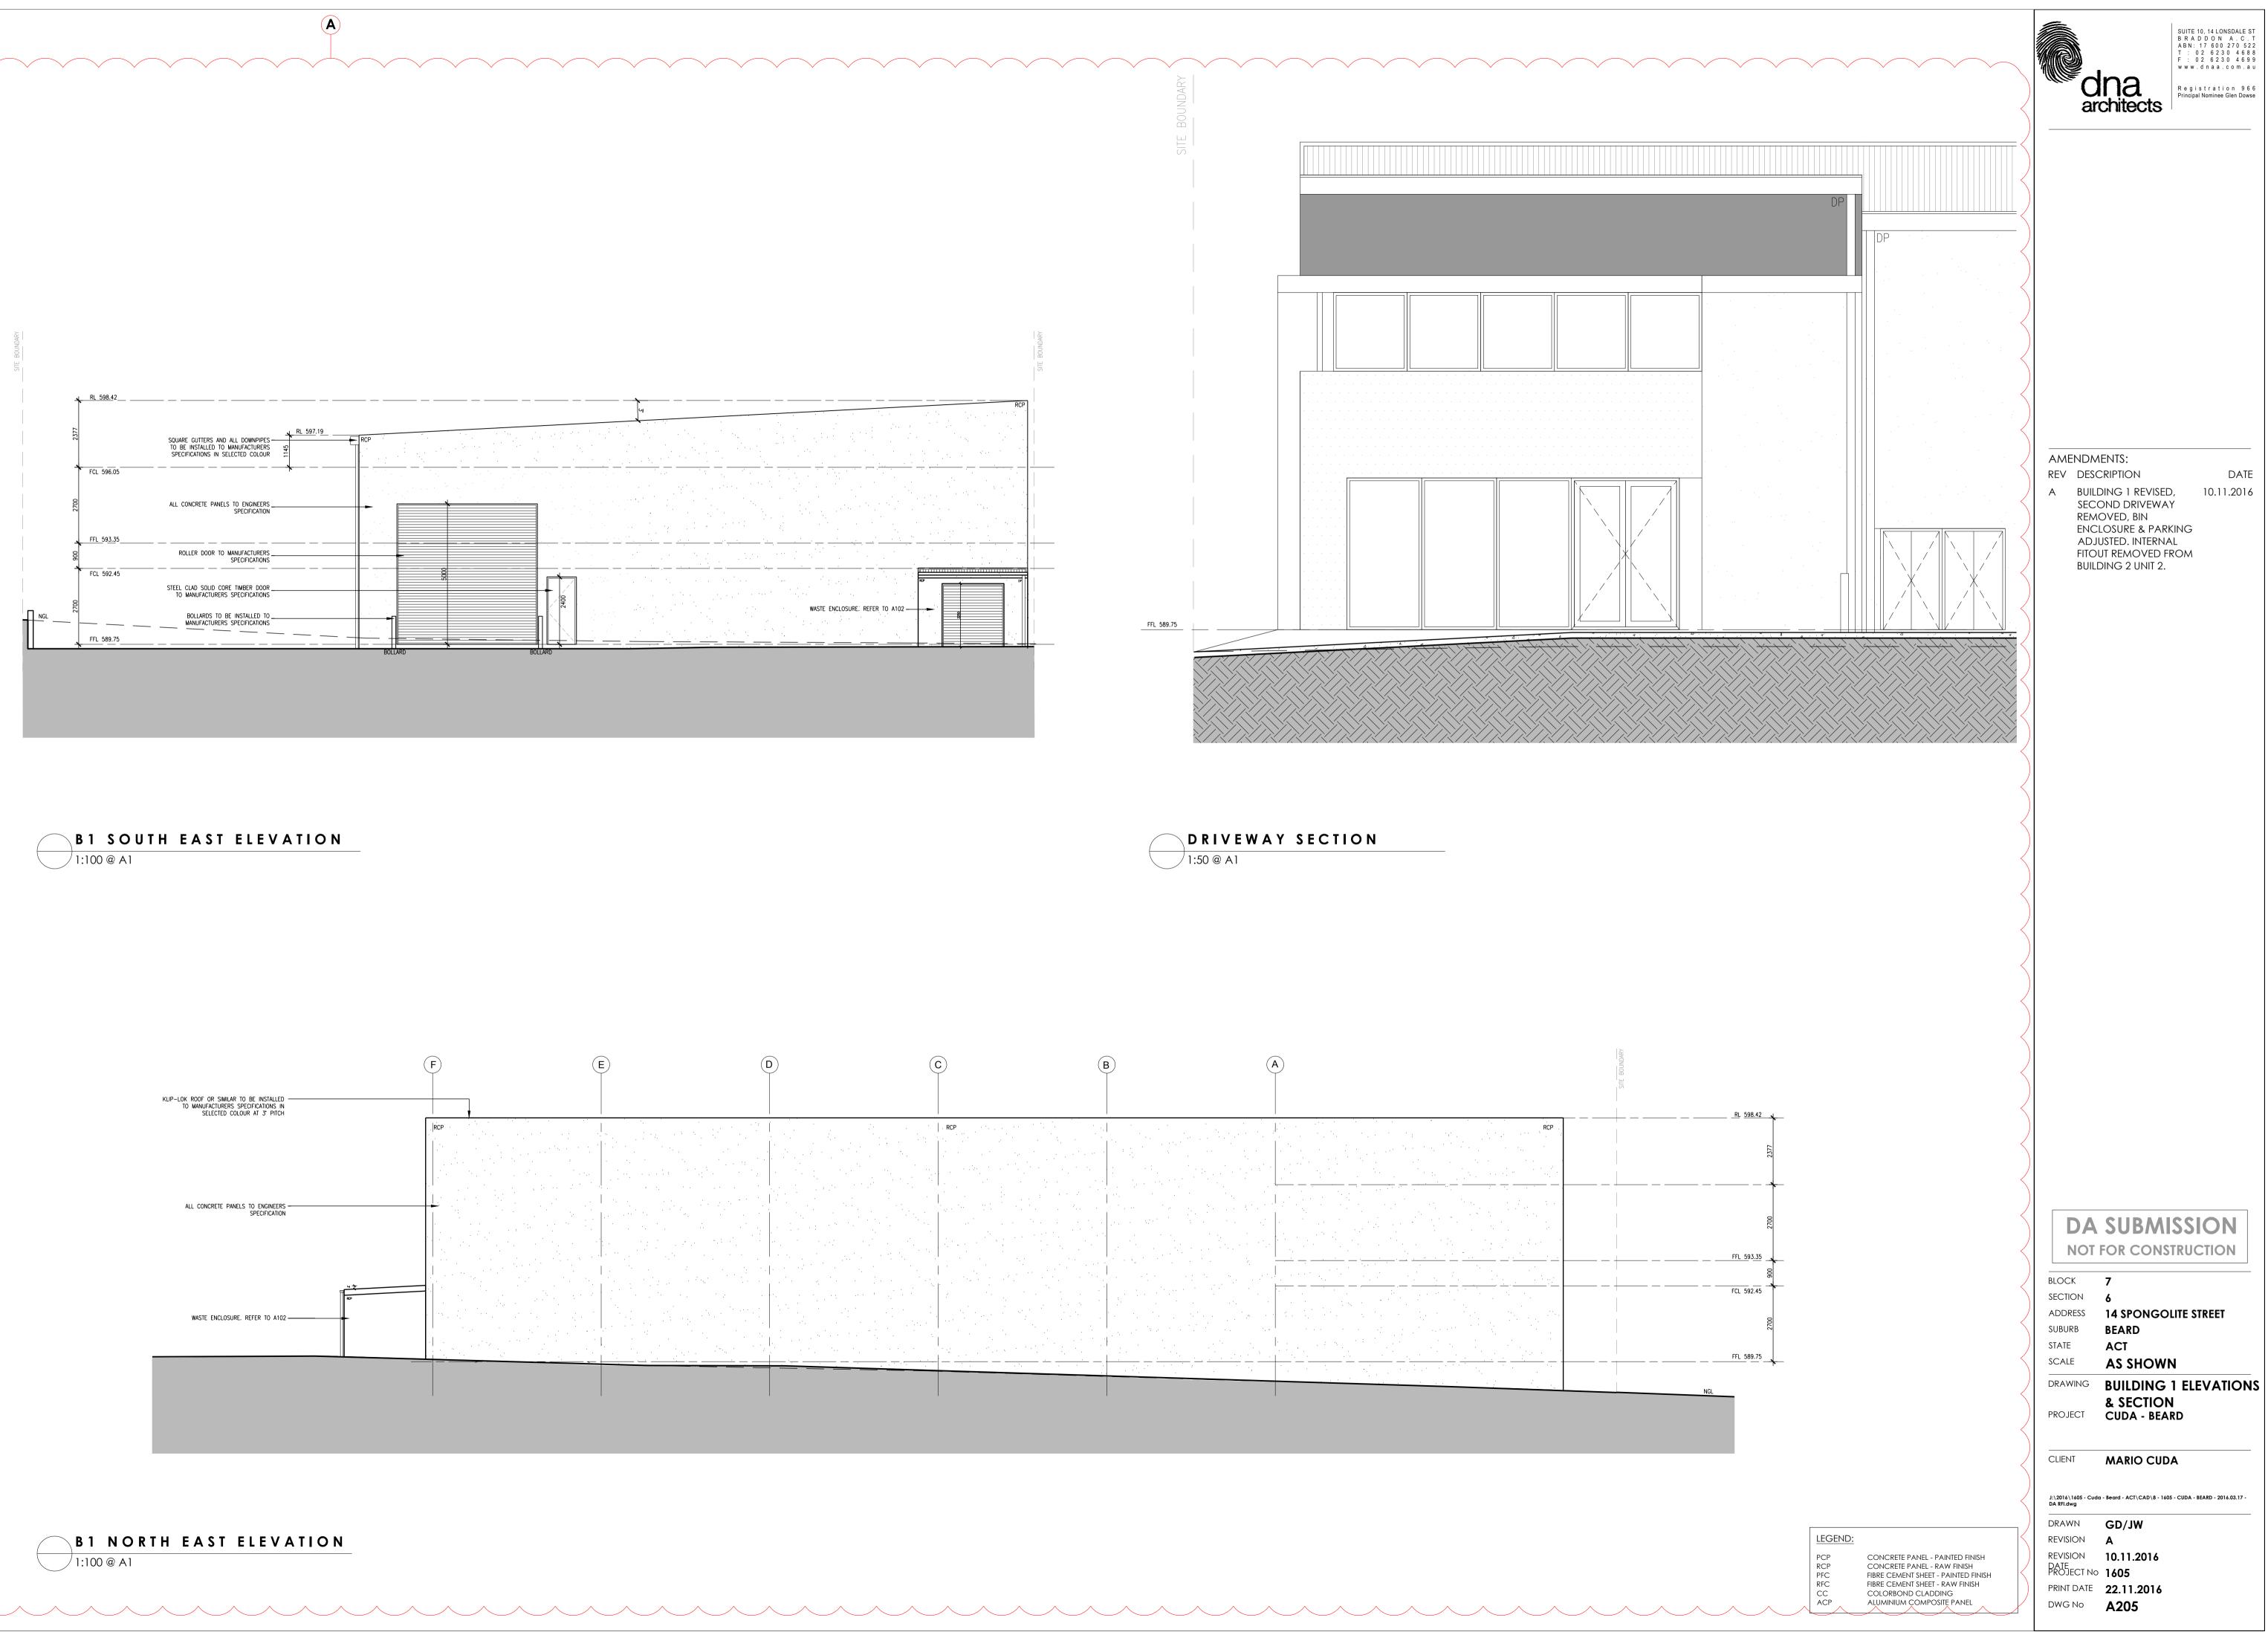



BUILDING 1 SECTION C

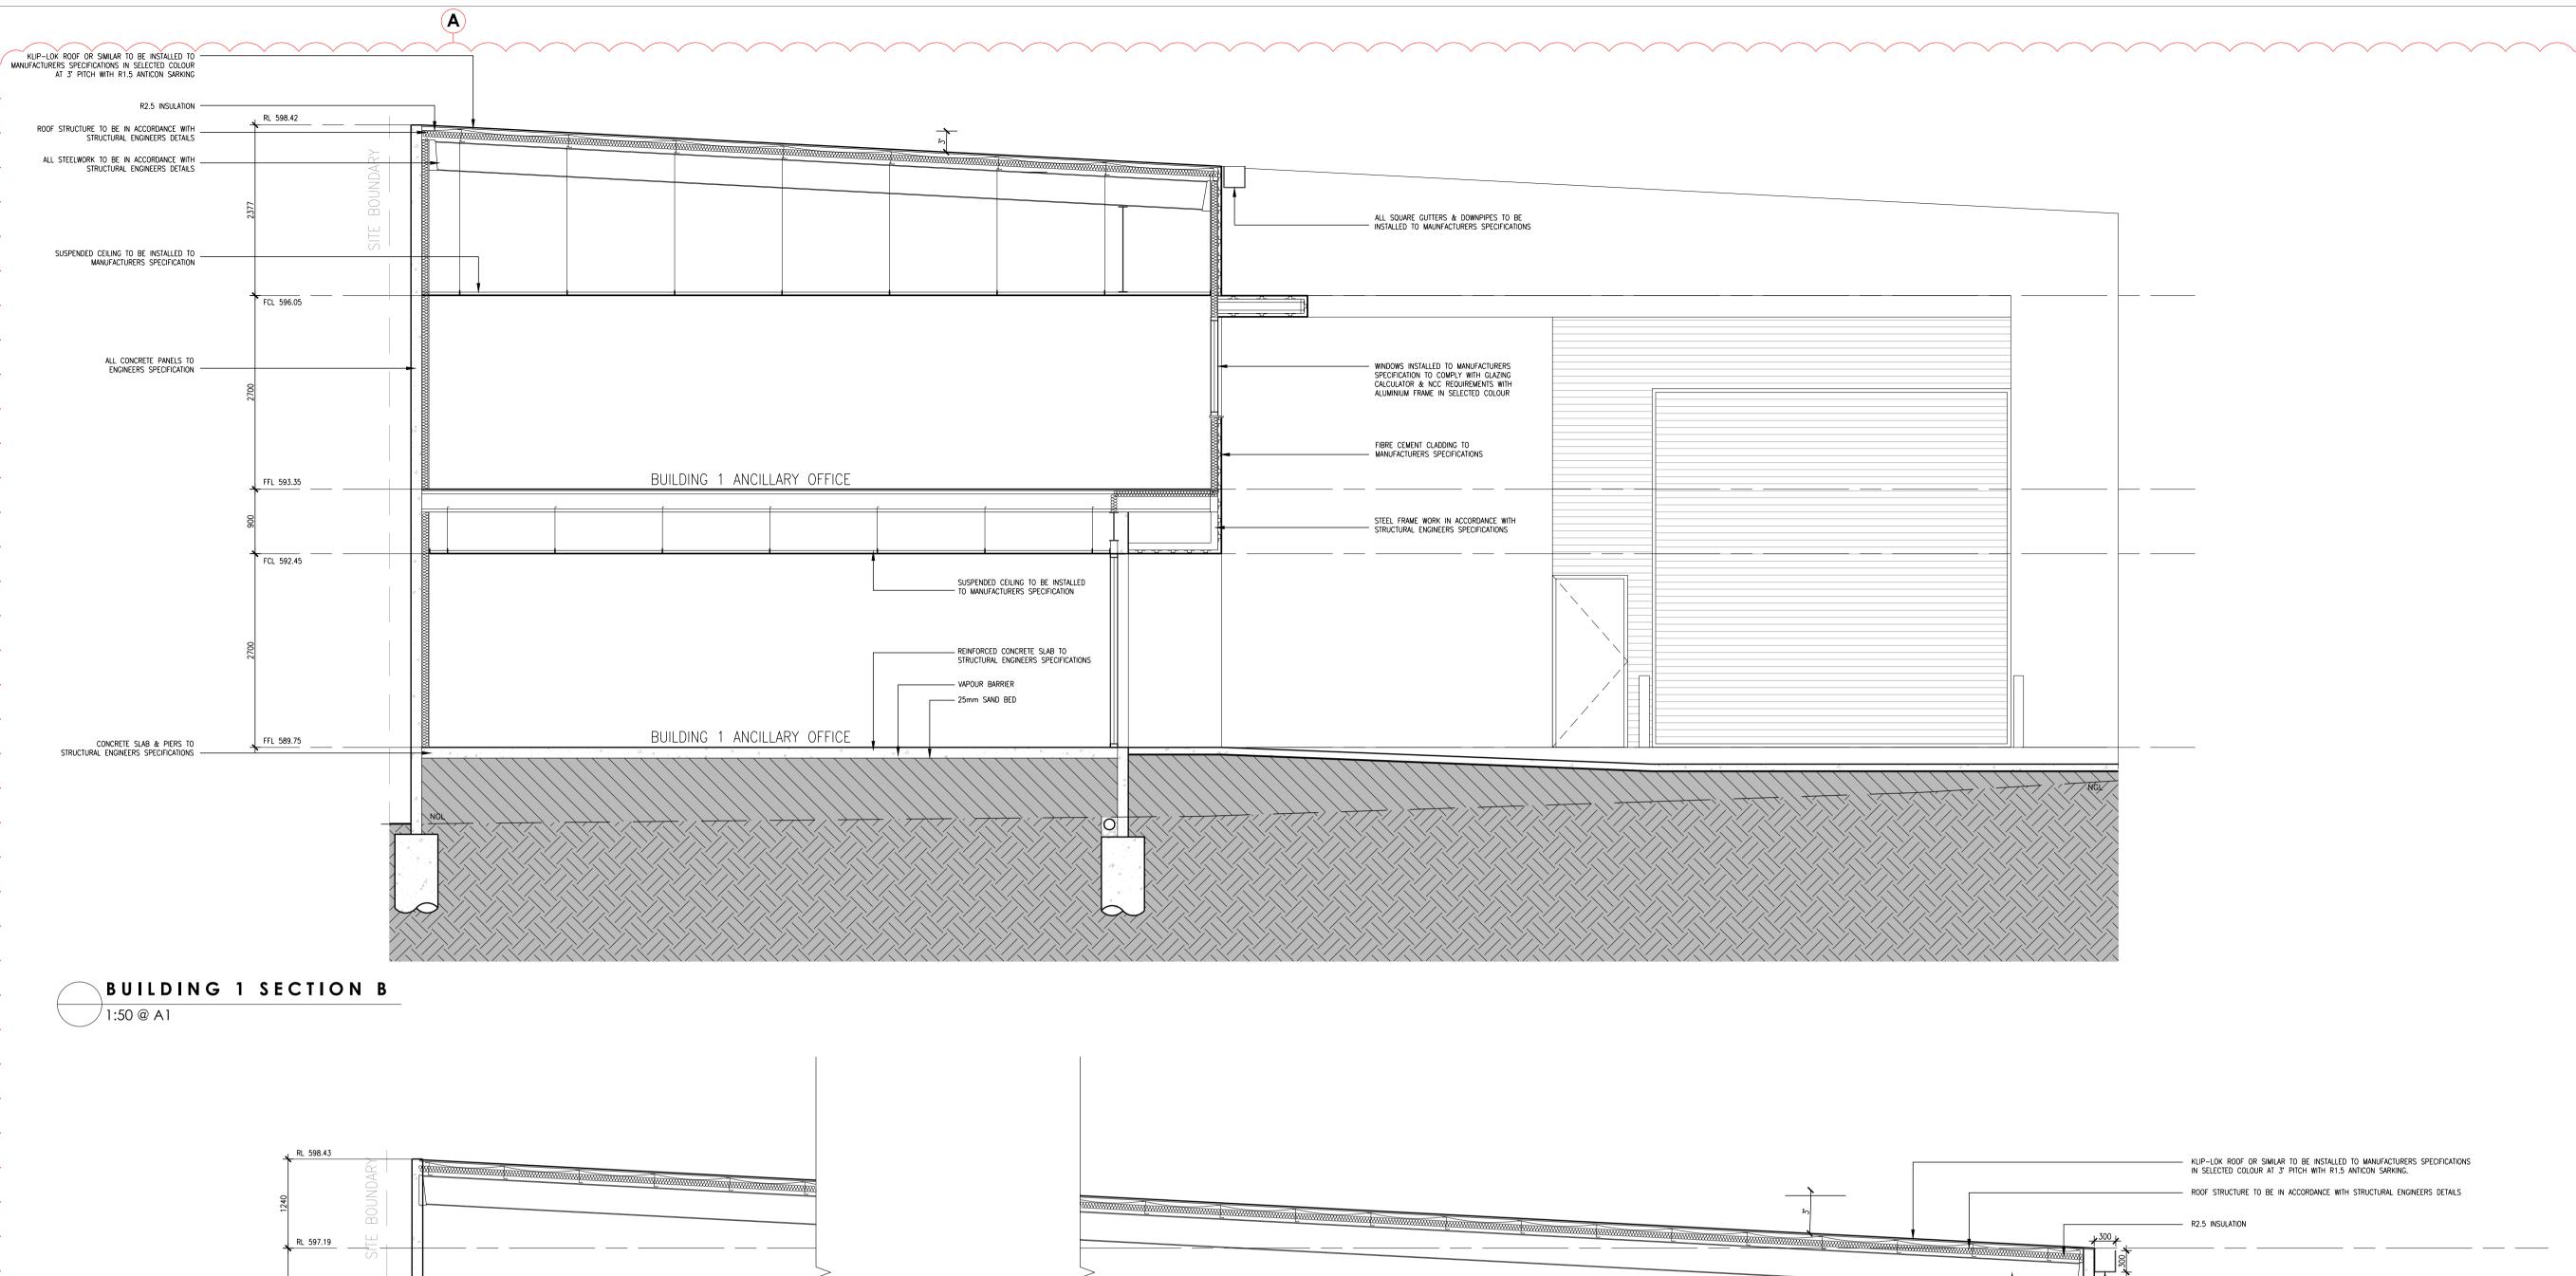/1:50 @ A1

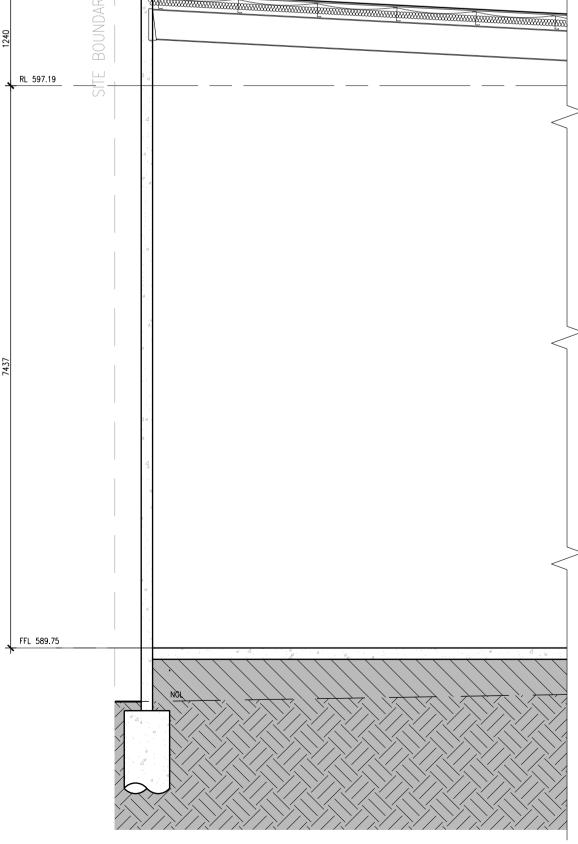
	ALL SQUARE GUTTERS & DOWNPIPES TO BE INSTALLED TO MAUNFACTURERS SPECIFICATIONS	
	WINDOWS INSTALLED TO MANUFACTURERS SPECIFICATION TO COMPLY WITH GLAZING CALCULATOR & NCC REQUIREMENTS WITH ALUMINIUM FRAME IN SELECTED COLOUR	
	FIBRE CEMENT CLADDING TO MANUFACTURERS SPECIFICATIONS	
	STEEL FRAME WORK IN ACCORDANCE WITH STRUCTURAL ENGINEERS SPECIFICATIONS	
NS		

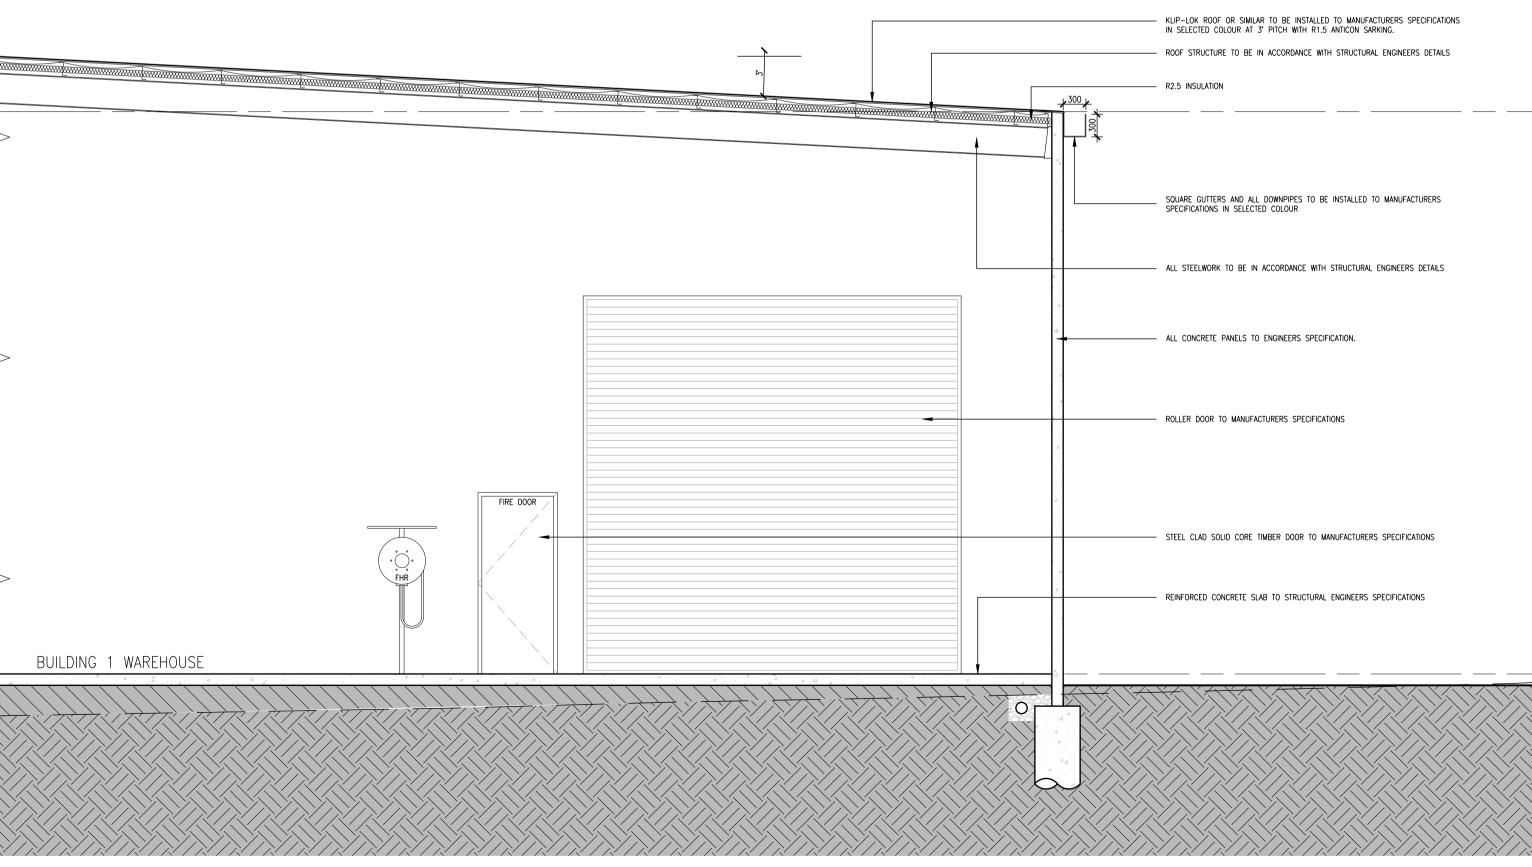


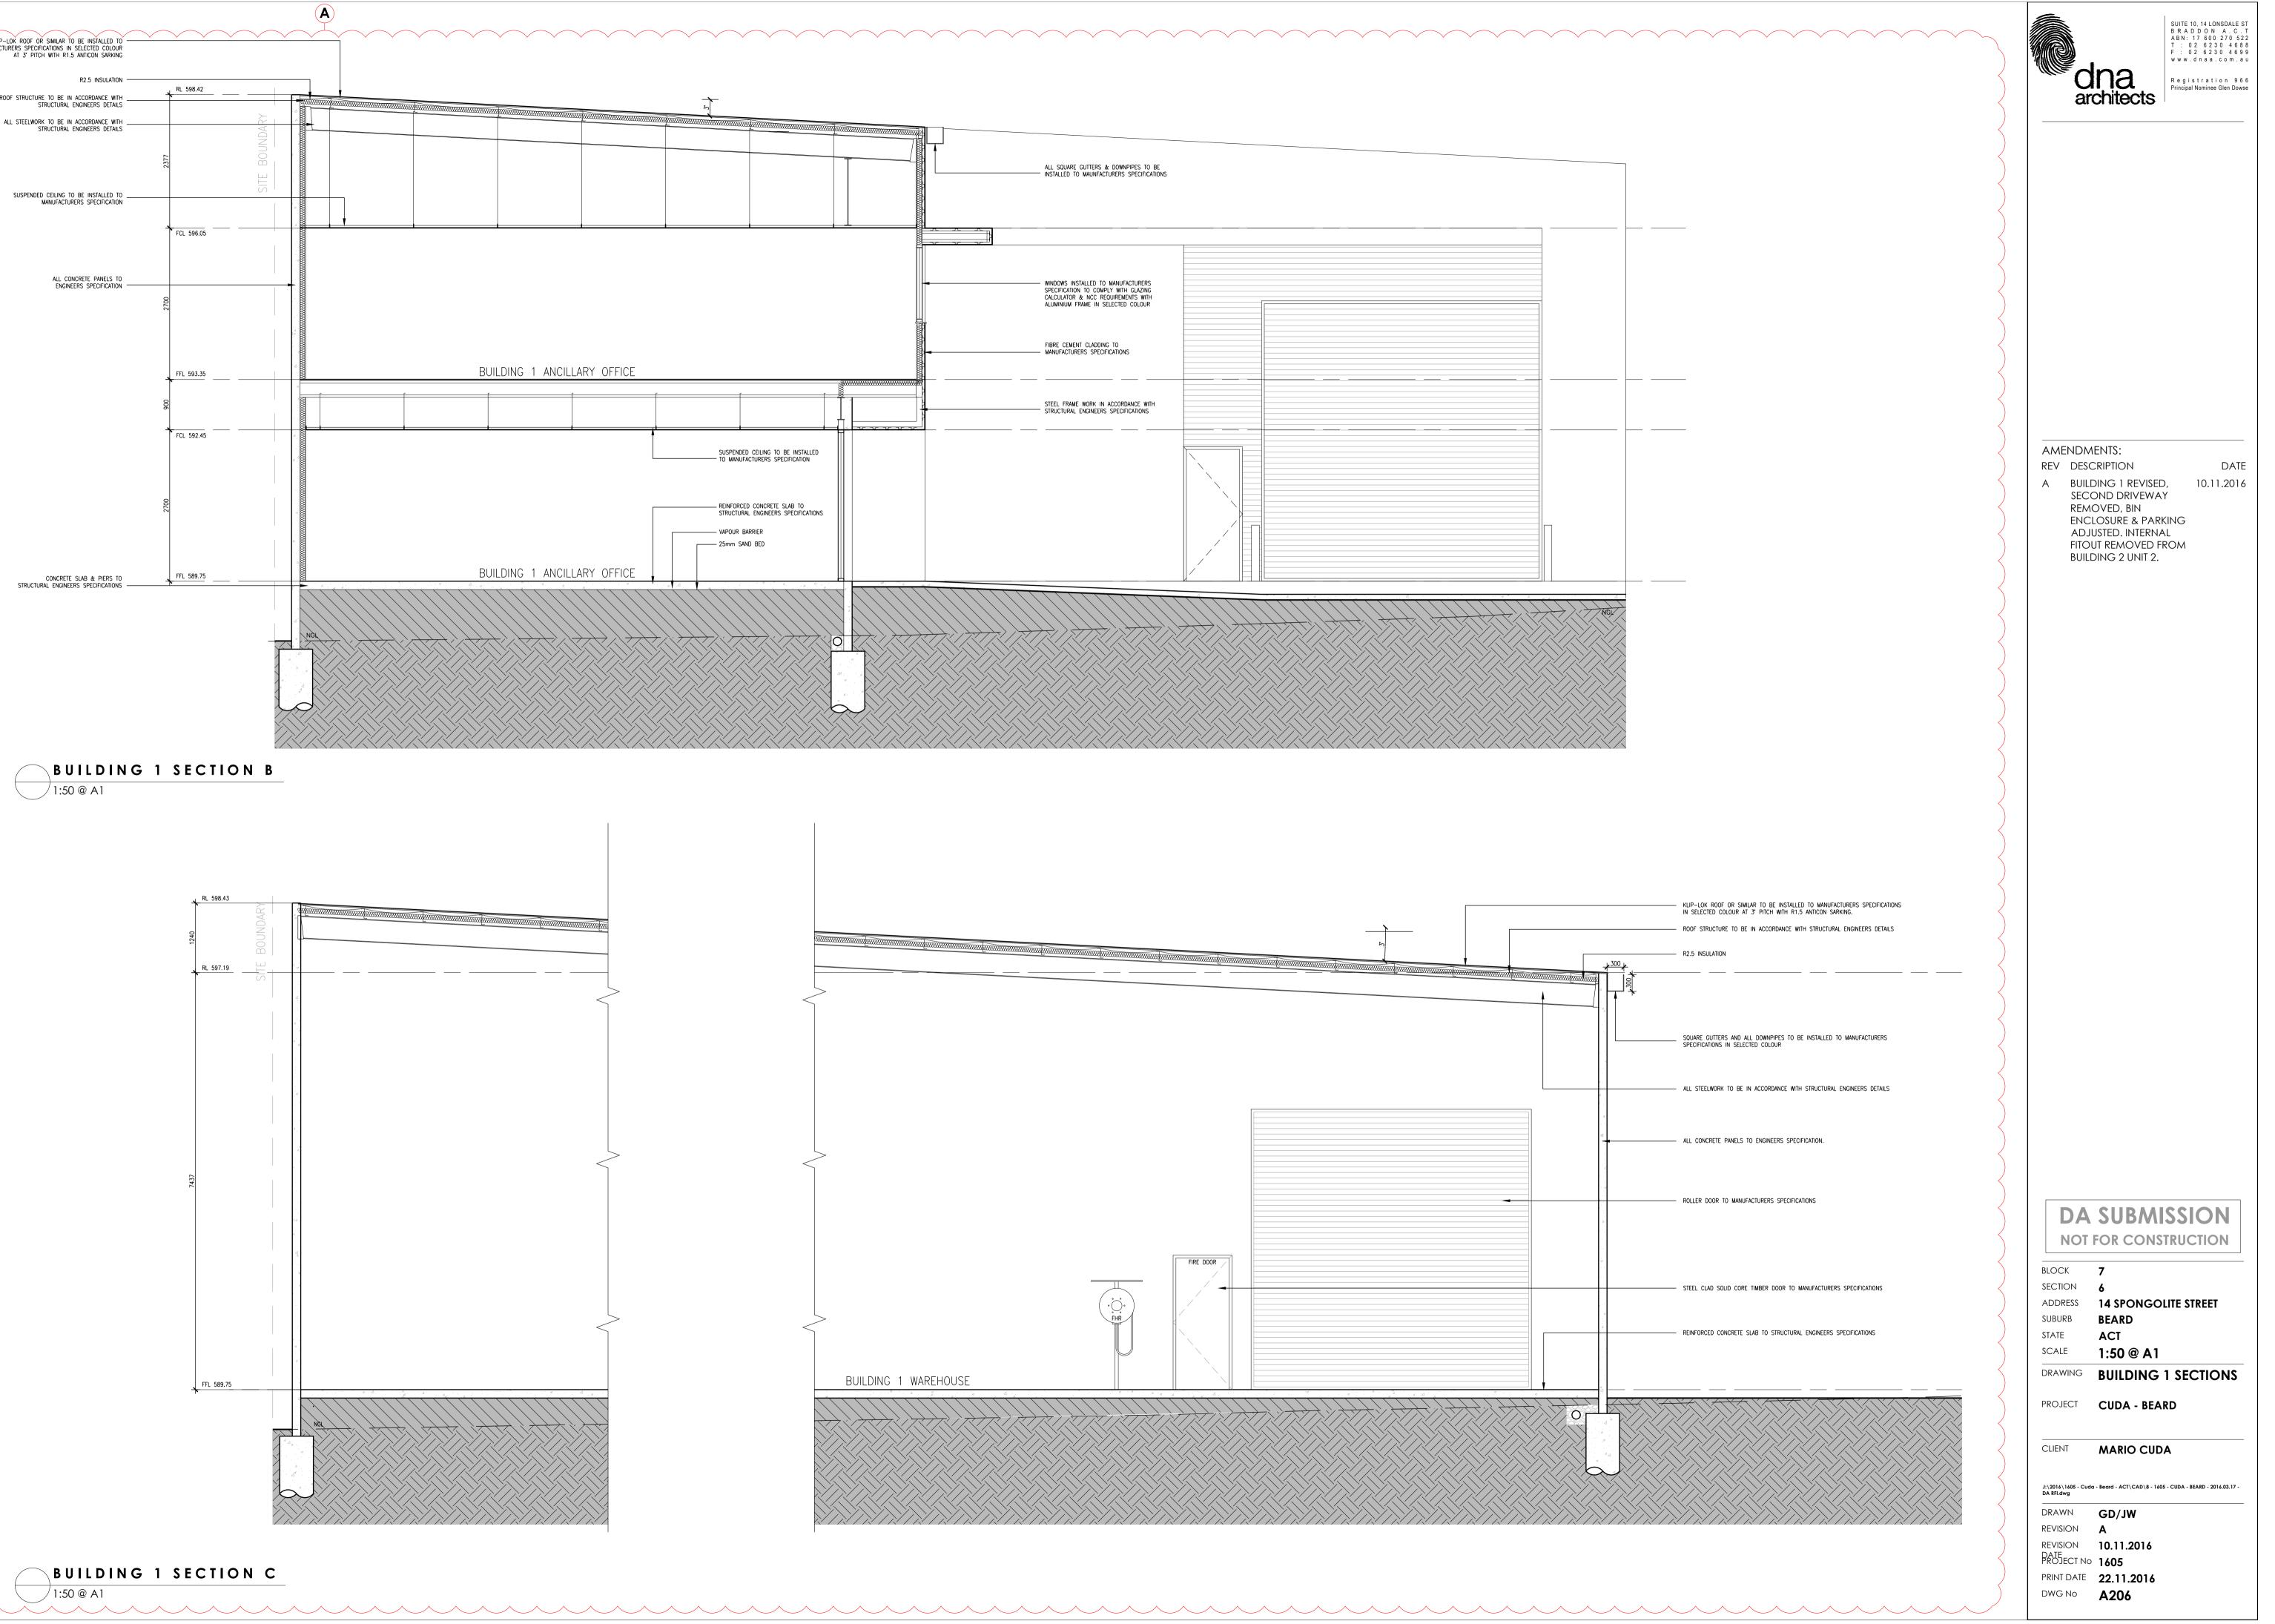

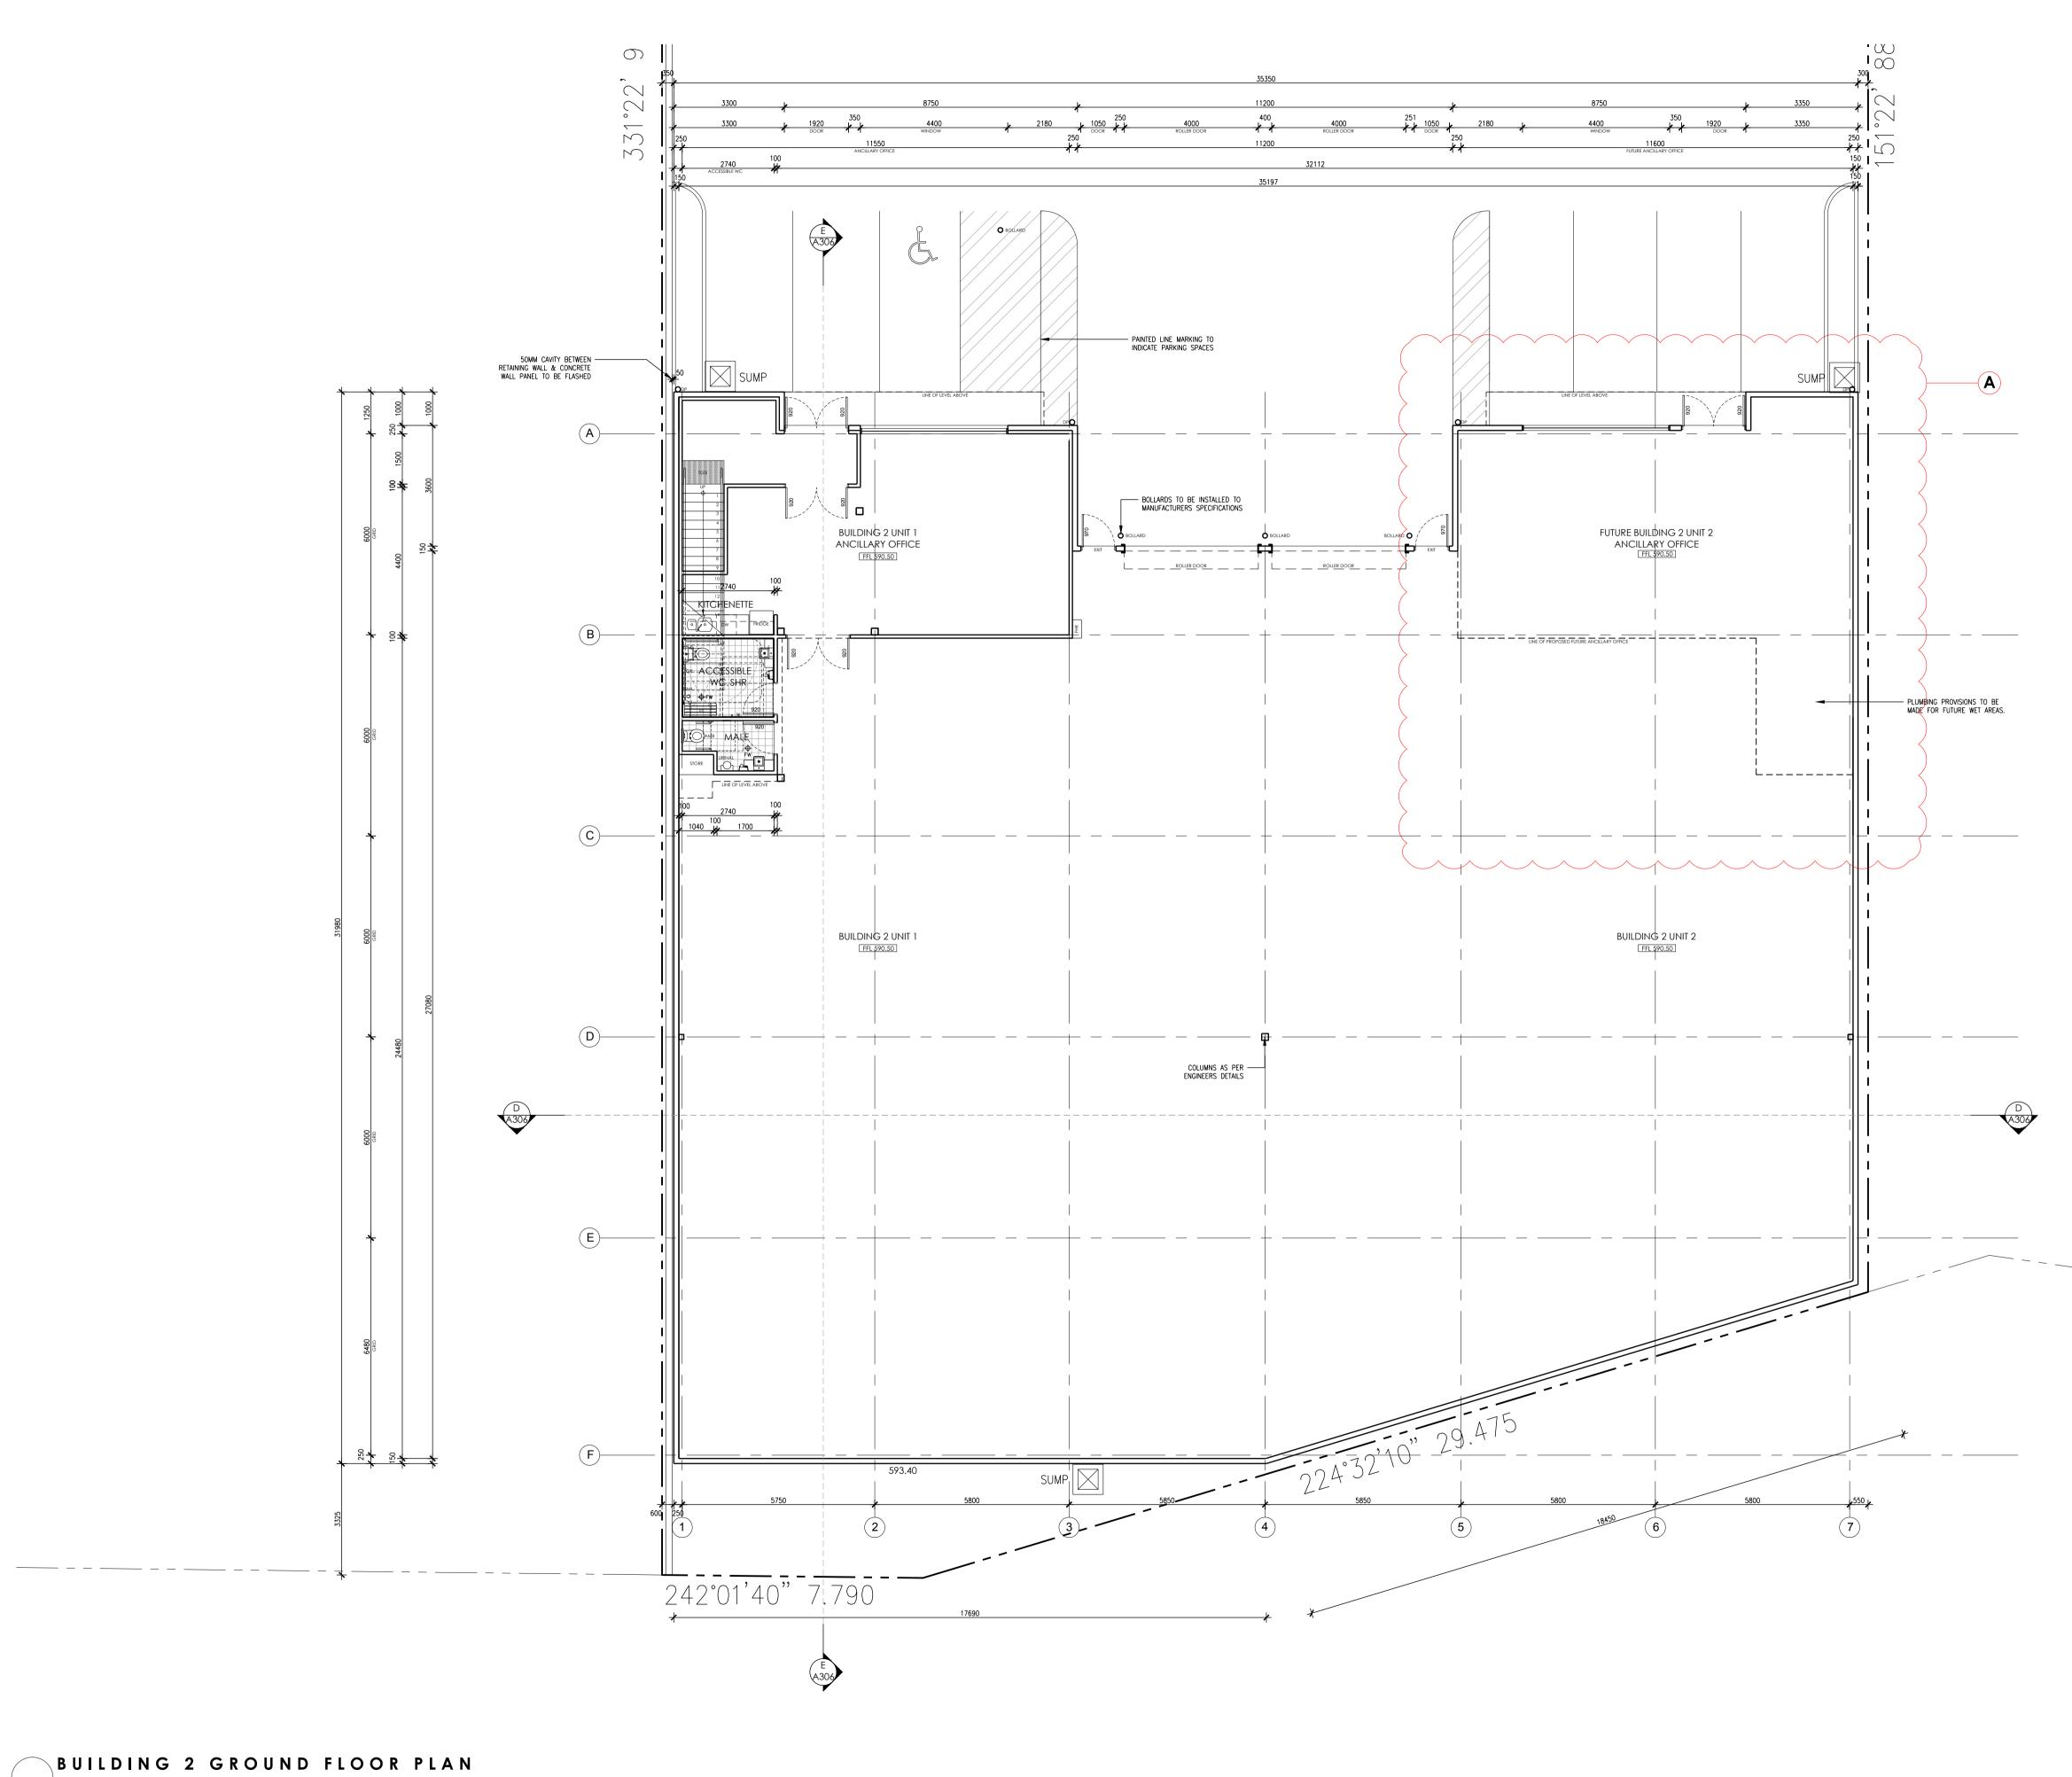



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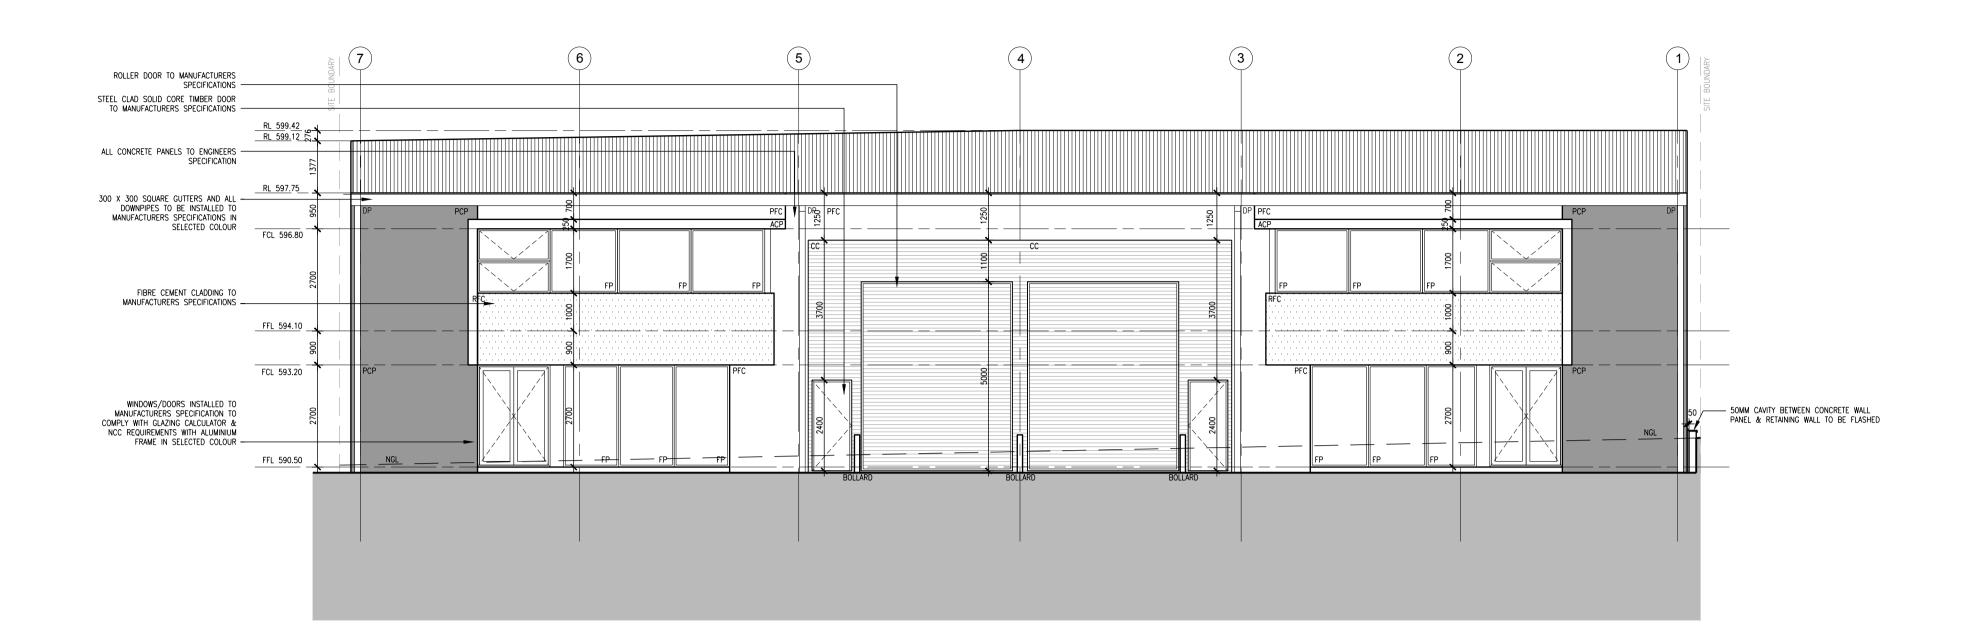

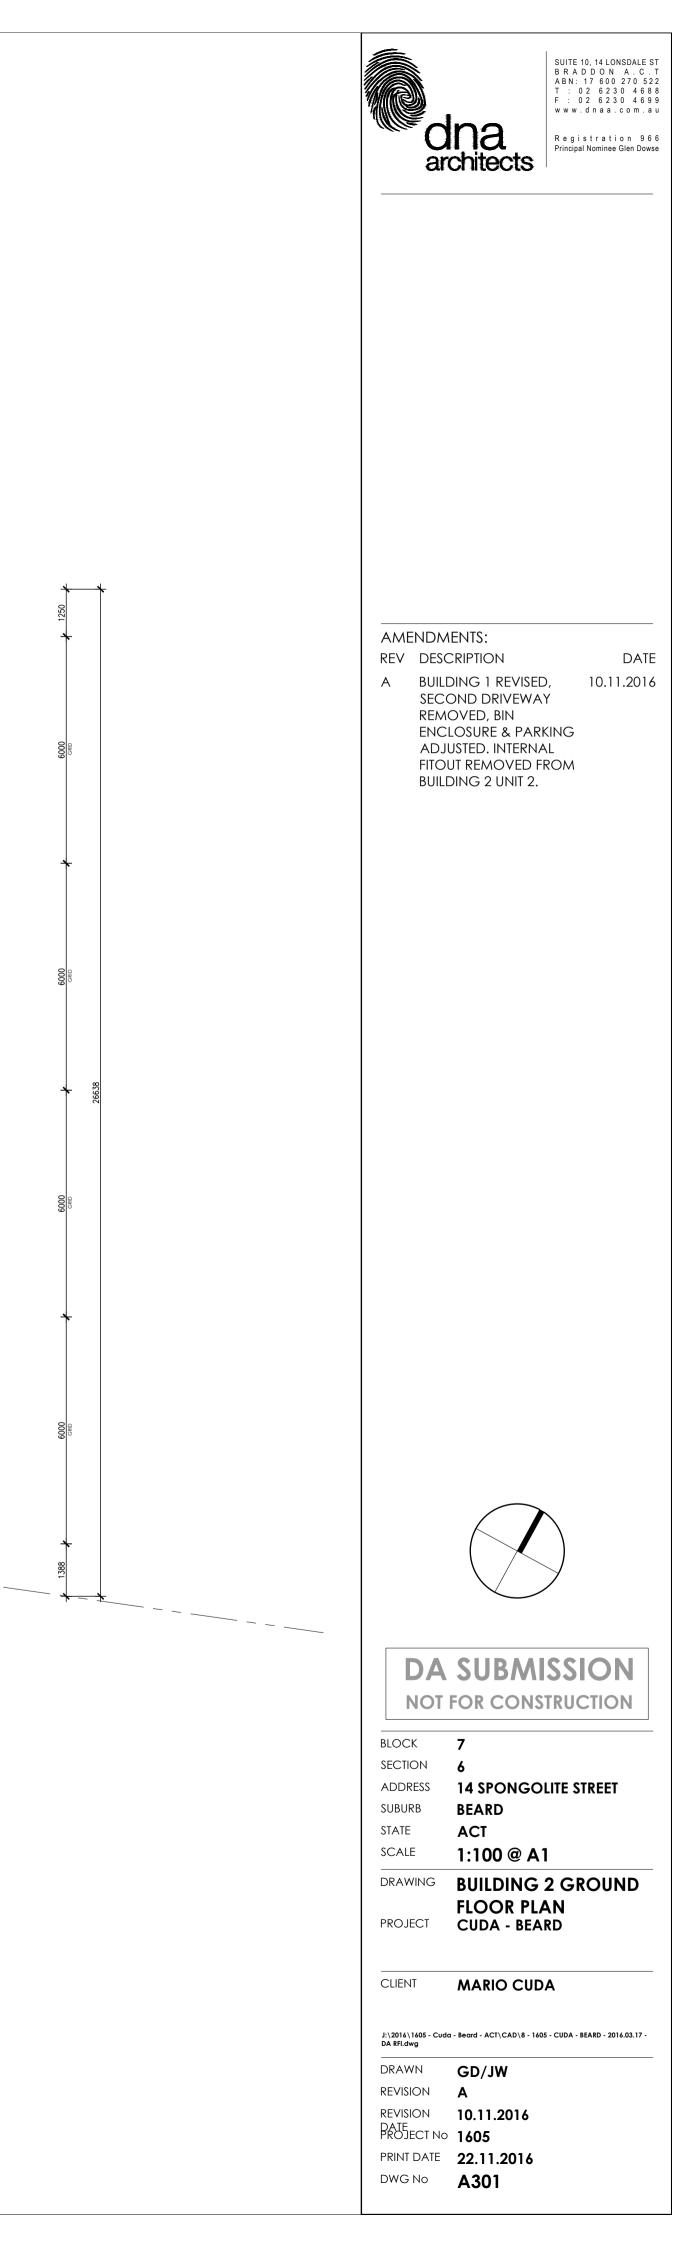
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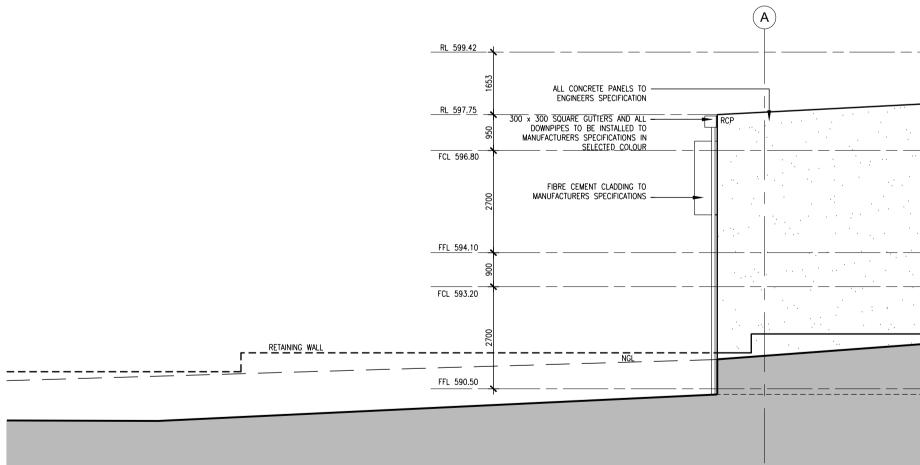


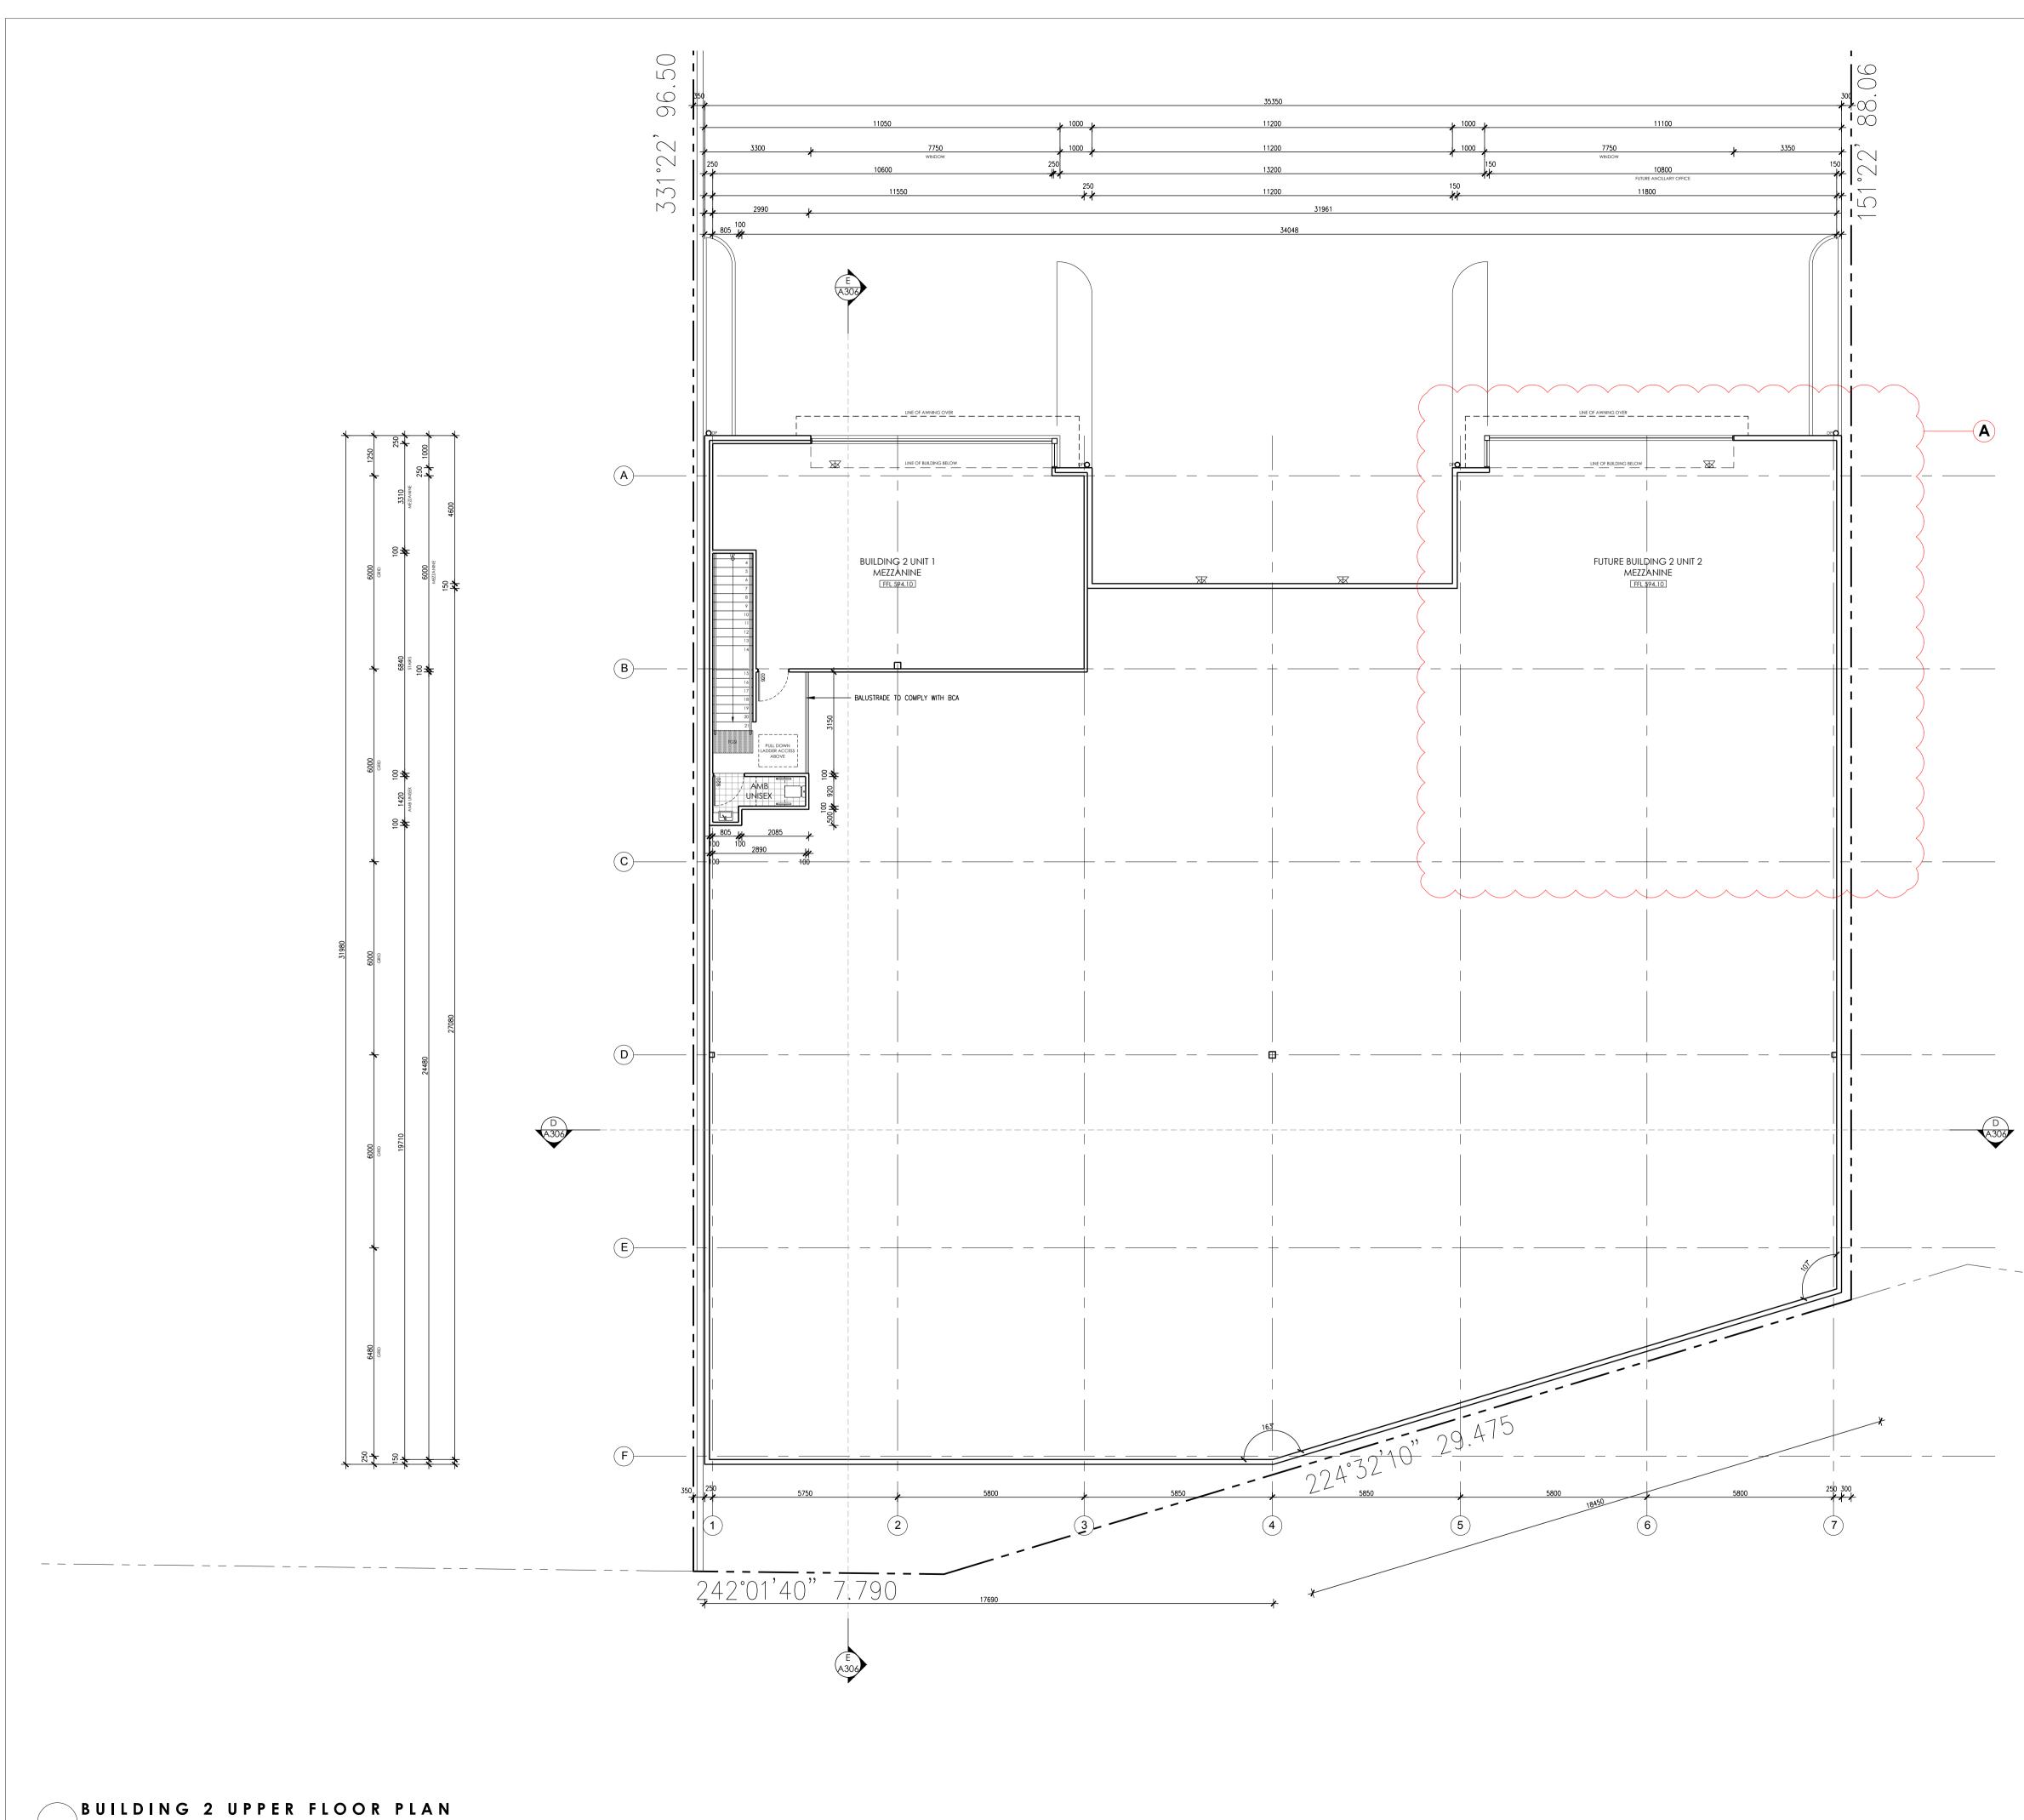

SUITE 10, 14 LONSDALE ST B R A D D O N A . C . T ABN: 17 600 270 522 T : 02 6230 4688 F : 02 6230 4699 www.dnaa.com.au dna architects Registration 966 Principal Nominee Glen Dowse AMENDMENTS: **REV DESCRIPTION** DATE A BUILDING 1 REVISED, SECOND DRIVEWAY REMOVED, BIN ENCLOSURE & PARKING ADJUSTED. INTERNAL FITOUT REMOVED FROM BUILDING 2 UNIT 2 10.11.2016 BUILDING 2 UNIT 2. **DA SUBMISSION** NOT FOR CONSTRUCTION BLOCK 7 SECTION 6 ADDRESS 14 SPONGOLITE STREET SUBURB BEARD STATE ACT SCALE 1:100@A1 DRAWING ROOF PLAN PROJECT CUDA - BEARD CLIENT MARIO CUDA J:\2016\1605 - Cuda - Beard - ACT\CAD\8 - 1605 - CUDA - BEARD - 2016.03.17 -DA RFI.dwg DRAWN GD/JW REVISION REVISION PROJECT NO **1605** PRINT DATE **22.11.2016** DWG No **A303**

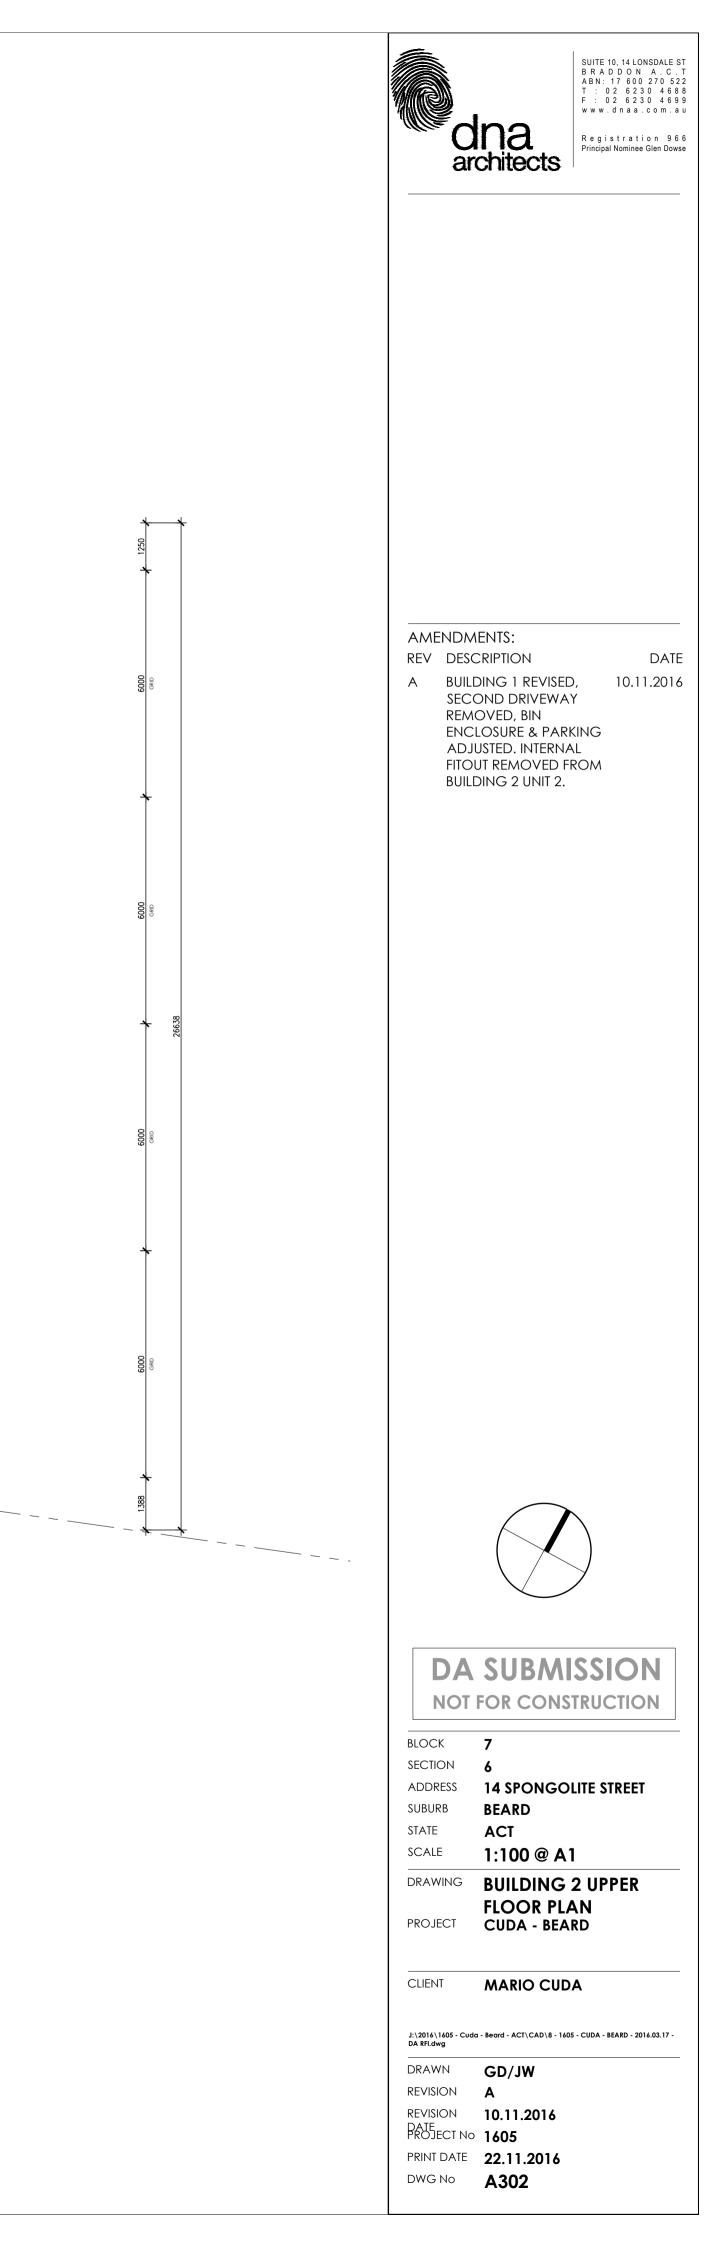

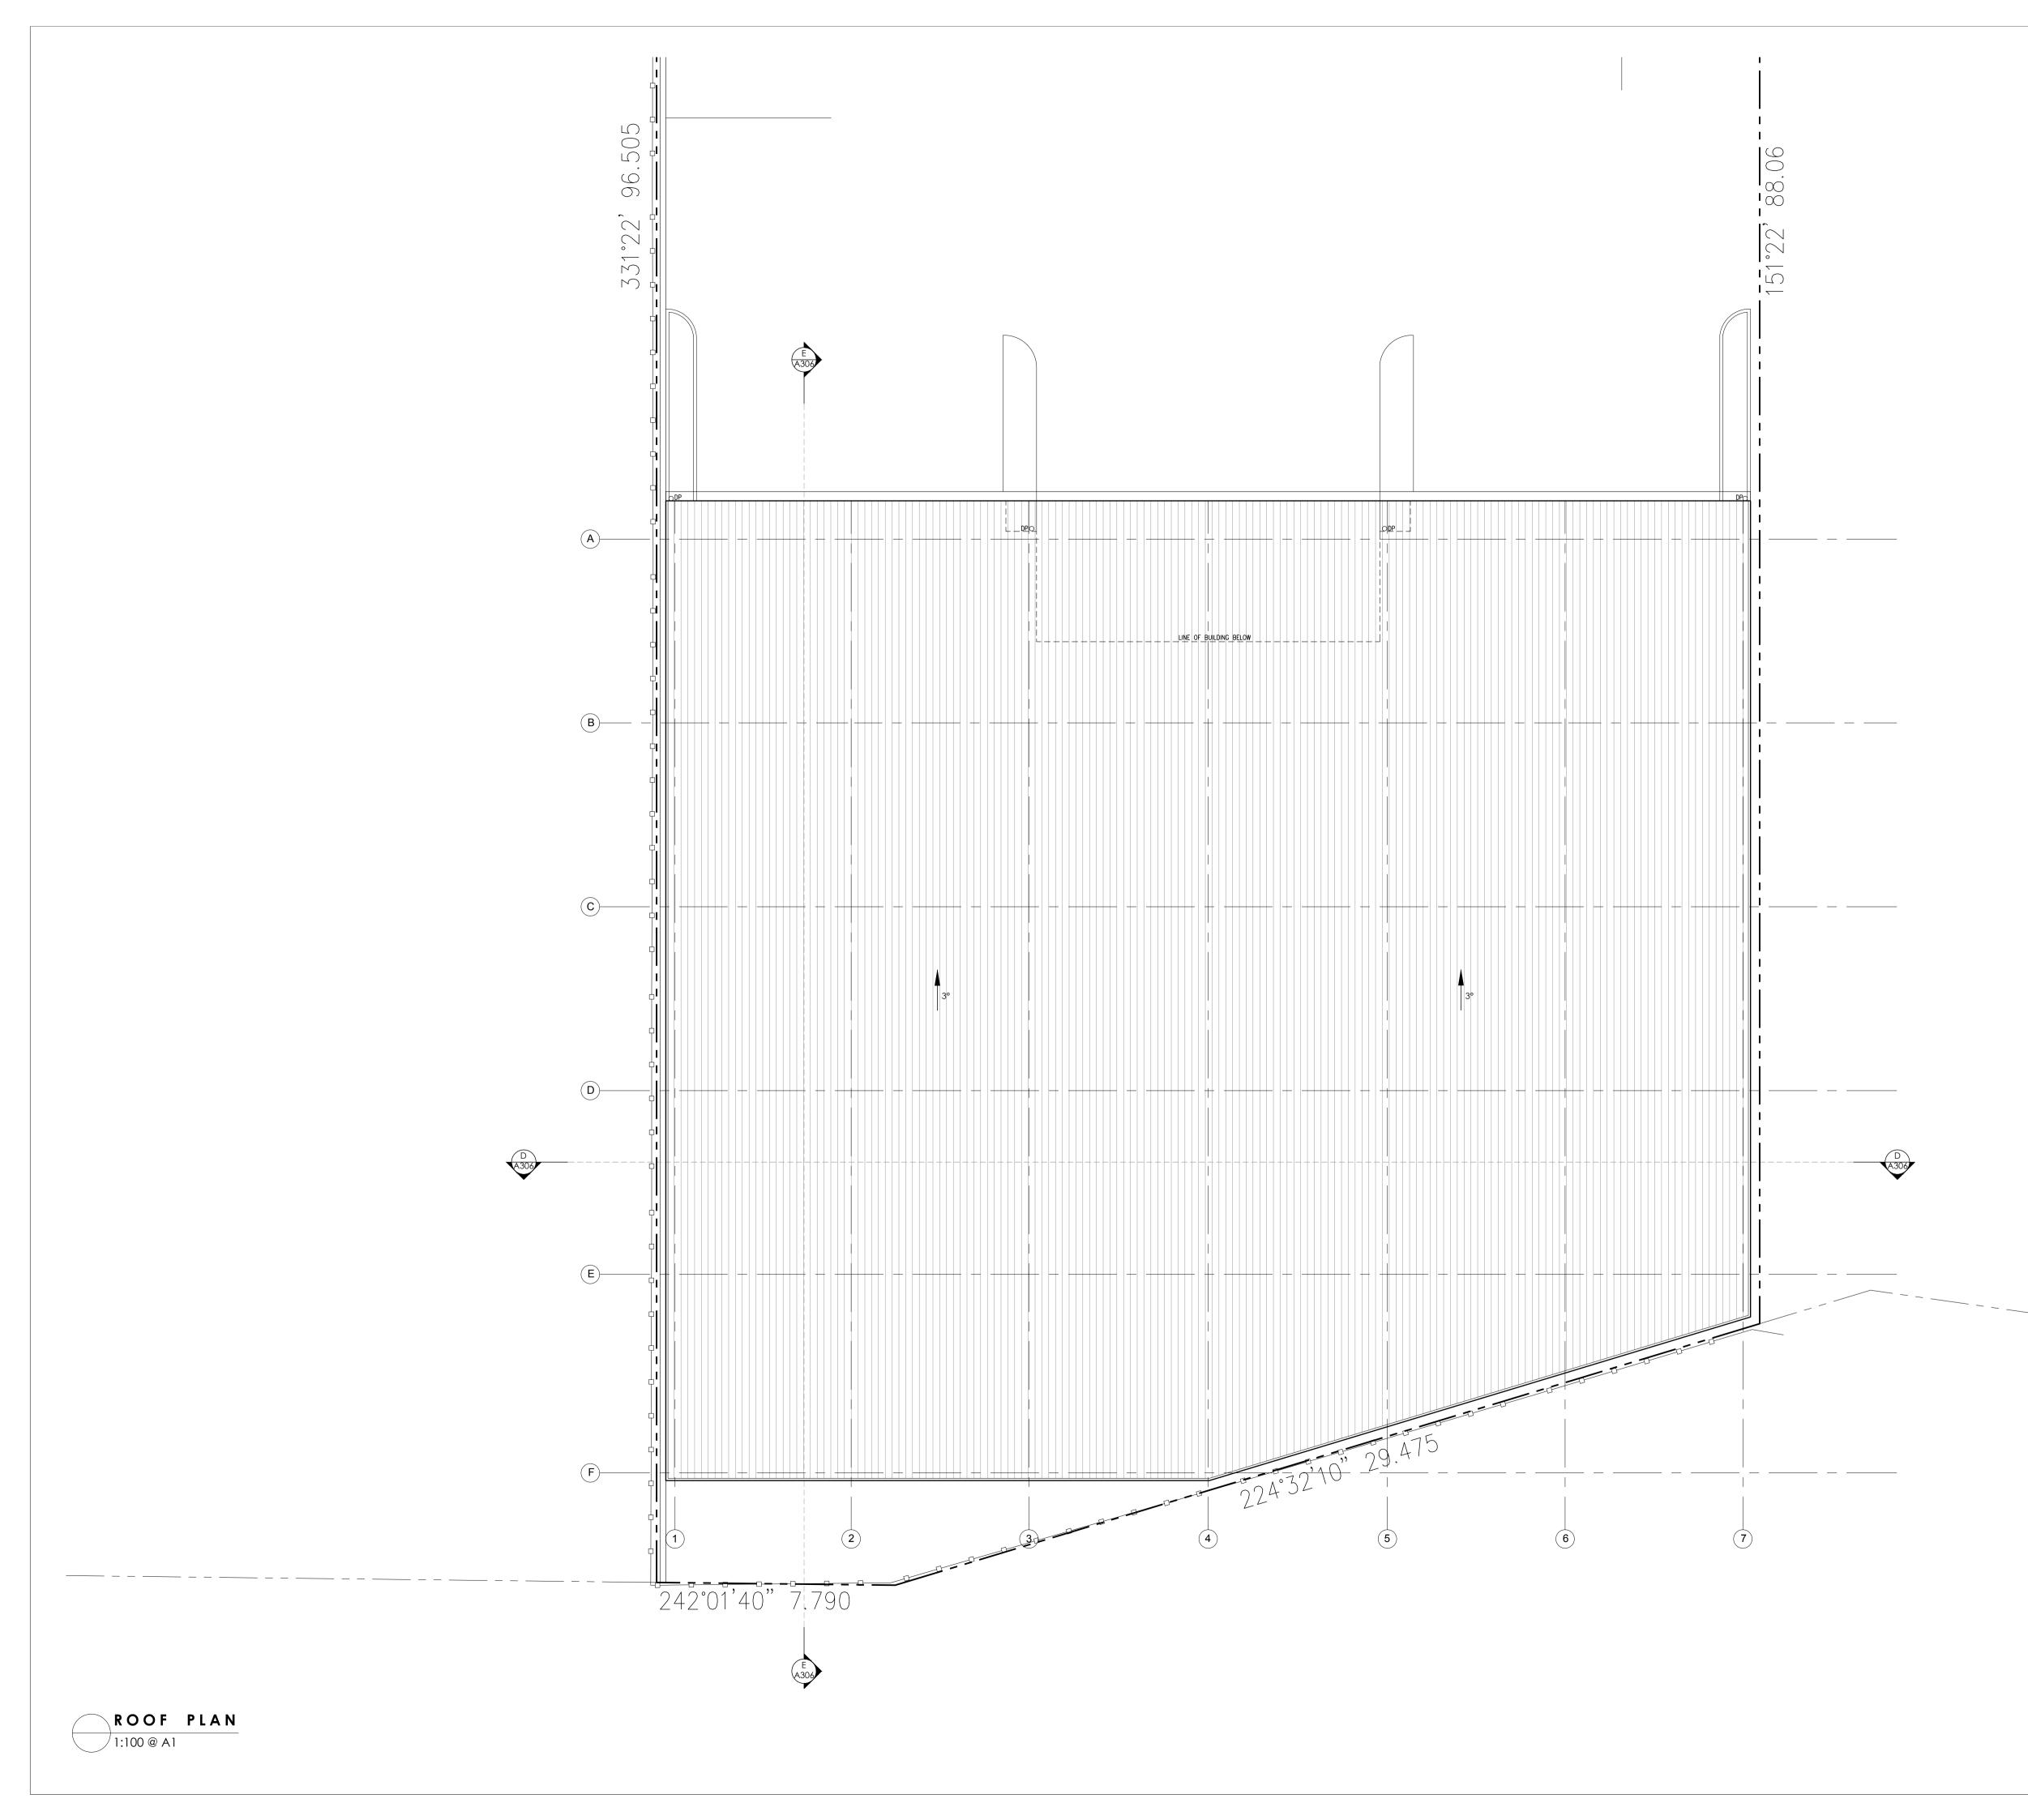B2 NORTH WEST ELEVATION 1:100 @ A1



B2 SOUTH WEST ELEVATION


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RETAINING WALL	


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LEGEND:

CONCRETE PANEL - PAINTED FINISH CONCRETE PANEL - RAW FINISH FIBRE CEMENT SHEET - PAINTED FINISH FIBRE CEMENT SHEET - RAW FINISH COLORBOND CLADDING ALUMINIUM COMPOSITE PANEL PCP RCP PFC RFC CC ACP



B2 NORTH EAST ELEVATION 1:100 @ A1

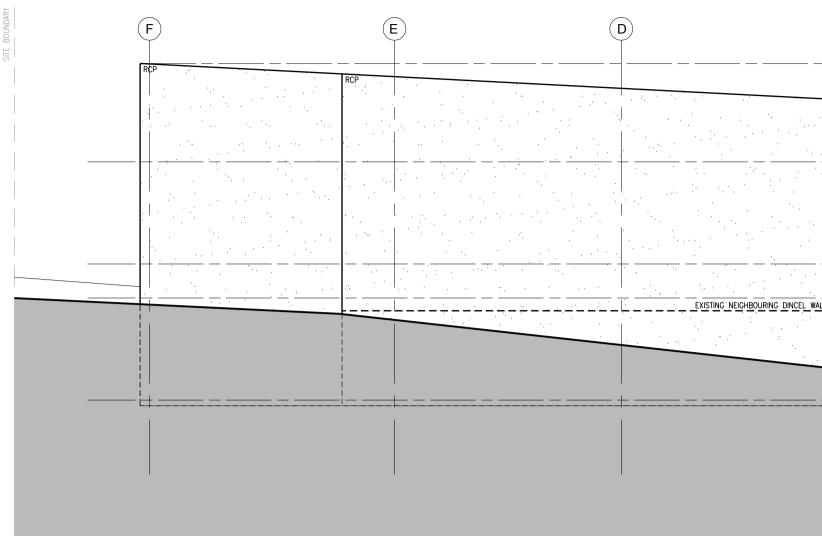

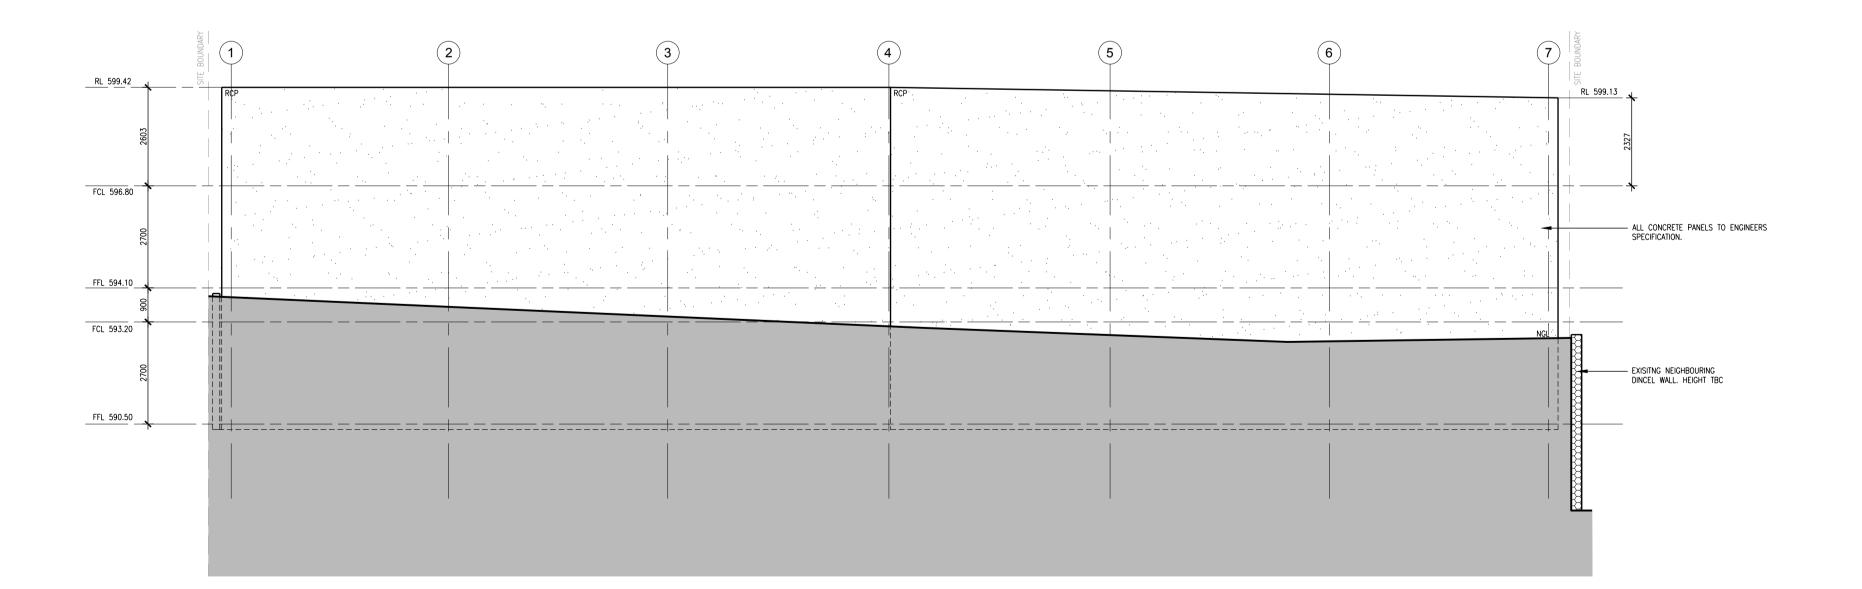B2 SOUTH EAST ELEVATION

1:100 @ A1


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SUITE 10, 14 LONSDALE ST B R A D D O N A . C . T ABN: 17 600 270 522 T : 02 6230 4688 F : 02 6230 4699 w w w . d n a a . c o m . a u dna architects Registration 966 Principal Nominee Glen Dowse AMENDMENTS: **REV DESCRIPTION** DATE A BUILDING 1 REVISED, 10.11.2016 SECOND DRIVEWAY REMOVED, BIN ENCLOSURE & PARKING ADJUSTED. INTERNAL FITOUT REMOVED FROM BUILDING 2 UNIT 2. **DA SUBMISSION** NOT FOR CONSTRUCTION BLOCK 7 Section 6 ADDRESS 14 SPONGOLITE STREET SUBURB BEARD STATE ACT SCALE 1:100 @ A1 DRAWING BUILDING 2 ELEVATIONS PROJECT CUDA - BEARD CLIENT MARIO CUDA J:\2016\1605 - Cuda - Beard - ACT\CAD\8 - 1605 - CUDA - BEARD - 2016.03.17 -DA RFI.dwg DRAWN GD/JW REVISION REVISION DATE PROJECT NO 1605 PRINT DATE **22.11.2016** DWG No **A305**


LEGEND: PCP RCP PFC RFC CC

ACP

CONCRETE PANEL - PAINTED FINISH CONCRETE PANEL - RAW FINISH FIBRE CEMENT SHEET - PAINTED FINISH FIBRE CEMENT SHEET - RAW FINISH COLORBOND CLADDING ALUMINIUM COMPOSITE PANEL



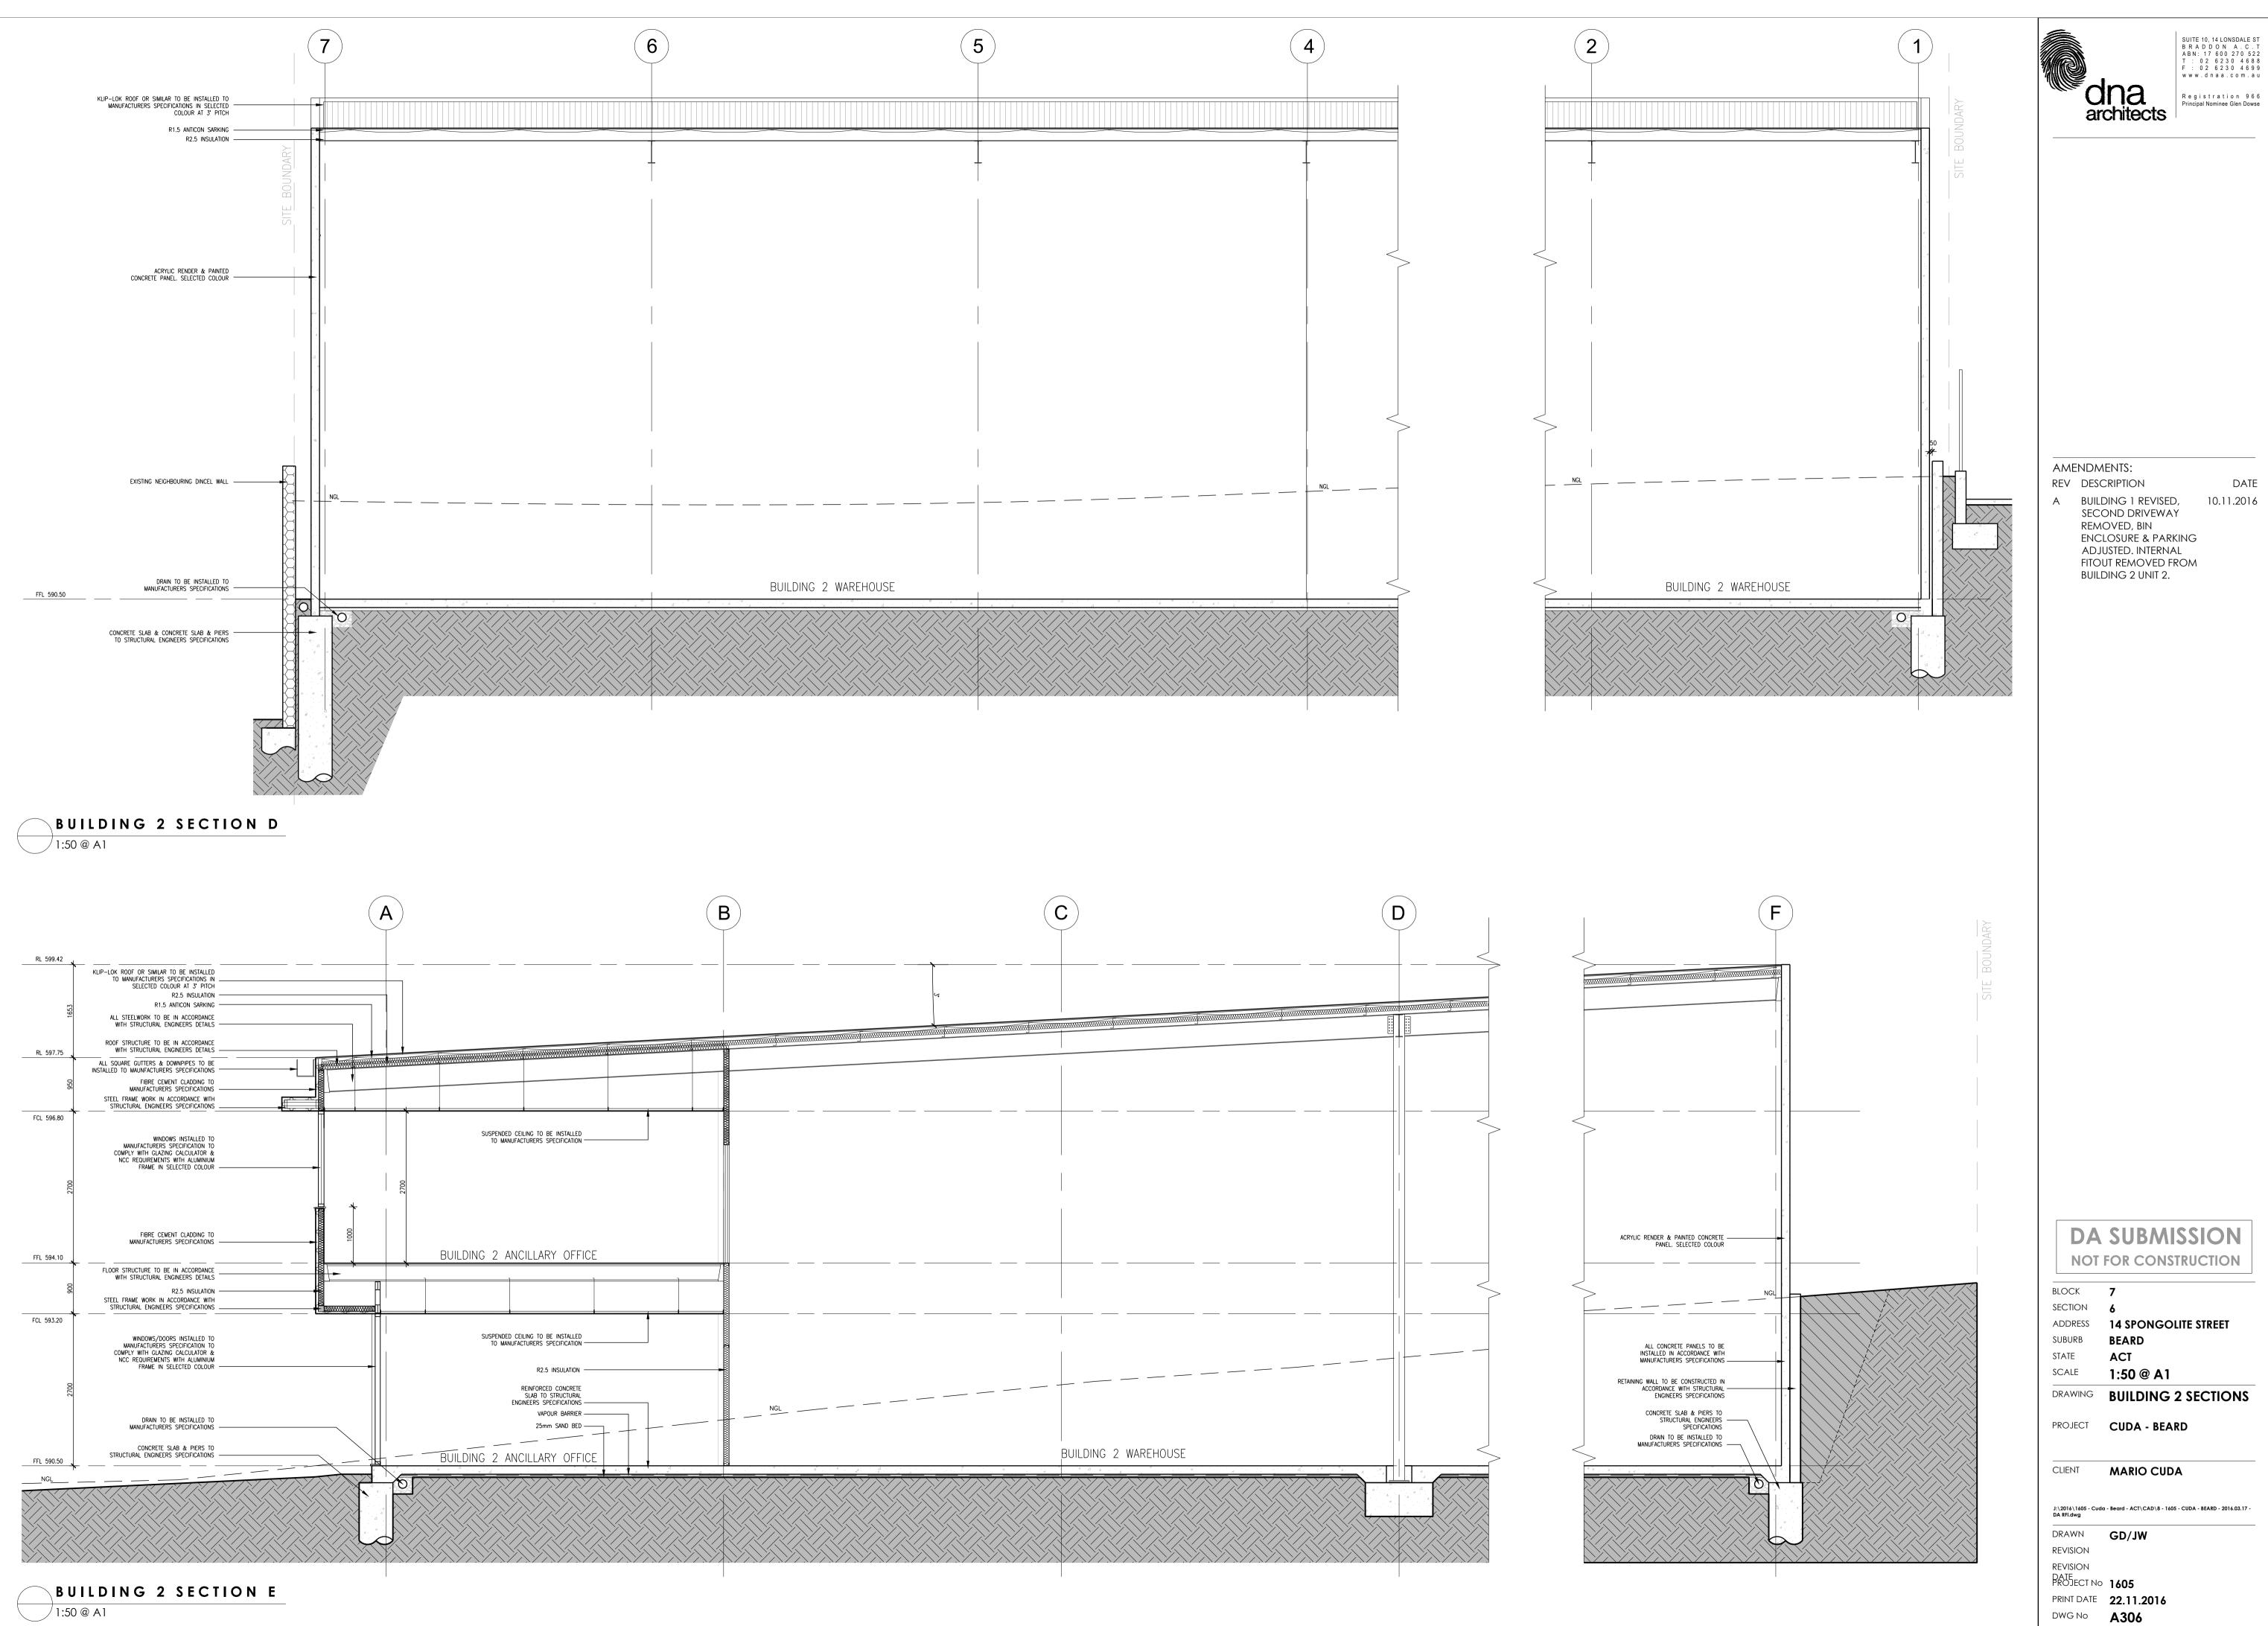

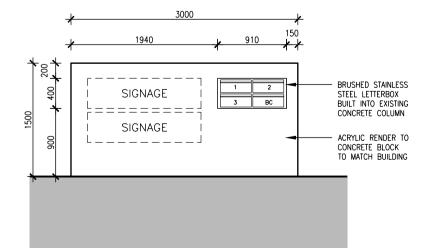





BIN ENCLOSURE PLAN


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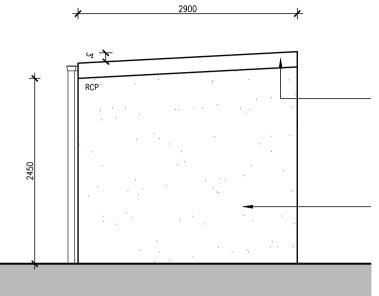




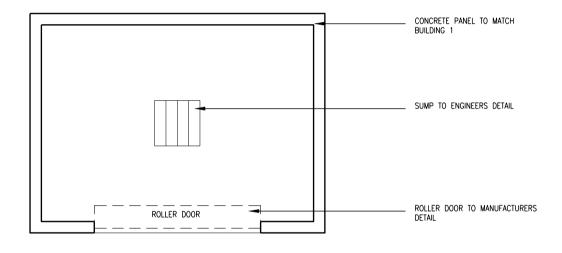

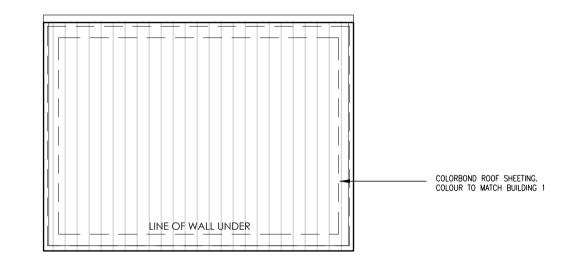





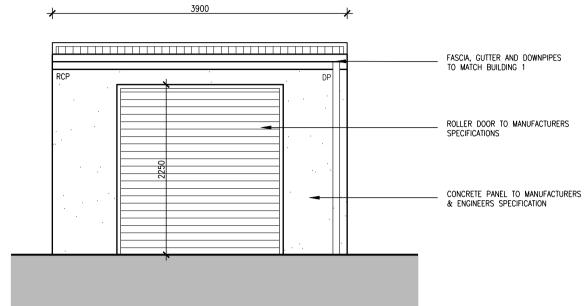





CONCRETE PANEL TO MANUFACTURERS & ENGINEERS SPECIFICATION

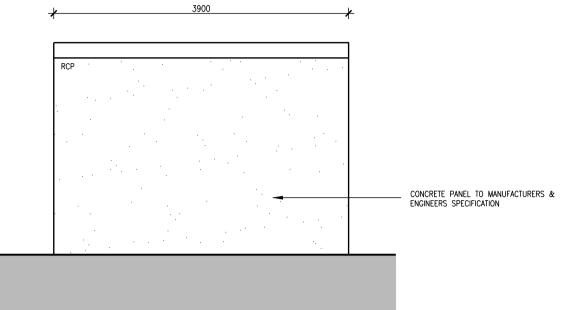

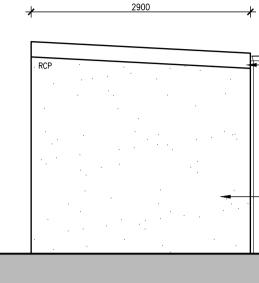

BIN ENCLOSURE ROOF PLAN

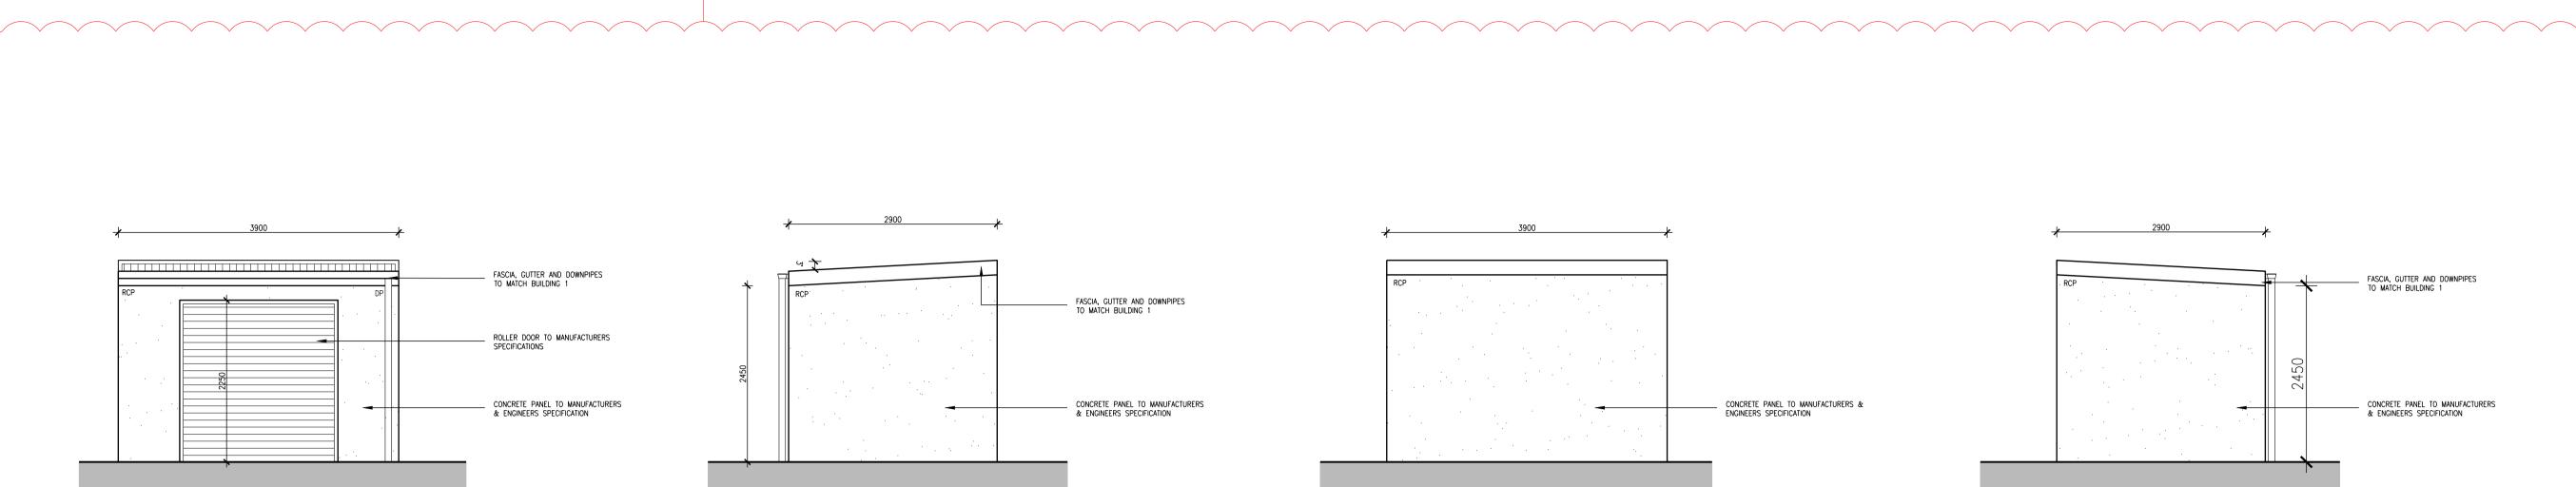

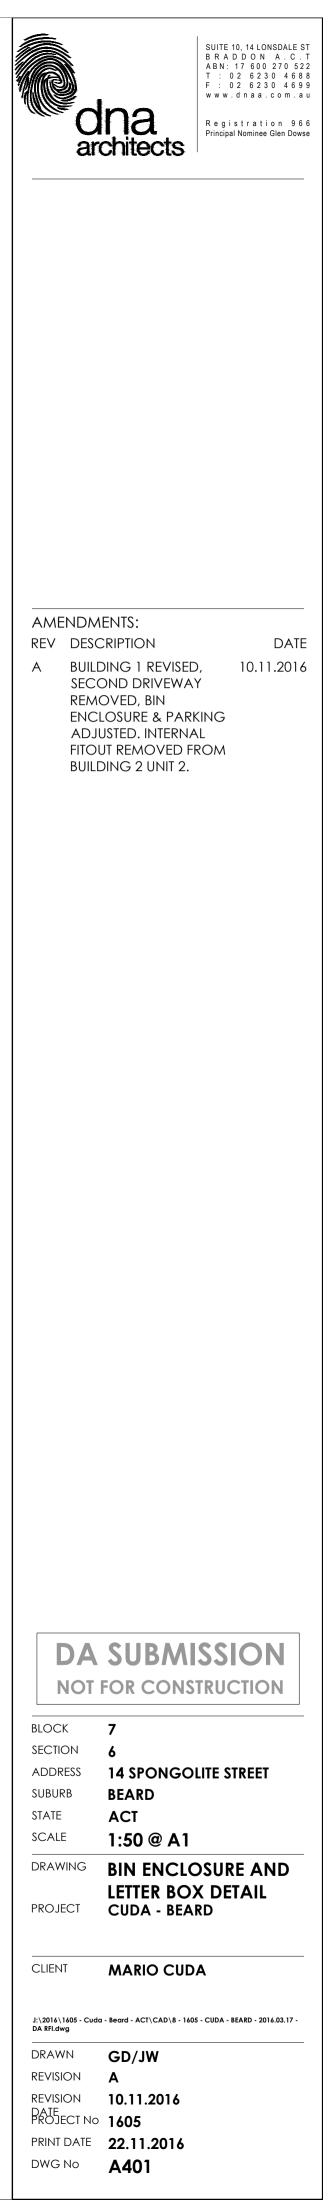

1 ON-SITE MANAGEMENT OF VERGES AND OPEN SPACE

1.1 GENERAL

BEFORE COMMENCING WORKS, THE APPLICANT OR THEIR REPRESENTATIVE MUST ADVISE ASSET ACCEPTANCE IN WRITING THAT THE PROTECTIVE MEASURES HAVE BEEN INSTALLED IN ACCORDANCE WITH THE APPROVED LMP. RANDOM AUDITS WILL BE ARRANGED BY AA TO ENSURE COMPLIANCE. ALL DEVELOPMENT WORK MUST BE CONTAINED WITHIN THE SITE EXCEPT FOR APPROVED SERVICE

CONNECTIONS IN THE VERGE. NOTE THAT THE WORKS MAY REQUIRE THE PROVISION OF AN APPROVED TEMPORARY TRAFFIC MANAGEMENT PLAN, WHICH WILL INFLUENCE THE LANDSCAPE MANAGEMENT AND PROTECTION PLAN (LMP) REQUIREMENTS. DURING THE PROJECT, ALL EXISTING VERGE GRASS COVER MUST BE RETAINED IN ITS PRE-EXISTING;

CONDITION. WATERING MAY BE REQUIRED TO RETAIN GRASS AND TREES IN GOOD CONDITION. **1.2 SUPERVISION**

FOR ALL PROJECTS, OTHER THAN MINOR WORKS (I.E. MINOR IN COMPLEXITY AND / OR SCOPE OF WORKS) A SUITABLY QUALIFIED LANDSCAPE ARCHITECT OR HORTICULTURIST MUST BE EMPLOYED TO OVERSEE WORK IN THE VERGE TO ENSURE ALL REQUIREMENTS ARE FOLLOWED. THEY MUST BE PRESENT DURING ANY CULTIVATION / RESTORATION OF THE VERGE WHICH AFFECTS PLANT MATERIAL.

1.3 STORAGE OF CONSTRUCTION MATERIALS

NO CONSTRUCTION MATERIAL IS TO BE STORED ON VERGES OR PUBLIC OPEN SPACES. NO CAR PARKING OR EQUIPMENT PARKING PERMITTED ON VERGES OR ADJACENT PARKLAND.

1.4 SITE ACCOMMODATION GENERALLY, SITE SHEDS, STORAGE SHEDS, SITE AMENITIES OR BILLBOARDS ARE NOT TO BE ERECTED ON VERGES OR PUBLIC OPEN SPACES, HOWEVER, AN APPLICATION MAY BE LODGED TOGETHER WITH THE LMP, WITH THE MANAGER, ASSET ACCEPTANCE (AA) FOR THE USE OF VERGES, PUBLIC OPEN SPACES OR UN-LEASED TERRITORY LAND. APPROVAL MAY BE GRANTED SUBJECT TO THE DEVELOPER'S AGREEMENT TO COMPLY WITH THE TERMS AND CONDITIONS, AS SPECIFIED BY ASSET ACCEPTANCE ON APPLICATION, FOR IT CAN AFFECT TREE STABILITY AND TREE HEALTH TO SUCH AN EXTENT THAT IT WILL LEAD TO THE A SPECIFIC SITE.

1.5 PROTECTIVE FENCING

1.5.1 EXTENT

ALL TEMPORARY PROTECTIVE FENCES ERECTED TO PROTECT EXISTING PUBLICLY OWNED LANDSCAPE

ASSETS ARE TO BE IN ACCORDANCE WITH THE APPROVED I MP DRAWING FENCE OFF EXISTING TREES, PLANTINGS AND GRASS TO ENCLOSE THE STREET VERGE, PUBLIC OPEN SPACE

OR UN-LEASED TERRITORY LAND AREA. THE LOCATION OF PROTECTIVE FENCING WILL BE: · FENCE EACH TREE ALONG ITS DRIP-LINE (AT A MINIMUM),

1.2M FROM THE BACK OF THE KERB FOR THE FULL FRONTAGE OF THE LEASE, ALONG THE PROPERTY BOUNDARY AND ALONG APPROVED DRIVEWAY ACCESS TO ENSURE THAT THE VERGE IS COMPLETELY enclosed

FENCING MUST BE ERECTED BEFORE THE COMMENCEMENT OF ANY SITE WORKS AND REMOVED AT COMPLETION OF ALL CONSTRUCTION AND COMMENCEMENT OF VERGE RESTORATION. THE FENCE IS TO REMAIN CONTINUOUS THROUGHOUT THE PROJECT.

1.5.2 MATERIALS

USE OF TEMPORARY 1800-MM TALL CONTINUOUS MESH FENCE SUPPORTED BY STEEL POSTS WITH CONCRETE BASES IS MANDATORY. VARIATION FROM THIS REQUIREMENT MUST BE ACCOMPANIED BY WRITTEN AGREEMENT FROM ASSET ACCEPTANCE.

1.5.3 PEDESTRIAN AND TRAFFIC CONSIDERATIONS

EXISTING VERGE FOOTPATHS TO BE MAINTAINED AND MUST REMAIN UNOBSTRUCTED THROUGHOUT THE CONSTRUCTION PERIOD, TO PROVIDE SAFE PEDESTRIAN MOVEMENT AT ALL TIMES.

WHERE A CONSTRUCTED FOOTPATH OR CYCLEWAY EXISTS WITHIN THE VERGE, PROTECTIVE FENCING MUST IN ALL CASES BE SET BACK 0.6M FROM EACH SIDE OF THE FOOTPATH / CYCLEWAY TO ENSURE SAFE PASSAGE FOR CYCLISTS AND PEDESTRIANS.

IF THERE IS NO CONSTRUCTED PUBLIC FOOTPATH ON THE VERGE A FENCED CLEARWAY OF 1.8M IN WIDTH MUST BE MAINTAINED FOR THE ENTIRE FRONTAGE OF THE LEASE TO ALLOW FOR PEDESTRIANS AND CYCLISTS.

ACCESS GATES INTO THE SITE MUST SWING INTO THE SITE. THEY MUST NOT BE CAPABLE OF BLOCKING

PEDESTRIAN ACCESS ALONG THE VERGE OR VEHICULAR TRAFFIC ON THE ROAD.

1.5.4 ACCESS FOR SERVICE INSTALLATIONS

FENCING MUST NOT BE REMOVED FOR SERVICE INSTALLATION ACROSS THE VERGE UNLESS AA APPROVES THE SERVICE INSTALLATION. REALIGN FENCE TO PROVIDE LANE FOR SERVICE TRENCHING, BUT RE-ERECT FENCE TO ENCLOSE TREES

BEFORE TRENCHING COMMENCES. UPON COMPLETION OF TRENCHING, RETURN THE FENCE TO ITS' ORIGINAL

ALIGNMENT. 1.6 EXISTING TREES

1.6.1 GENERAL

ALL TREES LOCATED IN THE ROAD RESERVE, VERGE, PUBLIC OPEN SPACE AND ON UN-LEASED TERRITORY LAND, ARE TO BE RETAINED AND REMAIN UNDAMAGED. WRITTEN AUTHORISATION FROM AA IS REQUIRED IF ANY PLANT MATERIAL IS TO BE DISTURBED AS A PART OF CONSTRUCTION. THIS APPROVAL WILL BE GIVEN AS A PART OF THE LMP

EXISTING CANOPY CLEARANCE IS NOT TO BE ALTERED.

CROWNS AND APEX OF CANOPIES ARE NOT TO BE ALTERED OR REDUCED. ENSURE LIFTING EQUIPMENT AND LOAD CAN CLEAR HEIGHT AND WIDTH OF TREE CANOPY WITHOUT DAMAGE TO CROWN.

ENSURE CONSTRUCTION EQUIPMENT CAN PASS BENEATH LOWEST LIMB, THROUGH DRIVEWAY ACCESS.

1.6.2 TREE ROOT PROTECTION

THE MAJORITY OF TREE ROOTS GROW IN THE TOP 300MM OF SOIL. THESE ARE THE FEEDER ROOTS, OFTEN VERY FINE ROOTS THAT PROVIDE THE TREE WITH WATER, OXYGEN AND NUTRIENTS. THESE ROOTS TYPICALLY GROW BETWEEN THE TREE'S TRUNK TO WELL BEYOND ITS 'DRIP-LINE' (THE CANOPY EDGE). EXCAVATION WITHIN THE DRIP ZONE OF A TREE DOES CONSIDERABLE DAMAGE TO ITS ROOT SYSTEM. DECLINE AND POSSIBLE DEATH OF THE TREE OVER A PERIOD OF YEARS.

EXCAVATION THAT OCCURS WITHIN THE DRIP ZONE OF A TREE MUST BE APPROVED AND IS TO BE RESTRICTED TO ONE SIDE OF THE TREE ONLY. APPROVAL CAN BE SOUGHT BY CONTACTING THE ASSET ACCEPTANCE OFFICER.

WHERE EXCAVATION IS APPROVED, THE FOLLOWING MEASURES ARE TO BE ADOPTED FOR TREE PROTECTION:

· DO NOT SEVER LARGE ROOTS (>30 MM DIAMETER) CLOSER THAN HALFWAY FROM THE DRIP-LINE TO THE TRUNK. HAND TRENCHING TO A DEPTH OF 300MM IS REQUIRED TO LOCATE THESE ROOTS BEFORE ANY MECHANICAL TRENCHING IS UNDERTAKEN.

 \cdot ALL ROOTS MUST BE CUT CLEANLY WITH EQUIPMENT SPECIFICALLY DESIGNED TO CUT ROOTS CLEANLY OR OTHER SUITABLE PRUNING EQUIPMENT.

·ROOTS EXPOSED DURING EXCAVATION MUST BE PROTECTED FROM DESICCATION. KEEP LIGHTLY WATERED OR COVER WITH HESSIAN, WHICH MUST BE KEPT MOIST.

WATER TREES THAT HAVE HAD DISTURBANCE IN THEIR ROOT ZONE. THE AMOUNT AND FREQUENCY OF WATER NEEDS TO BE ADAPTED TO THE TREES' REQUIREMENT, BASED ON SEASONAL CONDITIONS. 1.7 SITE ACCESS

SITE ACCESS MUST INITIALLY BE BY THE EXISTING DRIVEWAY ACCESS POINTS FOR THE NEW DEVELOPMENT

IN SOME CASES, CONSIDERATION MAY BE GIVEN TO ALLOWING NEW ACCESS POINTS ACROSS PUBLIC LAND. APPROVAL FOR ALTERNATIVE OR ADDITIONAL ACCESS POINTS MUST BE OBTAINED THROUGH ASSET ACCEPTANCE. IN SUCH CASES, THE SITE ACCESS MUST BE POSITIONED MIDWAY BETWEEN EXISTING TREE TRUNKS. THIS, HOWEVER, IS DEPENDENT ON THE DISTANCE BETWEEN TREES. IN SOME CASES TREES MAY BE TOO CLOSE TO ALLOW ACCESS. ACCESS IS NOT TO OCCUR ON TWO SIDES OF A TREE.

CONSTRUCTION TECHNIQUE SHOULD MINIMISE THE NEED FOR EXCAVATION ACROSS THE VERGE. ACCESS ACROSS ADJOINING PUBLIC OPEN SPACES, PARKS, RECREATIONAL RESERVES, ADJOINING PROPERTIES, E.G. SCHOOL PLAYGROUNDS, COMMUNITY HALLS ETC, IS PROHIBITED WITHOUT WRITTEN AUTHORISATION FROM ASSET ACCEPTANCE.

1.8 SERVICES AND UTILITIES

1.8.1 SERVICE CONNECTION TO SITE FOLLOWING REQUIREMENTS APPLY: THE CANOPY SPREAD OF ANY TREE. · SHARED TRENCHING FOR SERVICES IS MANDATORY. · NUMBER OF VERGE CROSSINGS TO BE MINIMISED. MIDWAY BETWEEN THE TREE TRUNKS. REQUIRES PRIOR APPROVAL. TERRITORY LAND.


1.8.2 SERVICES AND UTILITIES ALONG ROAD RESERVES THE DEVELOPER MUST COORDINATE ALL SERVICE APPROVALS. ROOTS/ROOT ZONE.

· WITHIN ROAD PAVED AREA. WITHIN THE CANOPY SPREAD OF ANY TREE. · BELOW EXISTING FOOTPATH ON THE PROPERTY LINE. · IMMEDIATELY BEHIND KERB. 1.9 IRRIGATION

AND AT THE COMPLETION OF WORK.

APPLY:

1M AWAY FROM TREE TRUNKS. (EQUIVALENT TO MULTIGRO) AT 40G/M2. DURING ESTABLISHMENT.

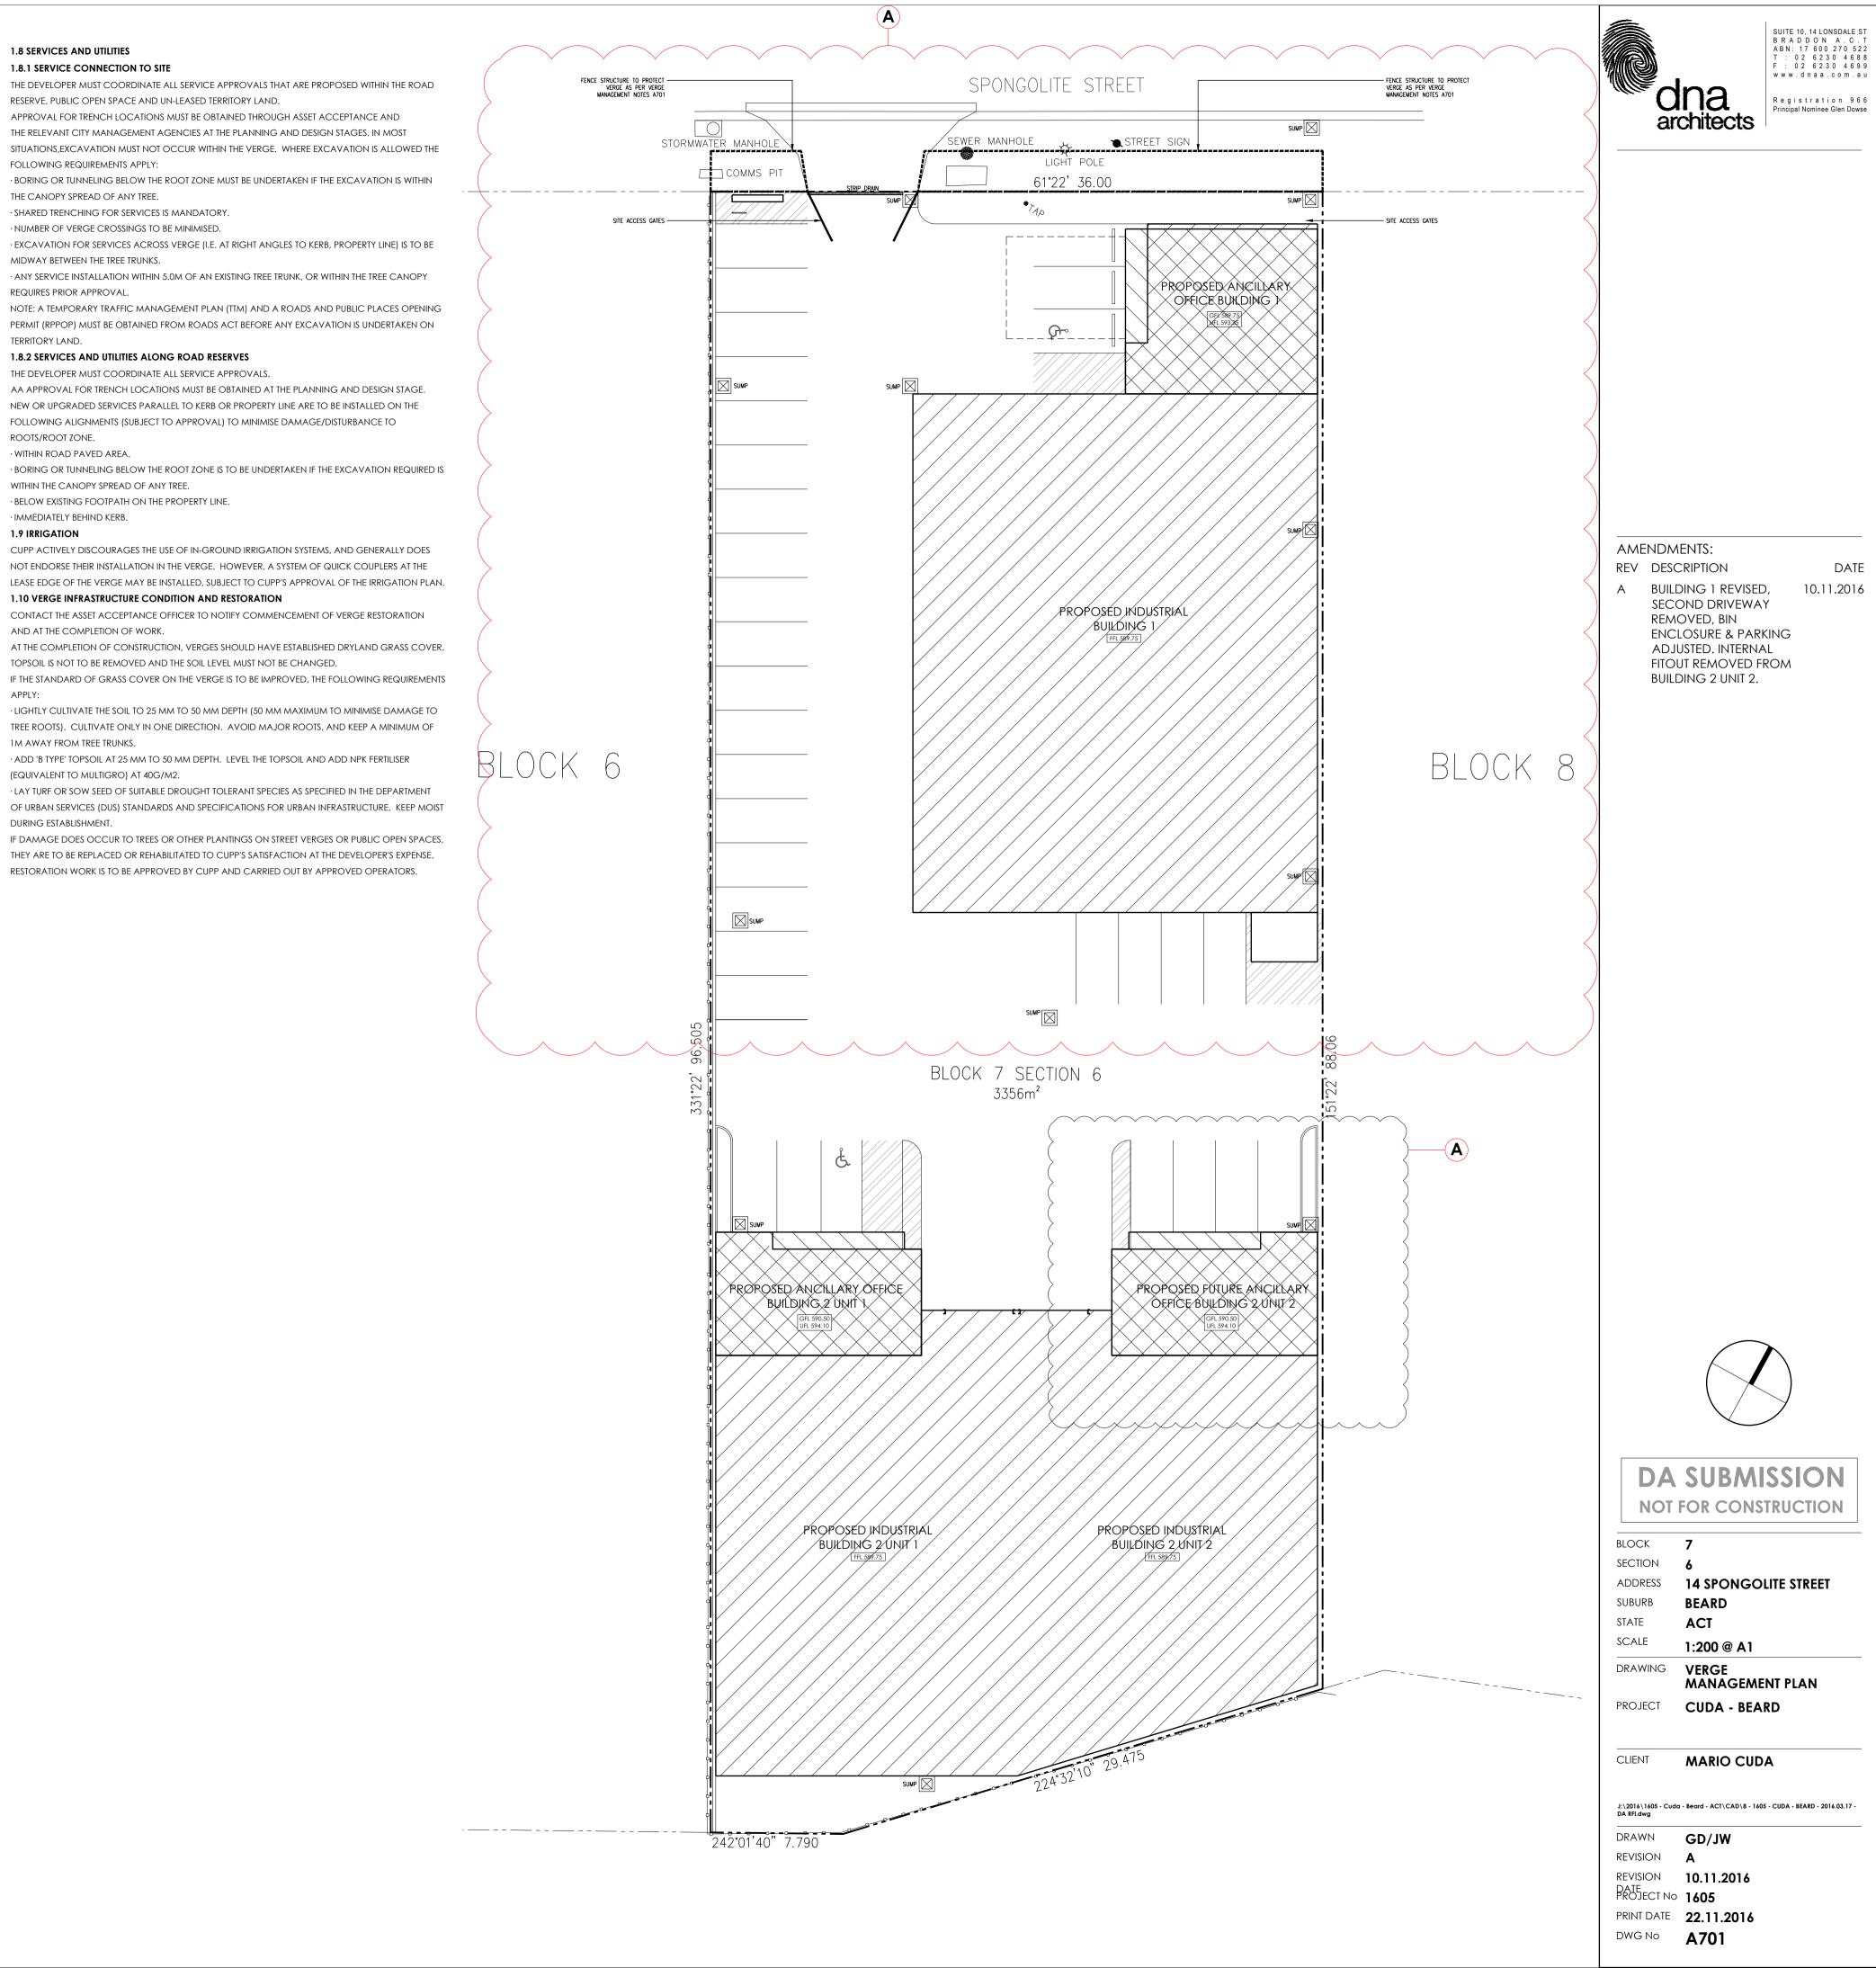

MAINTENANCE SCHEDULE MONTHLY

TURN OVER STABILISED CONSTRUCTION ENTRY MATERIAL AND TOP UP AS REQUIRED.

WEEKLY

CHECK AND REINSTATE SILT CONTROL FENCES. 2.

DAILY

SWEEP AND REMOVE ANY DIRT TRACKED ONTO PUBLIC 3 ROADS BY VEHICLES. ALL NECESSARY STEPS SHOULD BE TAKEN THAT ARE PRACTICAL AND REASONABLE TO MINIMISE DUST POLLUTION ON LAND DEVELOPMENT AND CONSTRUCTION SITE.

DURING/AFTER WET WEATHER

LIMIT CONSTRUCTION VEHICLE ACCESS TO SITE DURING 4 AND IMMEDIATELY FOLLOWING WET WEATHER.

DUST MANAGEMENT

- 1. A WATER CART OR SUFFICIENT WATER SPRAYS SHALL BE MADE AVAILABLE IN DRY AND WINDY CONDITIONS TO MAINTAIN DUST SUPPRESSION.
- 2. WATER SHALL BE APPLIED TO SUPPRESS DUST FROM OPEN EARTHWORKS AS WELL AS UNPROTECTED STOCKPILES.
- 3. STOCKPILES SHALL BE EITHER COVERED OR SEEDED TO PREVENT DUST.
- 4. AREAS OF COMPLETED EARTHWORKS SHALL BE PROGRESSIVELY REHABILITATED WITH DRYLAND GRASS AND FENCED OFF AS SOON AS PRACTICABLE TO PREVENT FURTHER EROSION.
- 5. THE CONTRACTOR SHALL CONTACT ACTEWAGL TO OBTAIN AN EXEMPTION TO USE WATER ON THE SITE.

ACCESS

ACCESS POINT SHOULD BE STABILISED TO THE FOLLOWING CRITERIA:

STABILISED PAD OF AGGREGATE UNDERLAIN WITH FILTER CLOTH. -AGGREGATE SIZE 50mm AGGREGATE, OR RECLAIMED OR RECYCLED CONCRETE EQUIVALENT.

-THICKNESS: NOT LESS THAN 150mm.

-WIDTH: 3M MINIMUM BUT NOT LESS THAN THE FULL WIDTH OF VEHICLE ACCESS.

-LENGHT: AS REQUIRED, BUT NOT LESS THAN 15M -FILTER CLOTH: TO BE PLACED OVER THE ENTIRE AREA TO BE

COVERED WITH AGGREGATE.

THE LOCATION OF ANY WASH DOWN AND BRICK/PAVING CUTTING AREAS ARE LOCATED UPSTREAM OF THE SEDIMENT FENCE WITH TRENCHING OR SMALL PONDS TO COLLECT WASTE WATER.

THE KERB IS TO BE SWEPT DAILY, AND THE SEDIMENT IS TO BE COLLECTED AND RETURNED TO SITE.

THE DUST FROM THE SITE IS TO BE MANAGED TO PREVENT SIGNIFICANT ADVERSE IMPACT ON NEIGHBOURING SITES. REGULAR MONITORING AND MAINTENANCE OF THE ABOVE POLLUTION CONTROLS ARE TO BE UNDERTAKEN.

GENERAL NOTES

THIS DRAWING SHALL BE READ IN CONJUNCTION WITH THE ENGINEERS DETAILS.

CONFIRM STEEL SIZES PRIOR TO CONSTRUCTION ALL MATERIALS AND FINISHES SHALL BE APPROVED BY THE OWNERS

VARIATIONS TO PLAN AND SPECIFICATION SHALL NOT BE MADE WITHOUT THE CONSENT OF THE OWNERS ALL DIMENSIONS SHALL BE VERIFIED ON SITE

ALL WORK SHALL BE CARRIED OUT IN ACCORDANCE WITH THE BCA do not scale off drawings

FIRE PRECAUTIONS DURING CONSTRUCTION SHALL BE IN ACCORDANCE WITH SECTION E CLAUSE E1.6 OF THE BCA PROVIDE PORTABLE FIRE EXTINGUISHES IN ACCORDANCE WITH SECTION E CLAUSE E1.6 OF THE BCA FIRE EXTINGUISHERS SHALL COMPLY WITH AS 2444

ALL MATERIALS AND ASSEMBLIES SHALL COMPLY WITH C1.10 OF THE BCA ALL WET AREA FLOORS SHALL BE GRADED AND DRAINED TO FLOOR WASTES TO PLUMBLING CODES AND THE BCA

PROVIDE IMPERVIOUS WALL TO FLOOR JOINT TO THE PERIMETER OF ALL WET AREAS WATERPROOFING SHALL COMPLY WITH C1. F1.7 OF THE BCA CONFIRM LOCATION OF ALL SERVICES PRIOR TO CONSTRUCTION

EGRESS

REQUIRED PATHS OF EXIT BE IN ACCORDANCE WITH PART D1.6 OF THE BCA THE UNOBSTURCTED HEIGHT MUST BE NO LESS THEN 2.0M EXCEPT AT DOORWAYS WHERE THE HEIGHT MAY BE REDUCED TO 1.98M. THE UNOBSTRUCTED WIDTH OF EACH EXIT OR PATH OF TRAVEL TO AN EXIT, EXCEPT AT DOORWAYS MUST BE 1.0M MINIMUM REQUIRED EXIT SIGNS SHALL BE IN ACCORDANCE WITH PART E4 OF THE BCA

PROVIDE EMERGENCY ILLUMINATED EXIT SIGNS TO REQUIRED EXITS TO AS 2293.1 EXITS MUST NOT BE BLOCKED AT THE POINT OF DISCHARGE, AND WHERE NECCESARY SUITABLE BARRIERS MUST BE PROVIDED TO PREVENT VEHICLES FROM BLOCKING EXITS

OPERATION OF LATCHES MUST BE IN ACCORDANCE WITH PART D2.1 OF THE BCA A REQUIRED EXIT DOOR MUST BE READILY OPENABLE WITHOUT A KEY FROM THE SIDE THAT FACES THE PERSON SEEKING EGRESS BY A SINGLE HAND DOWNWARD ACTION OR PUSHING ACTION ON A SINGLE DEVICE WHICH IS LOCATED BETWEEN 900MM AND 1200MM FROM THE FLOOR

LIGHTING

INSTALL EMERGENCY LIGHTING IN ACCORDANCE WITH AS 2293.1 AND PART E4.2 OF THE BCA INCLUDING DIRECTIONAL SIGNAGE (NOT SHOWN ON PLANS) TO BCA REQUIREMENTS PROVIDE ARTIFICIAL LIGHTING TO AS 1680

ACESSIBILITY

ACESS FOR PEOPLE WITH DISABLITIES SHALL COMPLY WITH PART D3 OF THE BCA AND AS 1428.1 DISABLED PERSON TOILETS SHALL COMPLY WITH AS 1428.1 DISABLED PERSON WC SHALL HAVE ADEQUATE FACILITIES FOR THE DISPOSAL OF SANITARY TOWELS AND A SHELF MUST ALSO BE PROVIDED DISABLED PERSON CAR APRKING SHALL BE IN ACCORDANCE WITH D3.5

TACTILE INDICATORS

PROVIDE TACTILE INDICATORS IN ACCORDANCE WITH D3.8 OF THE BCA AND AS 1428.1 AT THE ENTRANCE TO THE CARPARK AREA AND AT THE APPROACH TO THE STAIRWAY THE BUILDING ACCESS SHALL HAVE A SLIP RESISTANT SURFACE

PROVIDE BRAILLE AND TACTILE SIGNS TO IDENTIFY SANITARY FACILITIES

Sarking

INSTALL ROOF SARKING TO AS/NZS 4200 PARTS 1 AND 2

IMPORTANT NOTE

THIS PLAN IS PREPARED FOR THE CLIENT FROM A COMBINATION OF FIELD SURVEYS AND EXISTING RECORDS PROVIDED BY THE CLIENT SERVICES AND INFORMATION SHOWN HEREON HAVE BEEN LOCATED WHERE POSSIBLE BY FIELD SURVEY. IF NOT ABLE TO BE LOCATED, SERVICES HAVE BEEN PLOTTED FROM RECORDS OF RELEVANT AUTHORITIES WHERE AVAILABLE AND HAVE BEEN NOTED ACCORDINGLY ON THIS PLAN

PRIOR TO ANY DEMOLITION, EXCAVATION OR CONSTRUCTION ON THE SITE, RELEVANT AUTHORITY SHOULD BE CONTACTED FOR THE POSSIBLE LOCATION OF FURTHER UNDERGROUND SERVICES AND DETAILED LOCATION OF ALL SERVICES. THIS NOTE IS AN INTEGRAL PART OF THIS PLAN

STAIRS

GOINGS AND RISERS SHALL BE INACCORDANCE WITH PART D OF THE BCA NOMINAL DIMENSIONS OF RISERS AND TREAD MUST CONSISTANT FOR EACH FLIGHT OF STAIRS AND THERE MUST BE NO MORE THEN 18 RISERS PER FLIGHT


RISER AND GOINGS SHALL BE IN ACCORDANCE WITH THE BCA


RISER 190 MAX, 115 MIN GOINGS 355 MAX 250 MIN


QUANTITY (2xRISER+GOING) 700MAX, 550 MIN STAIR SHALL BE BALUSTRADED WHERE HEIGHT TO FINISHED GROUND LEVEL EXCEEDS 1.0M

BALUSTRADE SHALL BE 1000 HIGH AND NOT LESS THEN 865MM ABOVE STAIR NOSINGS, NO OPENING IN BALUSTRADE MUST ALLOW A 125MM SPHERE TO PASS THROUGH, LOADING FORCES MUST BE IN ACCORDANCE WITH AS 1170.1 WHERE HEIGHT OF STAIR IS GREATER THAN 570 ABOVE FINISHED GROUND LEVEL A LANDING IN ACCORDANCE WITH CLAUSE 3.9.1.3 SHALL BE PROVDIED



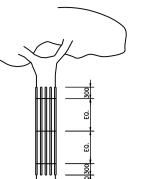

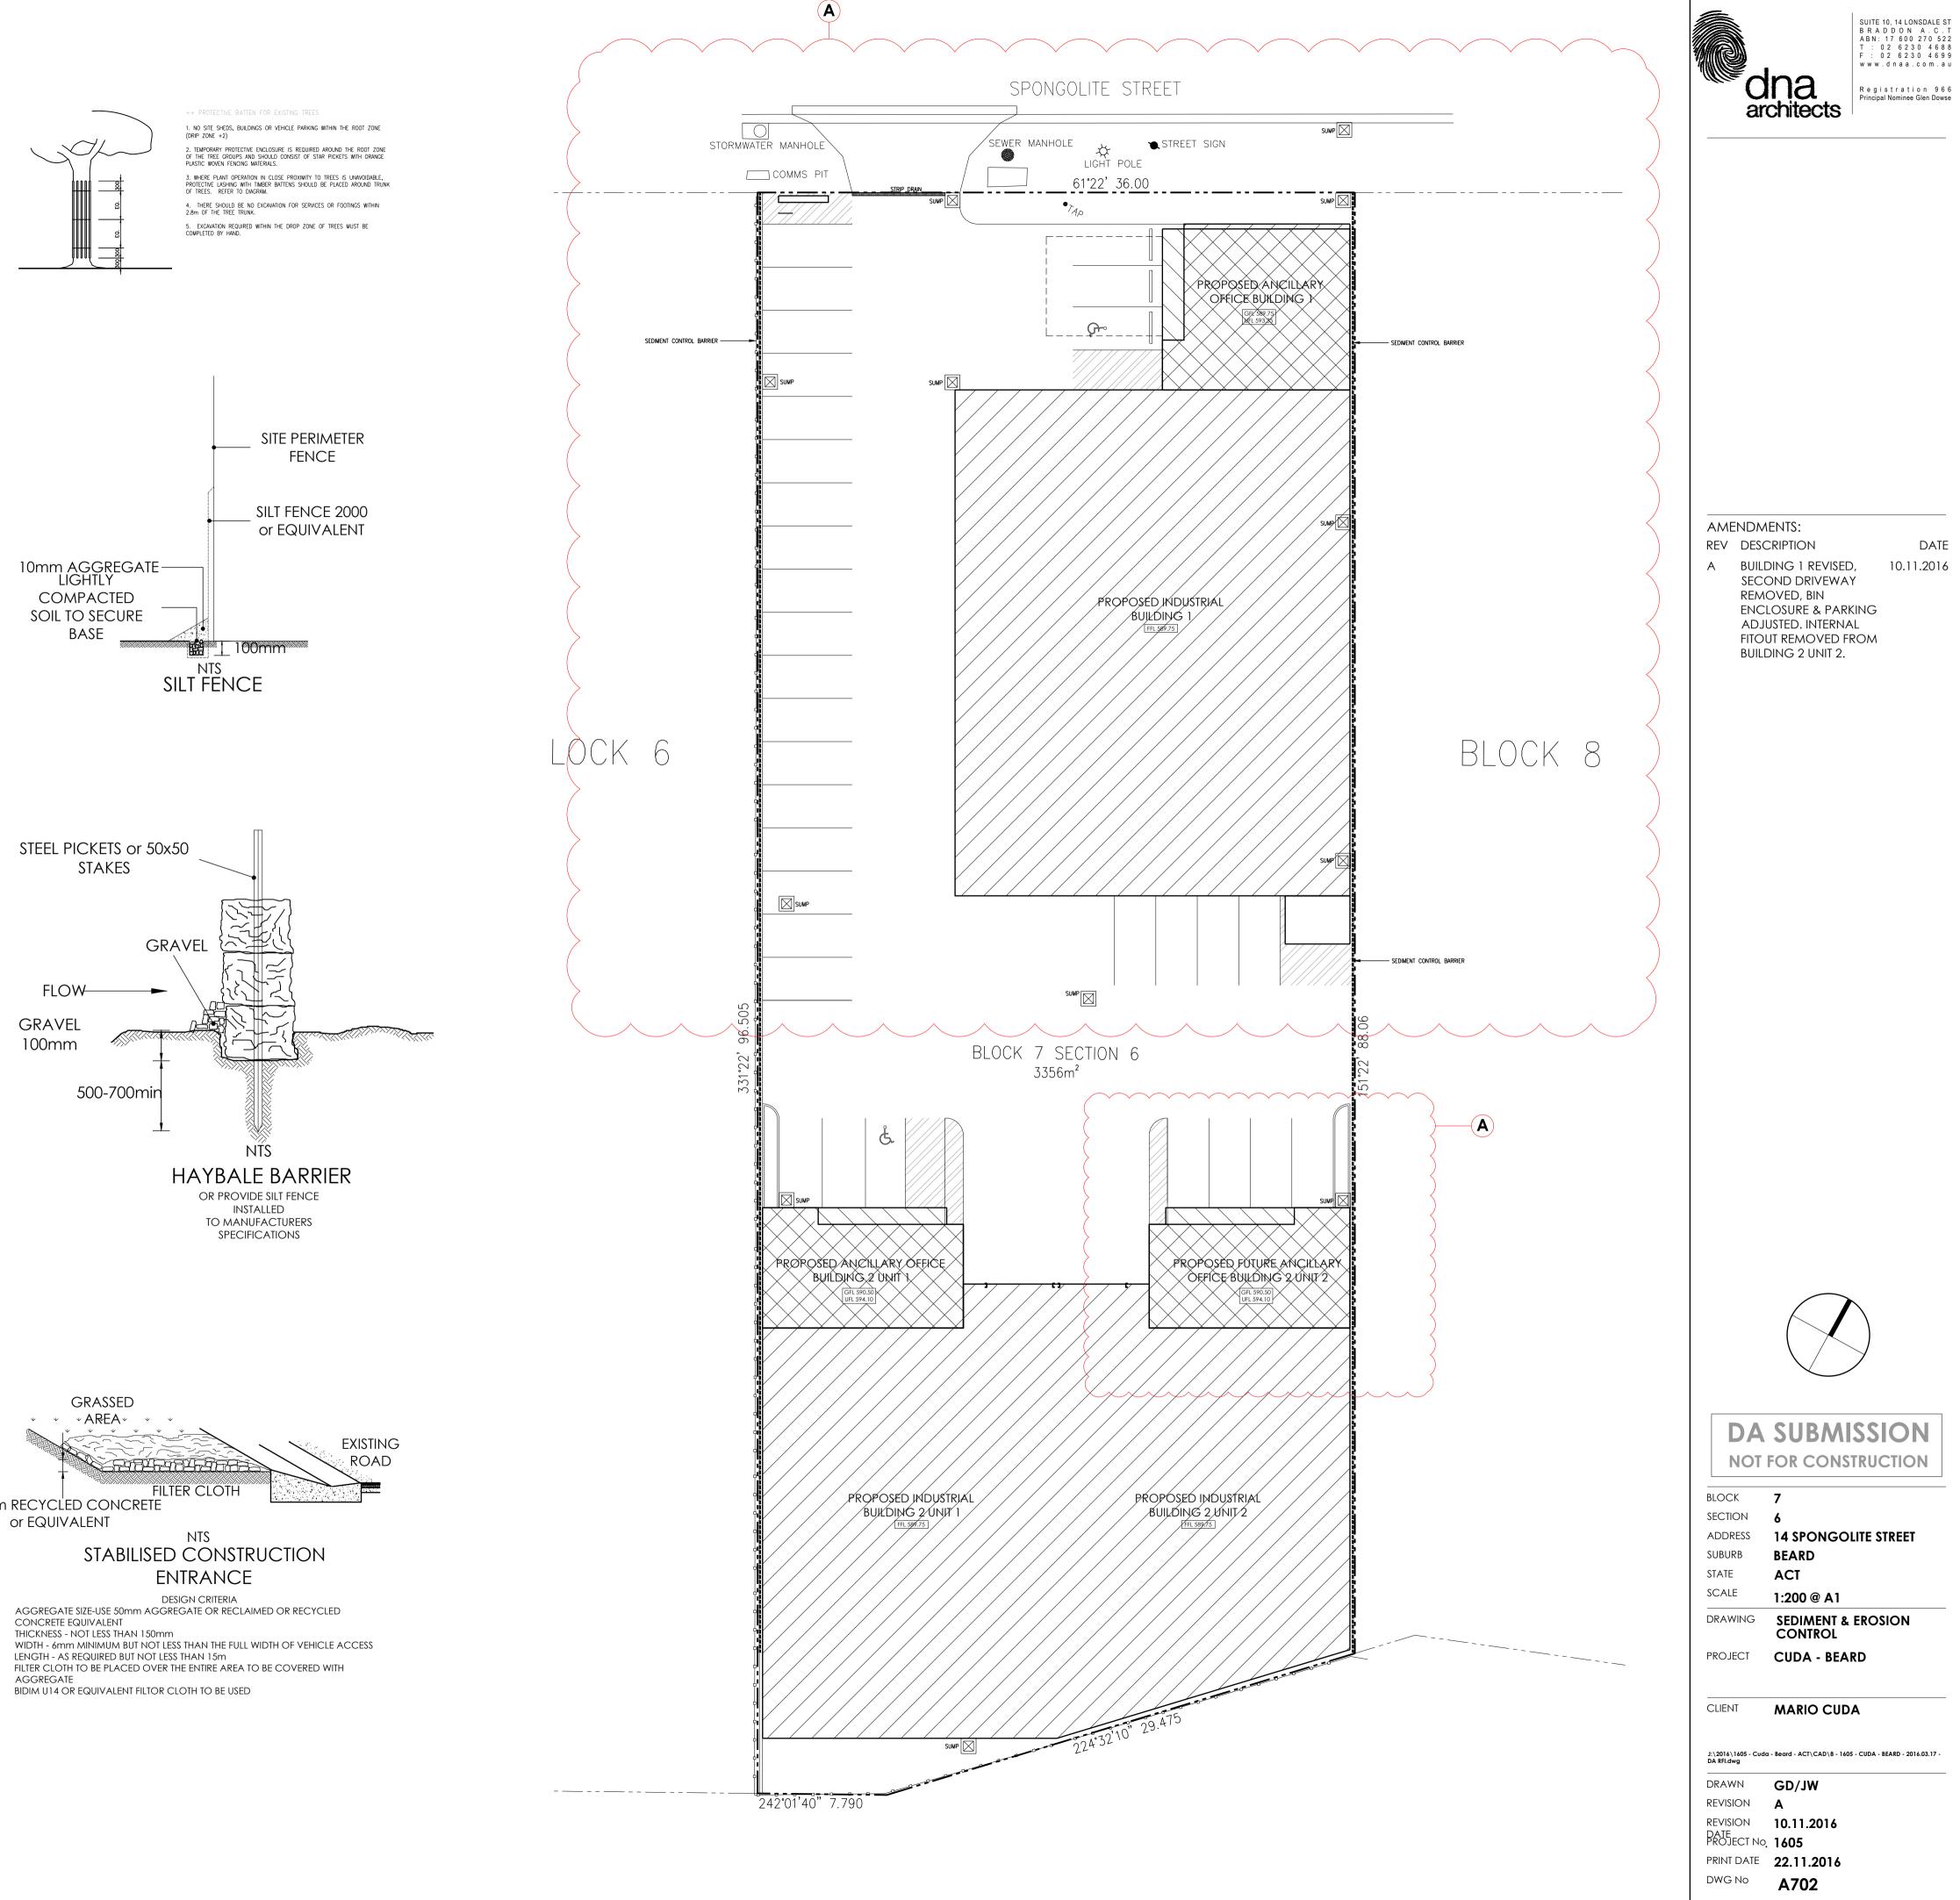

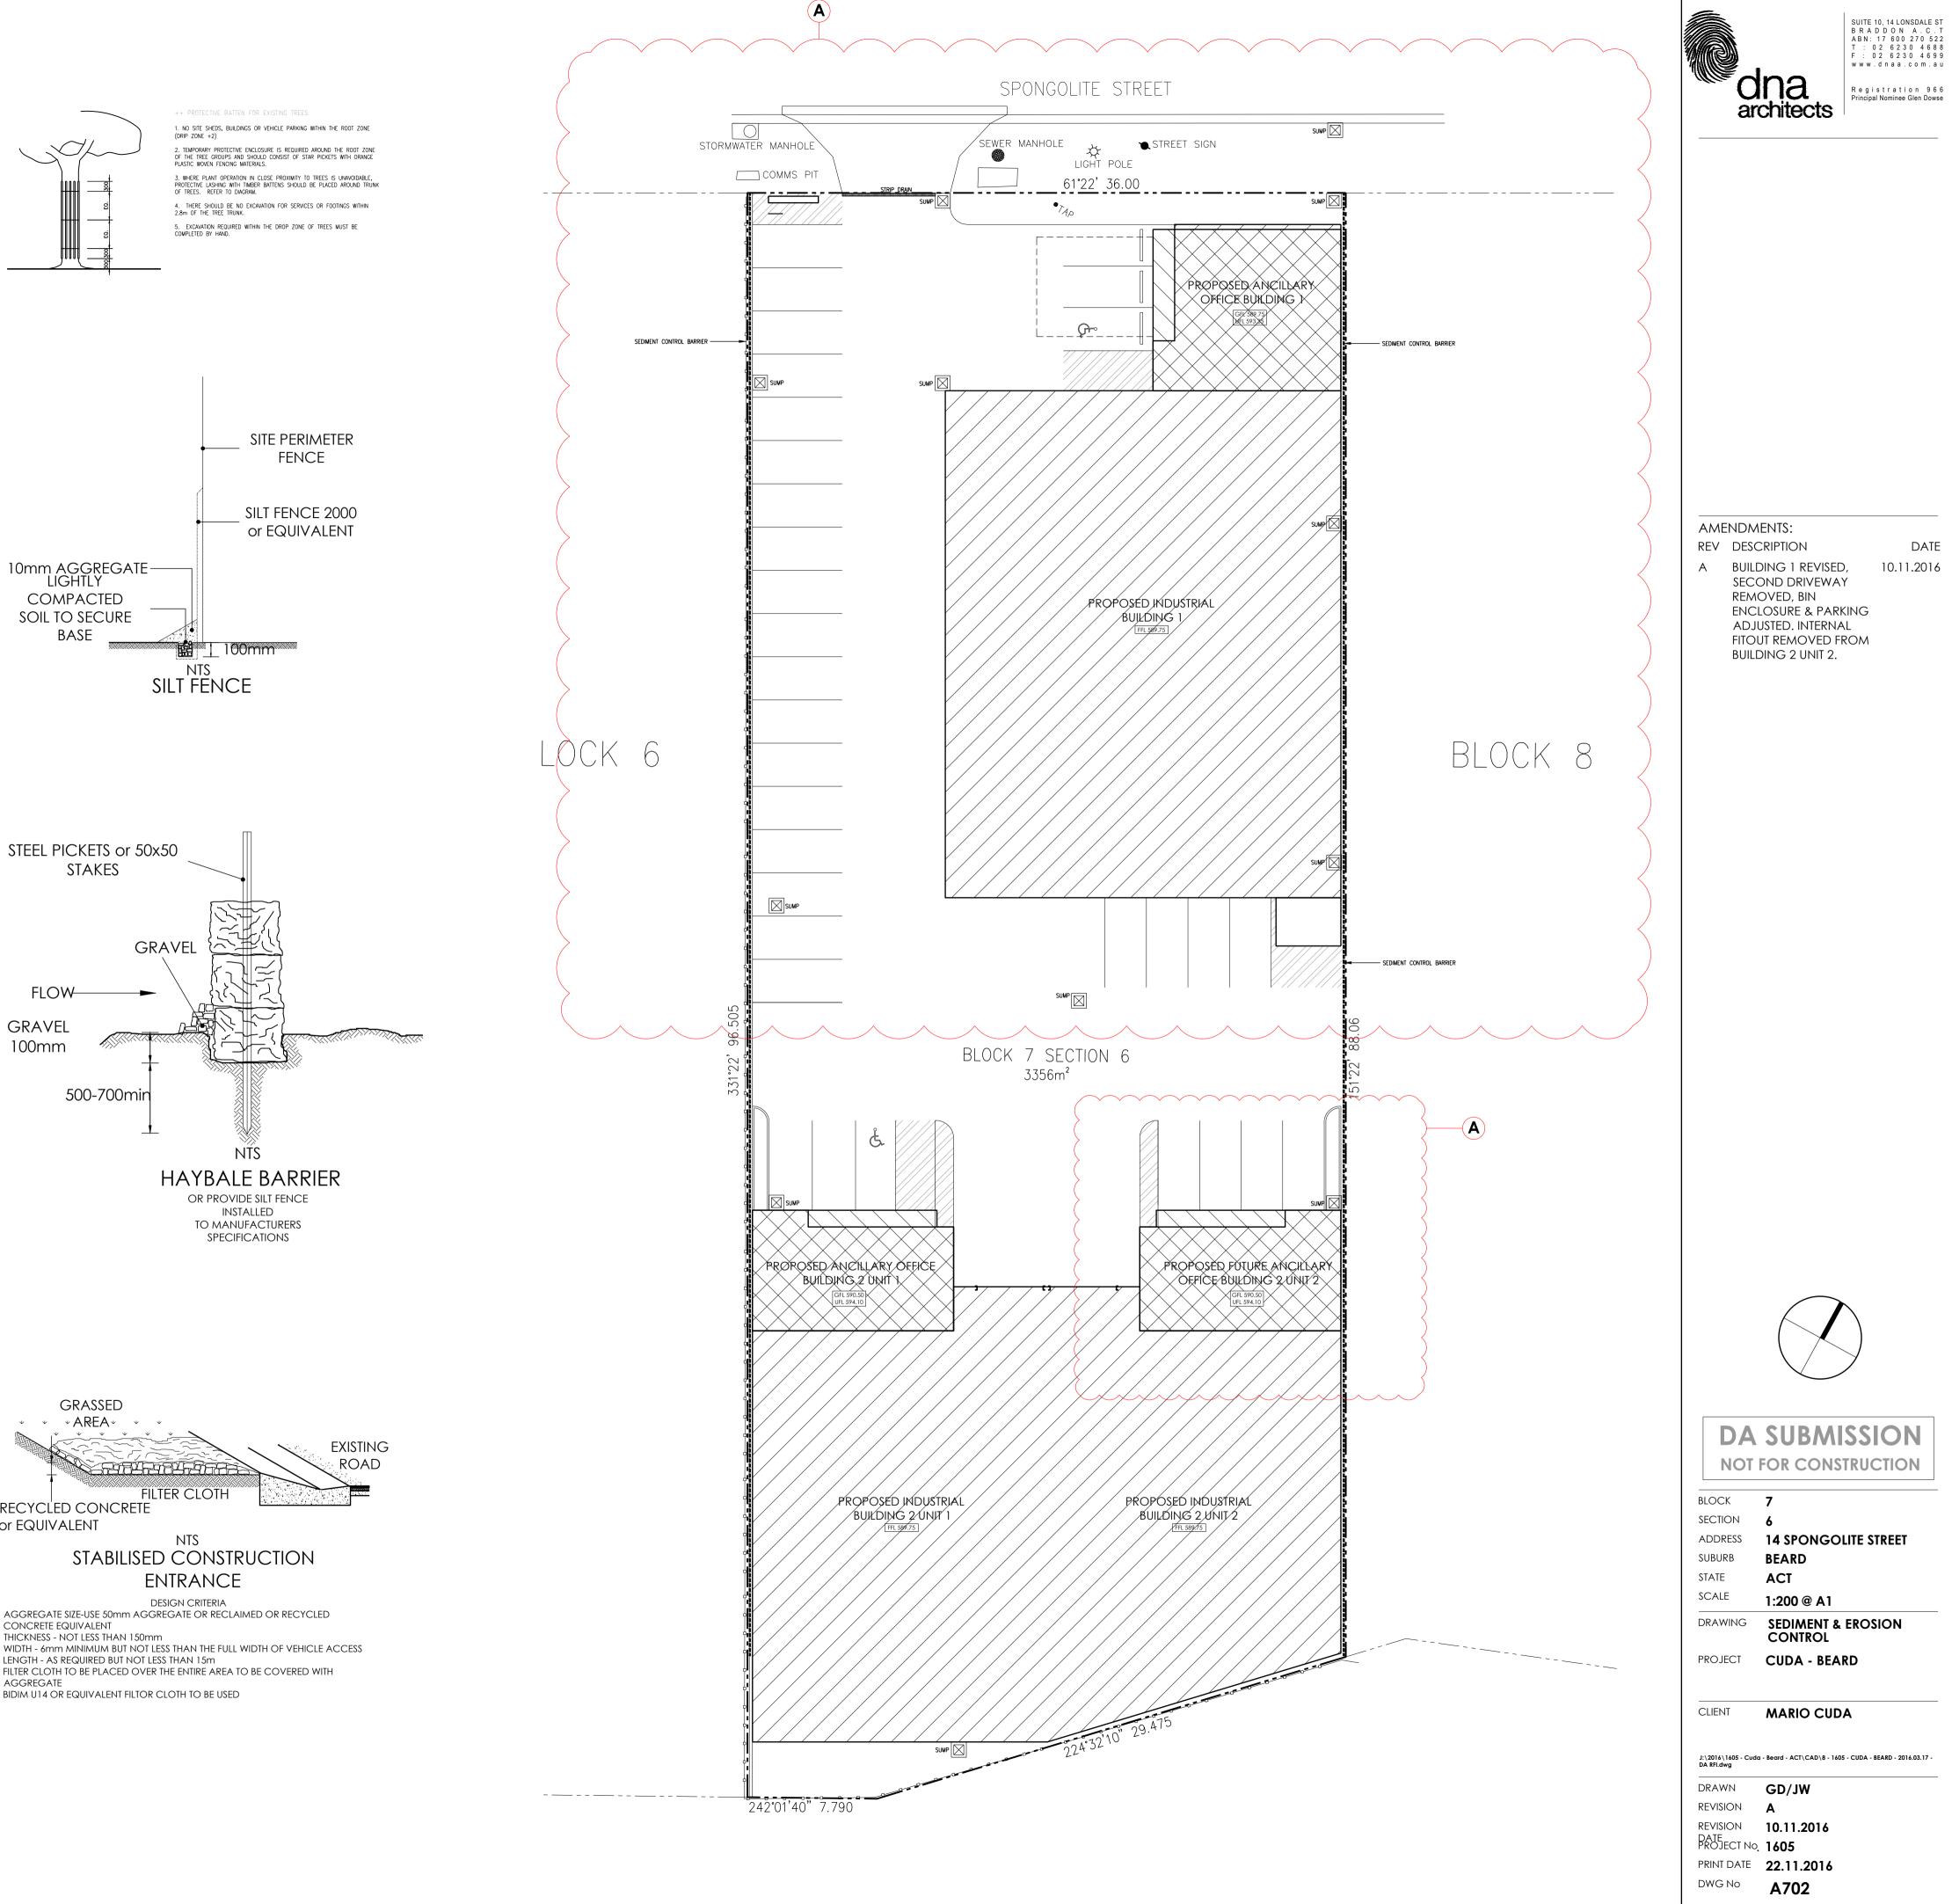

150mm RECYCLED CONCRETE