


TYPICAL STANDARD LIFT STATION

THESE TYPICAL LIFT STATION PLANS CONTAIN WWS MINIMUM REQUIREMENTS AND ARE INTENDED TO PROVIDE A BASIS FOR SITE ADAPTATION AND DESIGN BY A QUALIFIED ENGINEER. THE INFORMATION HEREIN CONTAINED SHALL ONLY BE USED AS A GENERAL GUIDELINE FOR THE INTENDED OPERATION AND FUNCTIONS AND SHALL NOT BE CONSTRUED AS ALL INCLUSIVE.

ENGINEER OF RECORD AND CONSULTANTS USING THESE GUIDELINES SHALL VERIFY AND MODIFY ANY REQUIREMENT NOT NECESSARILY SHOWN AS MAY BE REQUIRED BY ANY AND ALL APPLICABLE CODES AND STANDARDS.

FOR TRIPLEX STATIONS AND FOR ALL LIFT STATIONS REQUIRING AN ONSITE GENERATOR, DESIGNER SHALL CONSULT WITH WWS FOR ADDITIONAL REQUIREMENTS. THESE STANDARDS APPLY ONLY TO DUPLEX LIFT STATIONS.

ALL CHANGES TO THESE MINIMUM REQUIREMENTS SHALL BE CLEARLY IDENTIFIED WHEN SUBMITTING FOR APPROVAL.

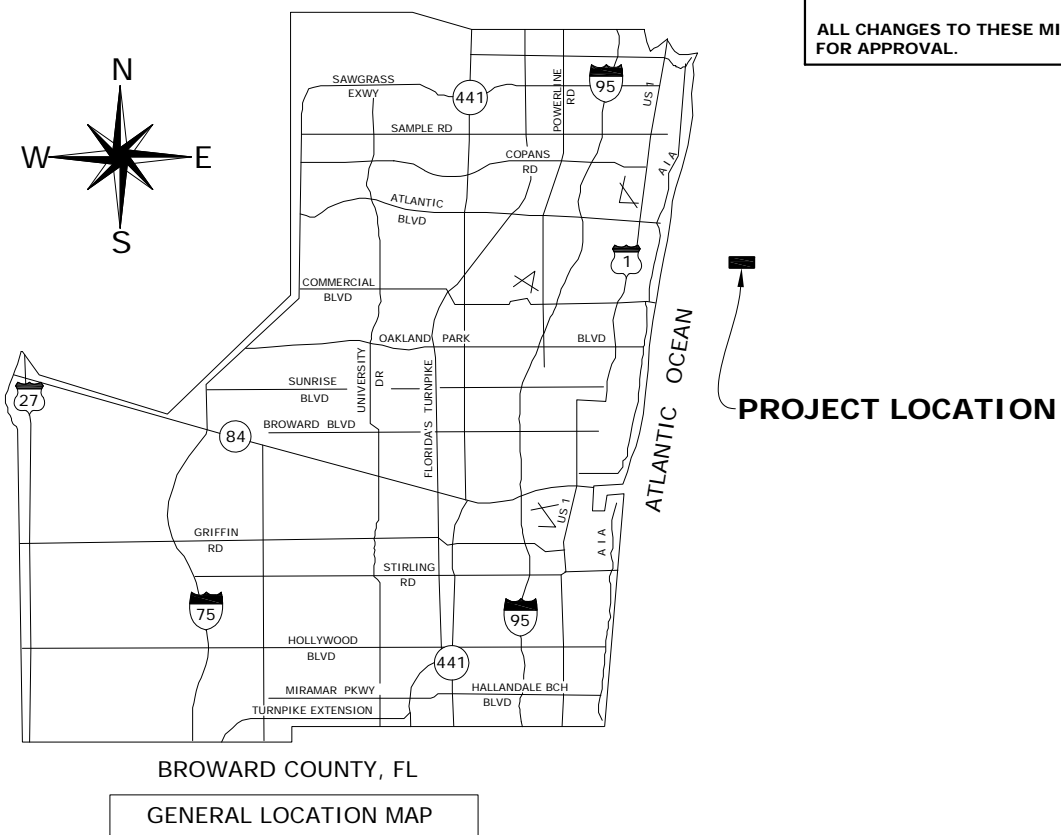

PRELIMINARY SET
6/2013

DRAWING INDEX

DESCRIPTION	SHEET DESIGNATION
COVER SHEET	G-1
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THE SIZE OF THESE PLANS MAY HAVE BEEN ALTERED BY REPRODUCTION. THIS MUST BE CONSIDERED WHEN OBTAINING DATA.

THE VERTICAL DATUM USED FOR THESE DRAWINGS WAS NAVD 88



CONTRACTOR TO COMPLY WITH FS CHAPTER 556 (UNDERGROUND FACILITY DAMAGE PREVENTION AND SAFETY ACT).

PROJECT NAME:
XXXXXXXXXXXXXXXXXXXX
XXXXXXXXXXXXXXXXXXXX
PROJECT NO XXXX
NOT FOR CONSTRUCTION

SEAL


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DATE:	REVISION DESCRIPTION:	

DRAWING NAME:
COVER SHEET

SCALE:
AS SHOWN

DWG NO:

DESIGNATION:
G-1

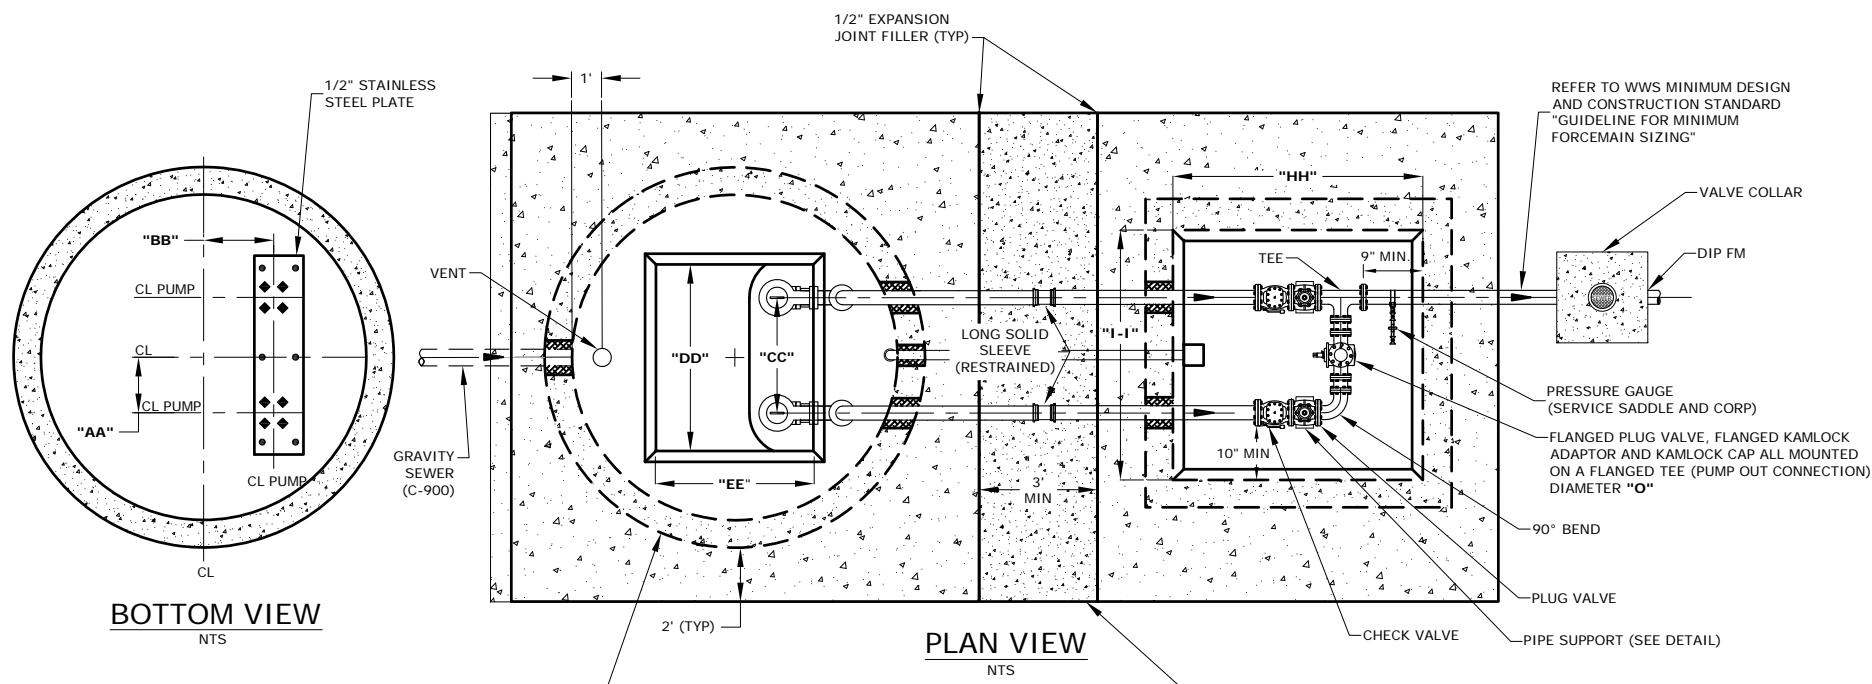


BOTTOM VIEW
NTS

PLAN VIEW
NTS

REFER TO WWS MINIMUM DESIGN AND CONSTRUCTION STANDARD "LIFT STATION WETWELL SIZING REQUIREMENTS"

CONCRETE SLAB BETWEEN WETWELL AND VAULT TOPS TO BE 4" THICK, UNREINFORCED, WITH EXPANSION JOINT MAT'L BETWEEN ADJACENT SLABS

LIFT STATION DATA TABLE	
LIFT STATION COMMON NAME	
PUMP MODEL NUMBER / IMPELLER SIZE	
WWS STANDARD CURVE #	
VOLTAGE/CYCLES/PHASE	
HORSE POWER	
RPM	
DESIGN POINT FLOW (GPM)	
DESIGN POINT HEAD (FT)	
SHUT-OFF HEAD (FT)	
MID-POINT FLOW (GPM)	
MID-POINT HEAD (FT)	
EFFICIENCY AT DESIGN POINT (%)	
RUN OUT FLOW (GPM)	
RUN OUT HEAD (FT)	
FINISHED TOP OF SLAB EL "A"	
WETWELL DIAMETER "B" (FT)	
WETWELL BOTTOM ELEVATION "C"	
INFLUENT PIPE DIAMETER (INCHES)	
INFLUENT PIPE INVERT ELEVATION "D"	
CHECK VALVE ELEVATION "E"	
ALARM ELEVATION "F"	
LAG PUMP "ON" ELEVATION "G"	
LEAD PUMP "ON" ELEVATION "H"	
BUBBLER ELEVATION "H-2"	
PUMPS "OFF" ELEVATION "I"	
ALARM/FLOAT PUMP "ON" ELEVATION "J"	
FLOAT PUMP "OFF" ELEVATION "K"	
PUMP DISCHARGE DIAMETER "L" (INCHES)	
DISCHARGE PIPE DIAMETER "M" (INCHES)	
DISCHARGE PIPE CL ELEVATION "N"	
PUMP OUT DIAMETER "O" (INCHES)	
WETWELL CL TO PUMP CL "AA" (IN)	
WETWELL CL TO PUMP CL "BB" (IN)	
PUMP CL TO PUMP CL "CC" (IN)	
MIN. WETWELL HATCH OPENING LENGTH "DD" (IN)	
MIN. WETWELL HATCH OPENING WIDTH "EE" (IN)	
VALVE VAULT WIDTH "HH" (IN)	
VALVE VAULT LENGTH "II" (IN)	
WETWELL BOTTOM TO VOLUTE BOTTOM "KK" (IN)	

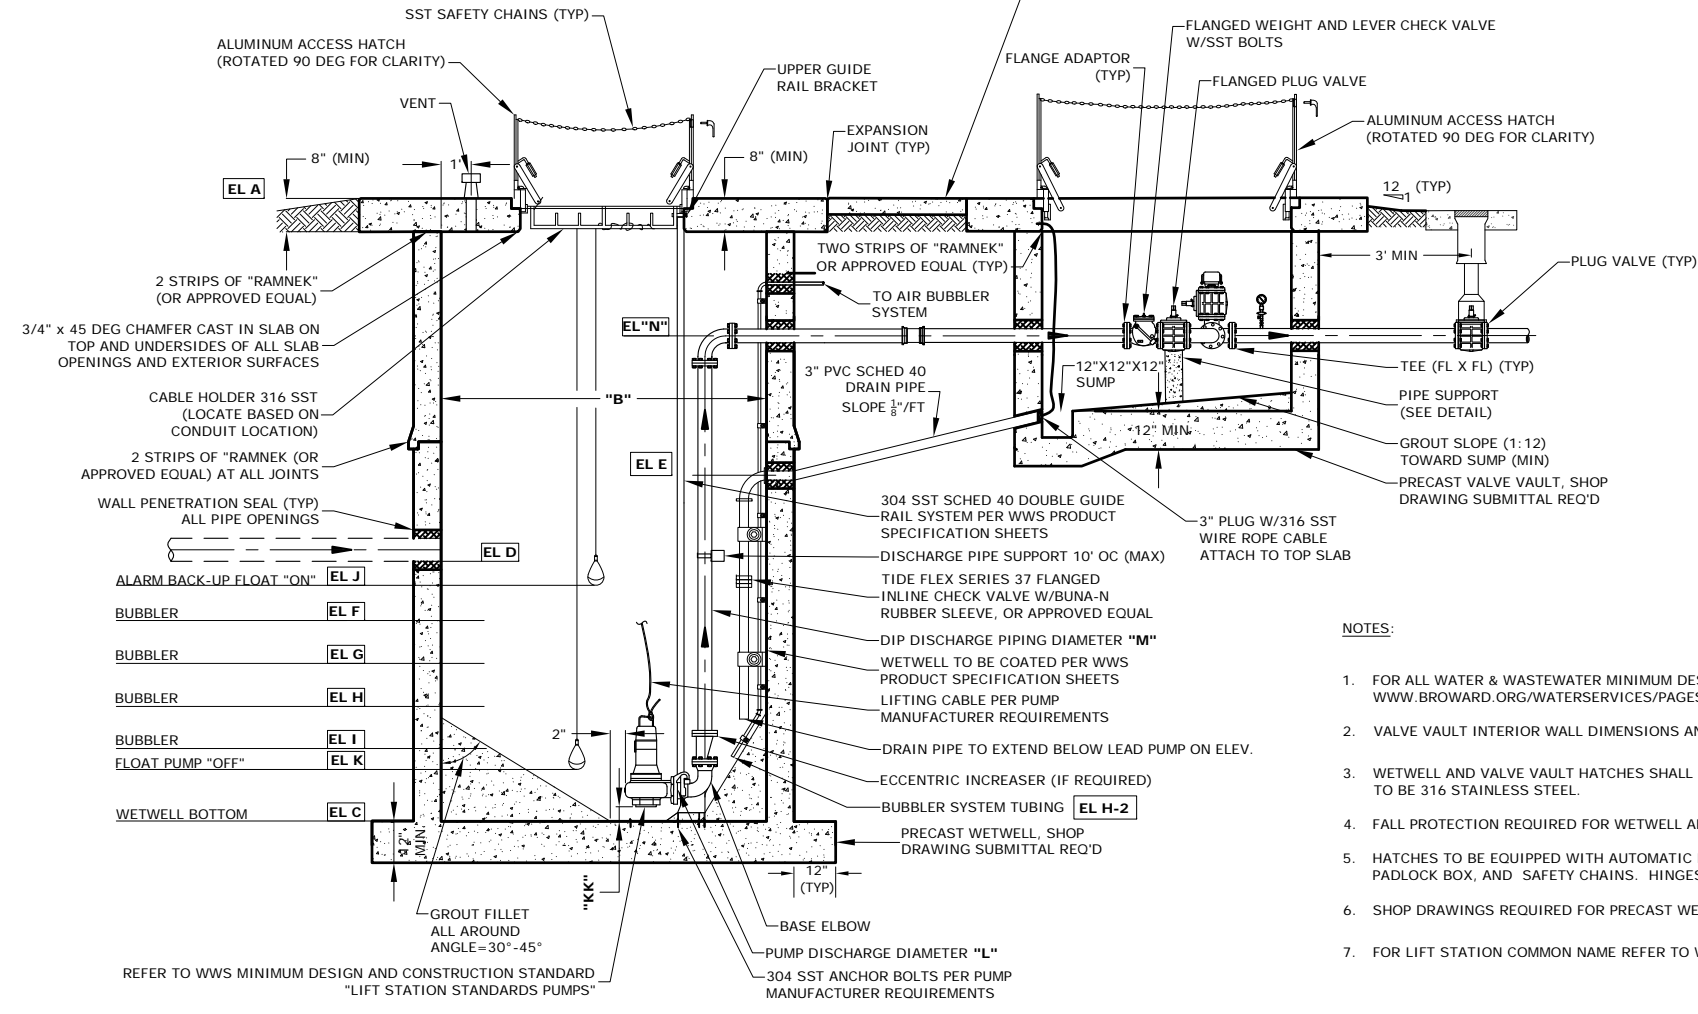

ELEVATION
NTS

REFER TO WWS MINIMUM DESIGN AND CONSTRUCTION STANDARD "LIFT STATION STANDARDS PUMPS"



NOTES:

- FOR ALL WATER & WASTEWATER MINIMUM DESIGN AND CONSTRUCTION STANDARDS VISIT THE WWS WEBSITE AT: WWW.BROWARD.ORG/WATERSERVICES/PAGES/MINIMUMDESIGNANDCONSTRUCTIONSTANDARDS.ASPX
- VALVE VAULT INTERIOR WALL DIMENSIONS AND HATCH FRAME OPENING DIMENSIONS TO BE 60"X60" OR 72"X72" AS DIRECTED BY WWS.
- WETWELL AND VALVE VAULT HATCHES SHALL BE US FOUNDRY, HALLIDAY (OR APPROVED EQUAL) THD/TPD ALUMINUM ACCESS HATCHES. ALL HARDWARE TO BE 316 STAINLESS STEEL.
- FALL PROTECTION REQUIRED FOR WETWELL AND VALVE VAULT (SUBMITTAL REQUIRED).
- HATCHES TO BE EQUIPPED WITH AUTOMATIC HOLD OPEN ARMS, HORIZONTAL COMPRESSION SPRINGS, WATERTIGHT SLAM LOCKS, RECESSED OVERSIZE PADLOCK BOX, AND SAFETY CHAINS. HINGES TO BE ATTACHED USING TAMPER PROOF CARRIAGE BOLTS WITH WELDED NUTS.
- SHOP DRAWINGS REQUIRED FOR PRECAST WETWELL, VALVE VAULT AND TOP SLABS. ALL PRECAST STRUCTURES MUST MEET ASTM C478 SPECIFICATIONS
- FOR LIFT STATION COMMON NAME REFER TO WWS MINIMUM DESIGN AND CONSTRUCTION STANDARD "RETAIL LIFT STATION NAMING CONVENTION"

PROJECT NAME:
XXXXXXXXXXXXXXXXXXXX
XXXXXXXXXXXXXXXXXXXX
PROJECT NO XXXX
NOT FOR CONSTRUCTION

SEAL

DESIGN:	DRAWN:	CHECK:
DATE:	REVISION DESCRIPTION:	
DRAWING NAME: PLAN AND ELEVATION		
SCALE: AS SHOWN	DWG NO:	
DESIGNATION: M-1		

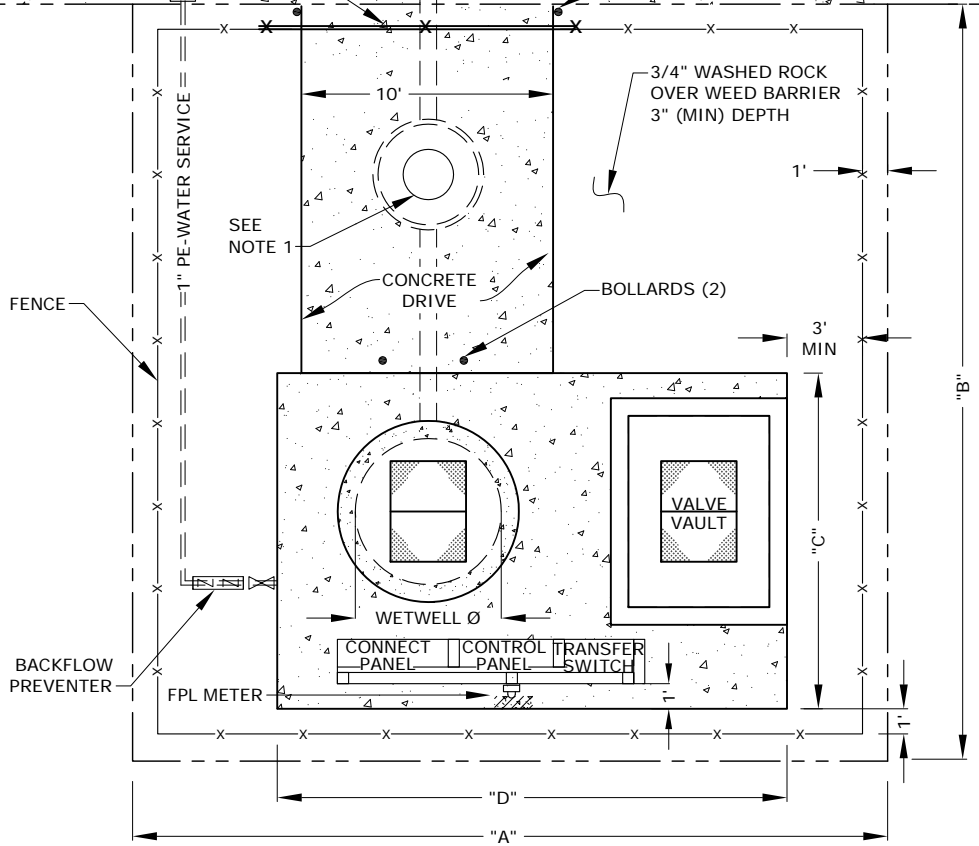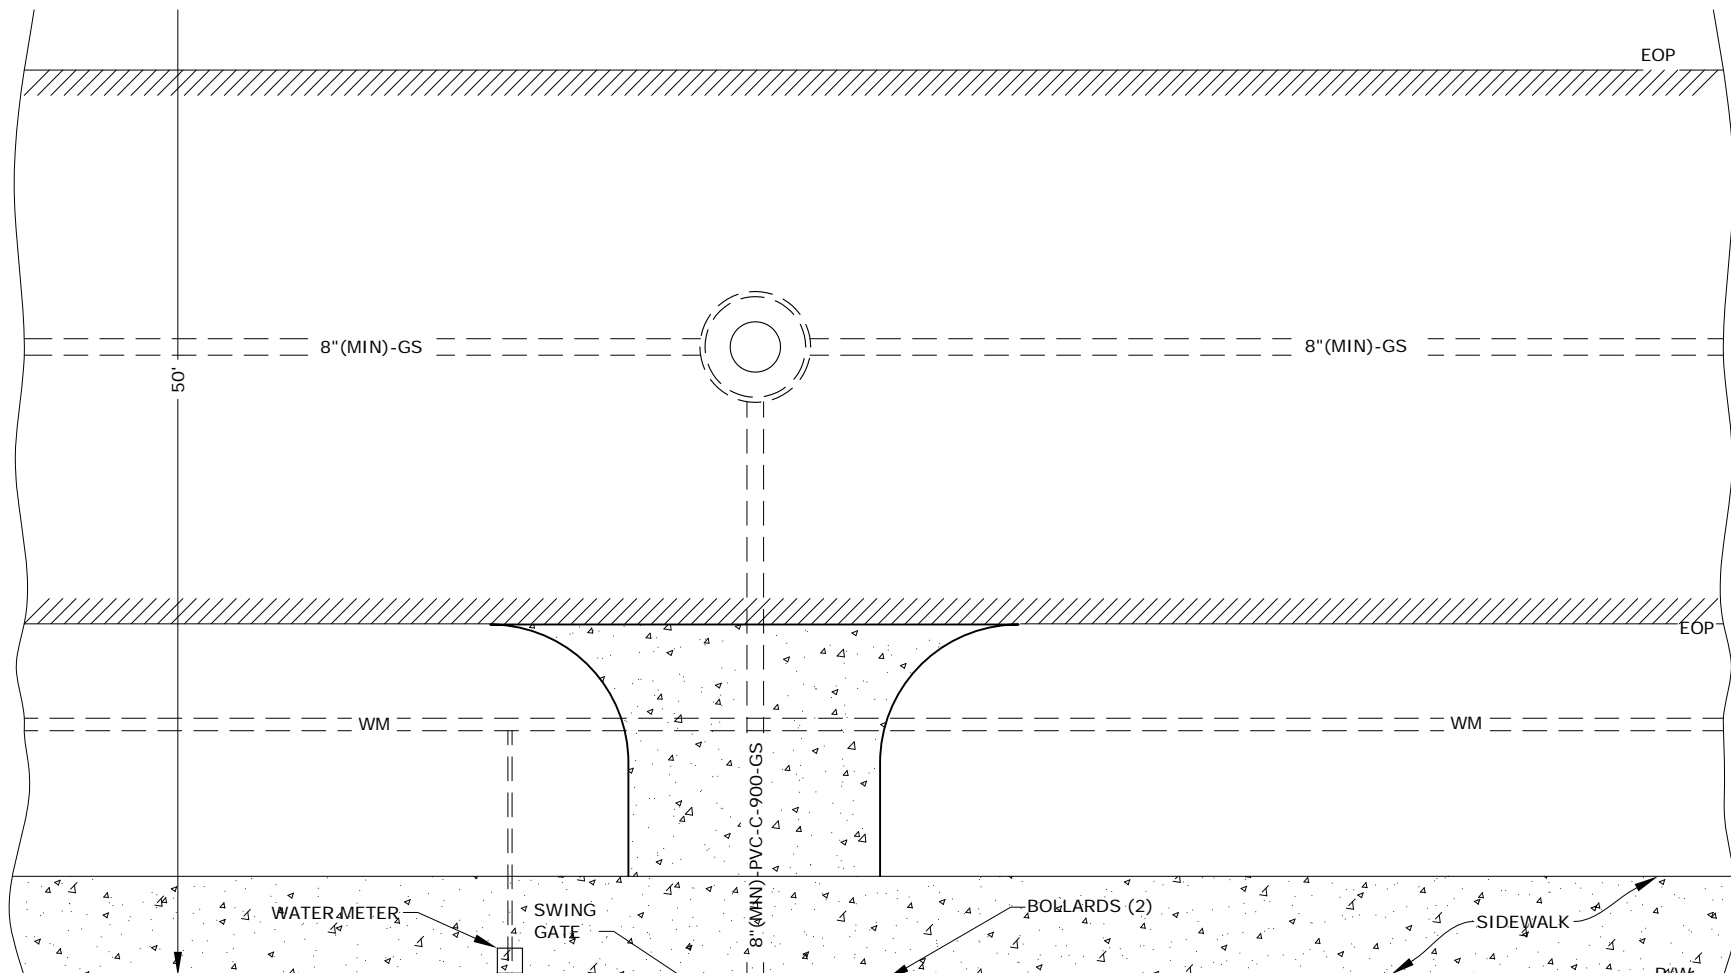

TYPICAL SITE PLAN
NTS

NOTES:

1. MAINTENANCE ACCESS STRUCTURES SHALL BE INSTALLED WITHIN THE PUMP STATION EASEMENT AS SHOWN UNLESS WWS DIRECTS OTHERWISE.
2. FINISH GRADE ELEVATION FOR WETWELL AND VALVE VAULT SHALL BE A MINIMUM OF ONE FOOT ABOVE THE FEMA 100 YR FLOOD ELEVATION OR NOT LOWER THAN CROWN OF ROAD.
3. ALL CONCRETE SLABS ON GRADE SHALL BE CLASS A.
4. DRIVEWAY SHALL BE 6-INCH THICK CONCRETE, WITHOUT REINFORCEMENT, UNLESS WWS DIRECTS OTHERWISE.
5. THIS SITE LAYOUT IS GENERAL IN NATURE AND SHOULD BE MODIFIED AS REQUIRED FOR EACH INDIVIDUAL LIFT STATION. WWS RESERVES THE RIGHT TO MODIFY PROPOSED LAYOUT TO MEET OPERATIONAL NEEDS.

WETWELL DIAMETER	"A"	"B"	"C"	"D"
6'	30.00'	30.00'	13.34'	20.25'
8'	30.00'	30.00'	16.34'	22.25'
10'	32.00'	32.00'	19.00'	27.50'
12'	35.00'	35.00'	20.00'	29.00'

PROJECT NAME:
XXXXXXXXXXXXXXXXXXXX
XXXXXXXXXXXXXXXXXXXX
PROJECT NO XXXX

NOT FOR CONSTRUCTION

SEAL


DESIGN:	DRAWN:	CHECK:
DATE:	REVISION DESCRIPTION:	

DRAWING NAME:
SITE PLAN


SCALE:
AS SHOWN

DESIGNATION:
M-2

L:\EED_DATA\CAD STANDARDS\WWS STD SUBMITTALS\LIFT STATION TO DEVELOPER\WWS WEBSITE 6.6.2013\WWDWED LIFT STATIONS\TEMPLATE.dwg, STD DETAILS (M-3), 6/6/2013 3:53:30 PM, CBGARCIA, Adobe PDF.pcc3

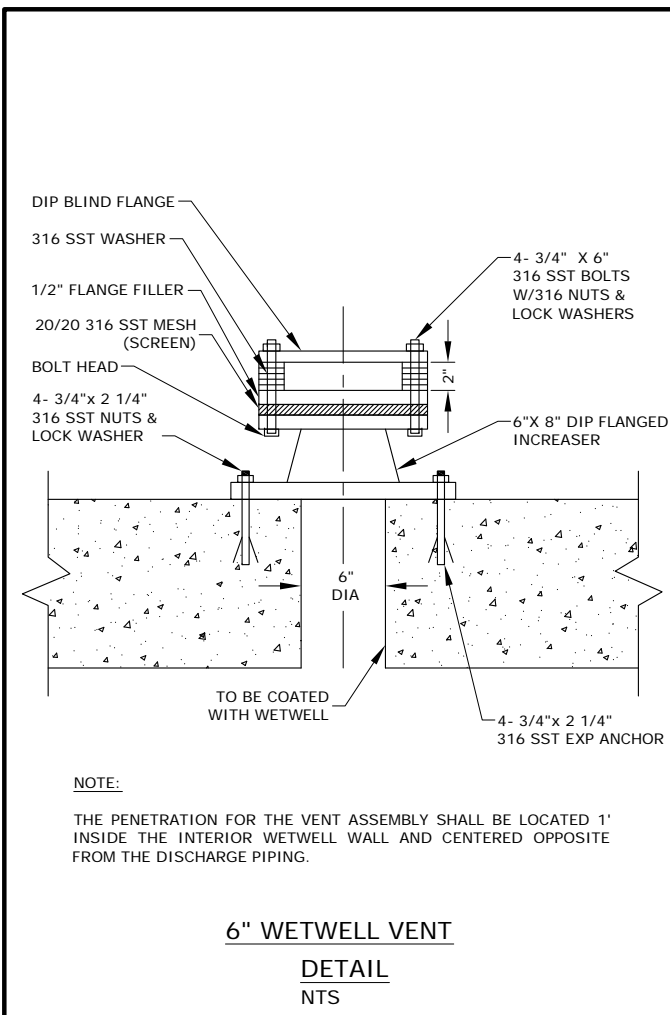


6" WETWELL VENT
DETAIL
NTS

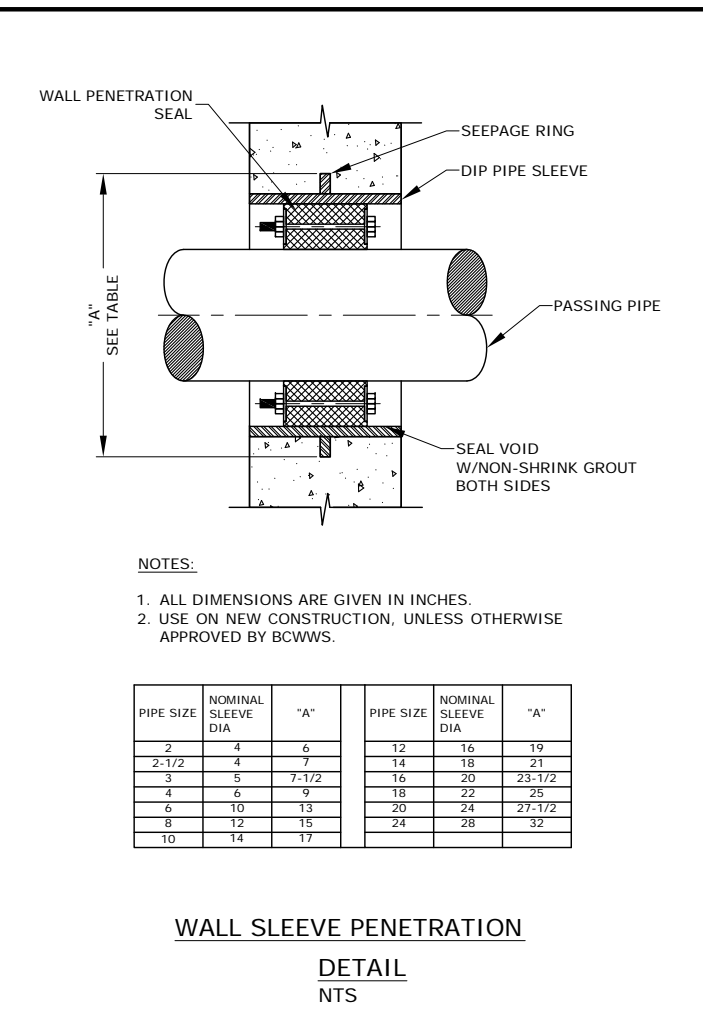

WALL SLEEVE PENETRATION
DETAIL
NTS

NOTES:
1. ALL DIMENSIONS ARE GIVEN IN INCHES.
2. USE ON NEW CONSTRUCTION, UNLESS OTHERWISE APPROVED BY BCWWS.


PIPE SIZE	NOMINAL SLEEVE DIA	"A"	PIPE SIZE	NOMINAL SLEEVE DIA	"A"
2	4	6	12	16	19
2-1/2	4	7	14	18	21
3	5	7-1/2	16	20	23-1/2
4	6	9	18	22	25
6	10	13	20	24	27-1/2
8	12	15	24	28	32
10	14	17			

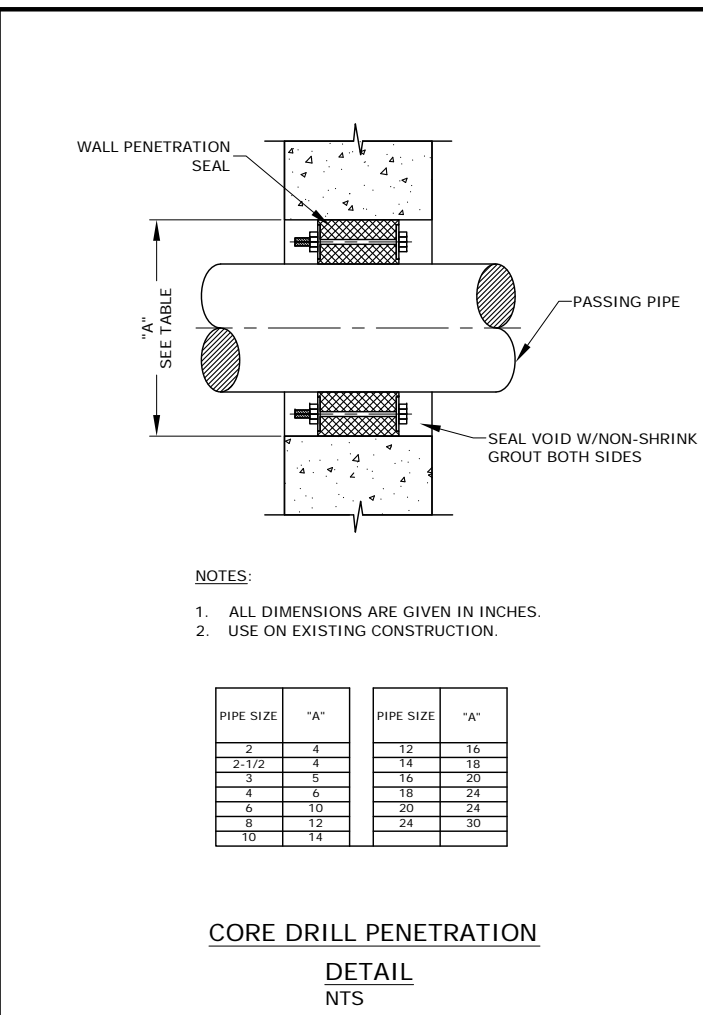


CORE DRILL PENETRATION
DETAIL
NTS

NOTES:
1. ALL DIMENSIONS ARE GIVEN IN INCHES.
2. USE ON EXISTING CONSTRUCTION.


PIPE SIZE	"A"	PIPE SIZE	"A"
2	4	12	16
2-1/2	4	14	18
3	5	16	20
4	6	18	24
6	10	20	24
8	12	24	30
10	14		

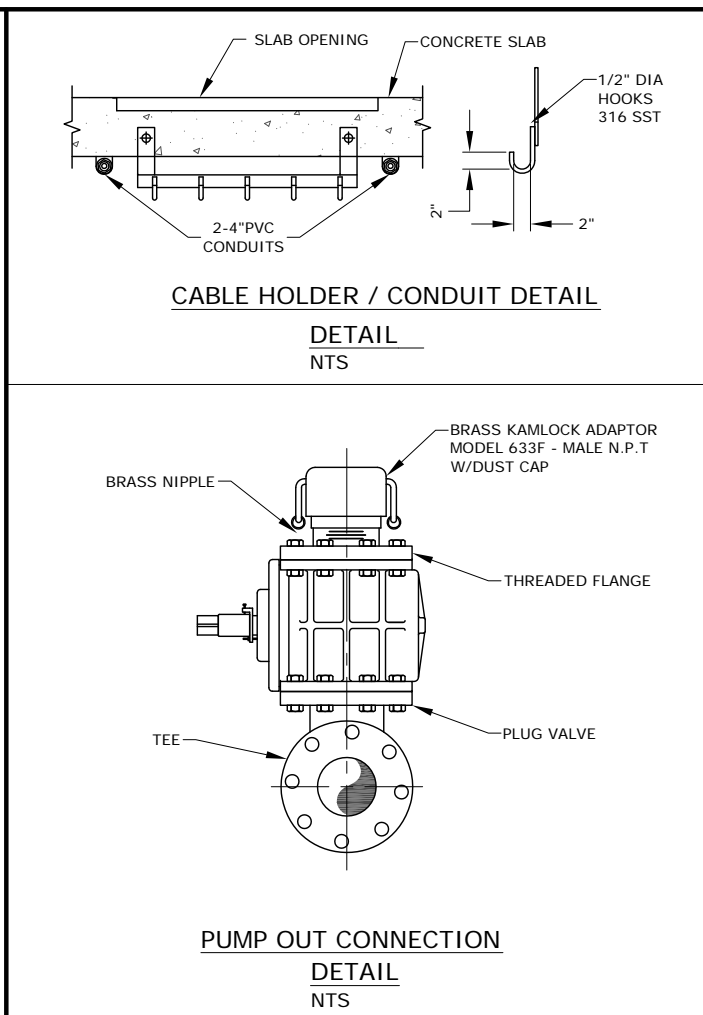


CABLE HOLDER / CONDUIT DETAIL
DETAIL
NTS

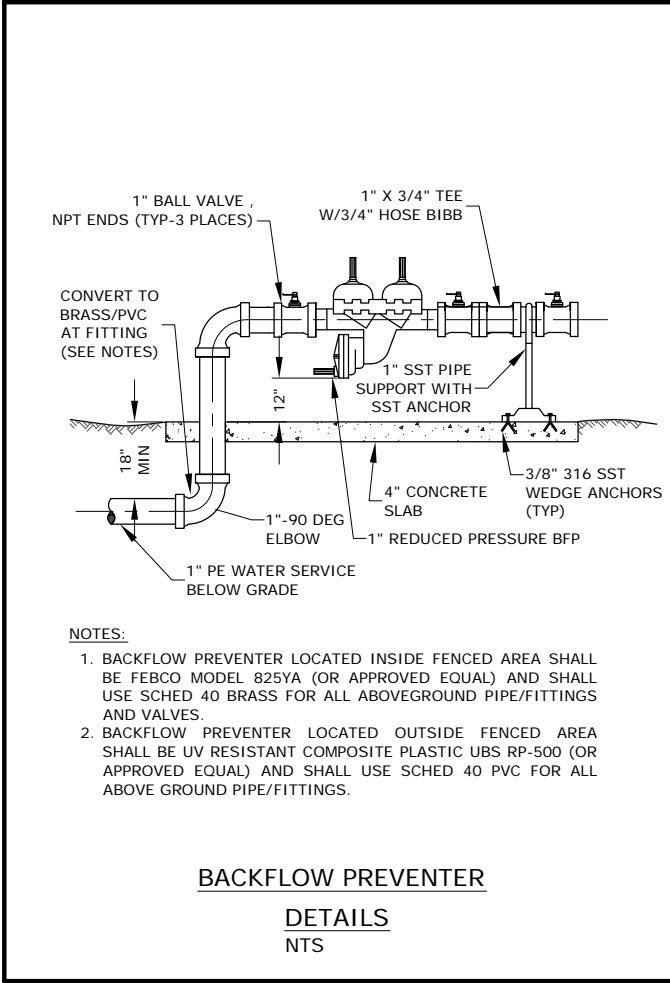


BACKFLOW PREVENTER
DETAILS
NTS

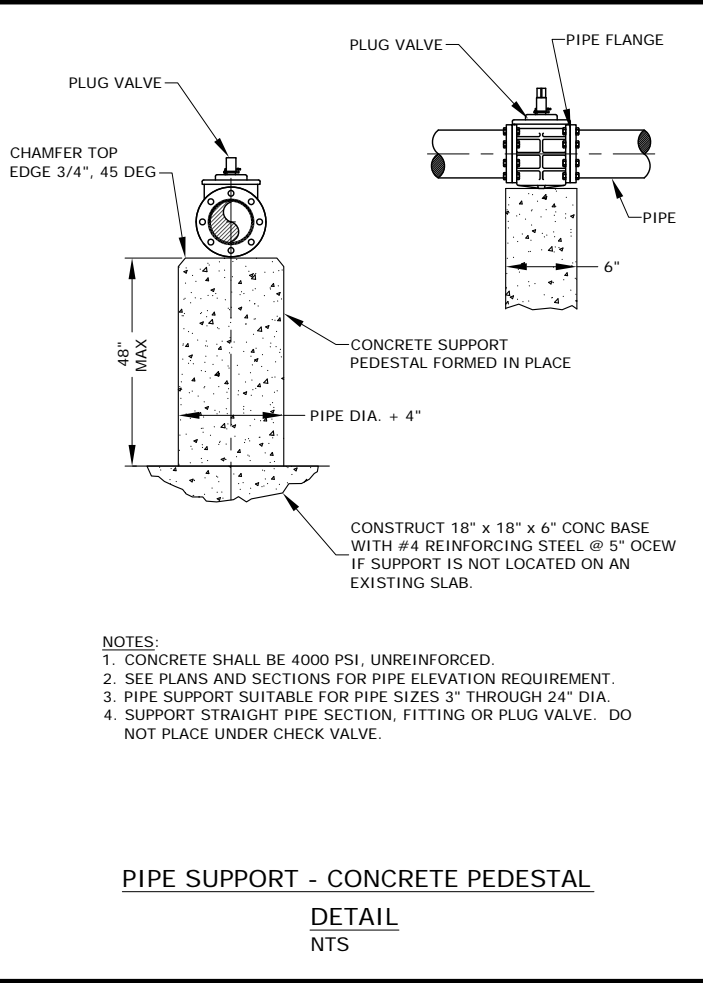

PIPE SUPPORT - CONCRETE PEDESTAL
DETAIL
NTS

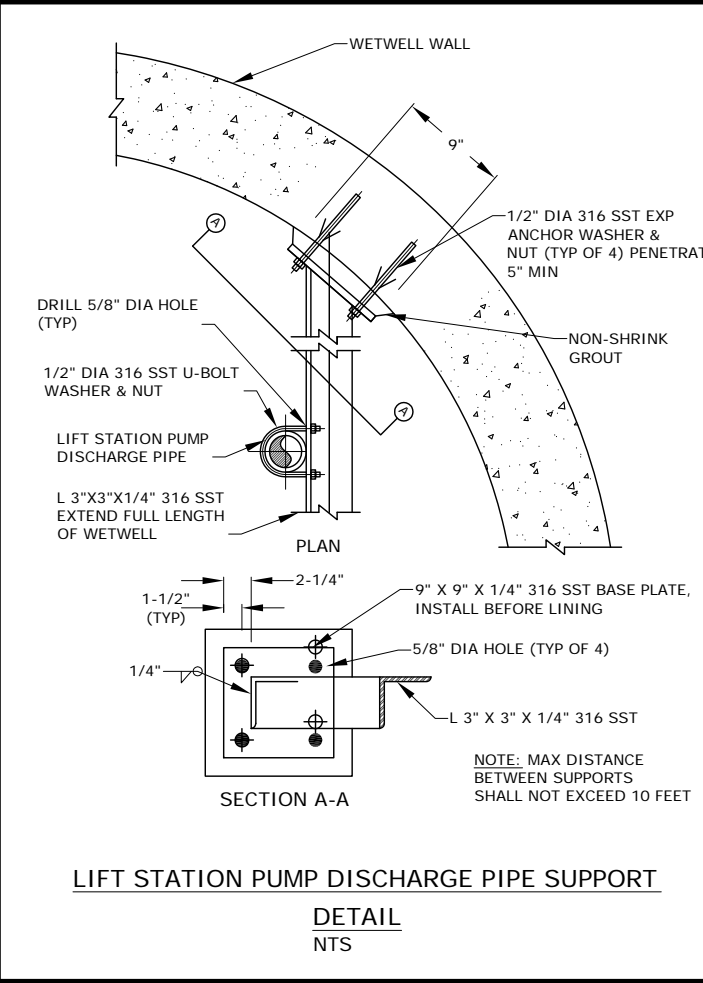

LIFT STATION PUMP DISCHARGE PIPE SUPPORT
DETAIL
NTS

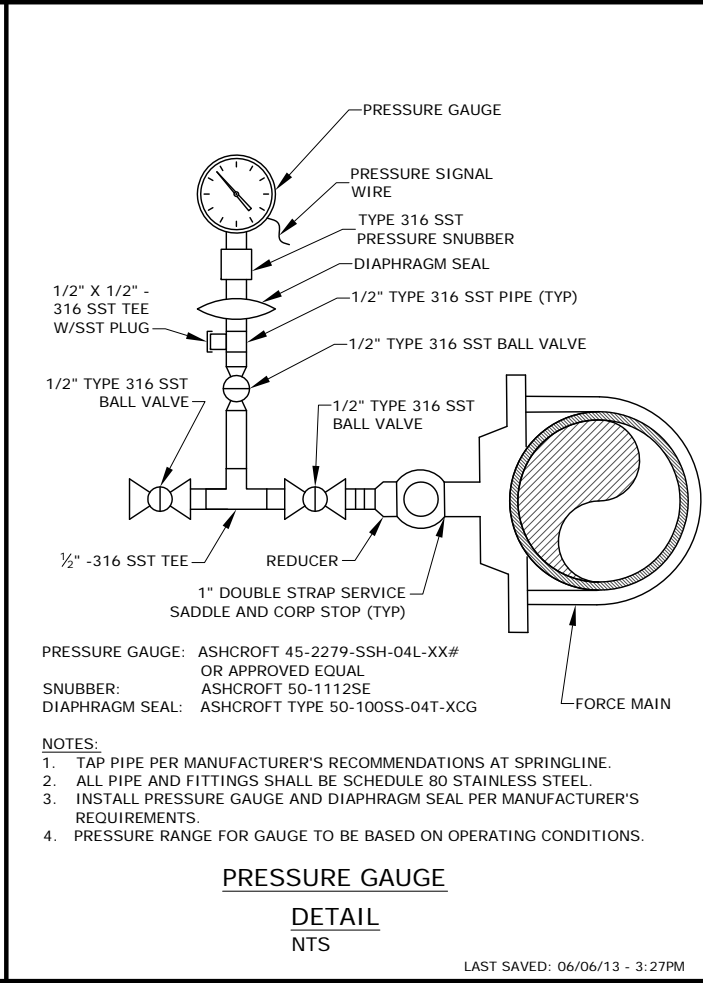

PRESSURE GAUGE
DETAIL
NTS

PROJECT NAME:
XXXXXXXXXXXXXXXXXXXX
XXXXXXXXXXXXXXXXXXXX
PROJECT NO XXXX

NOT FOR CONSTRUCTION

DESIGN: _____ DRAWN: _____ CHECK: _____
DATE: _____ REVISION DESCRIPTION: _____


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STANDARD DETAILS

SCALE: AS SHOWN DWG NO: _____


DESIGNATION:
M-3

LAST SAVED: 06/06/13 - 3:27PM


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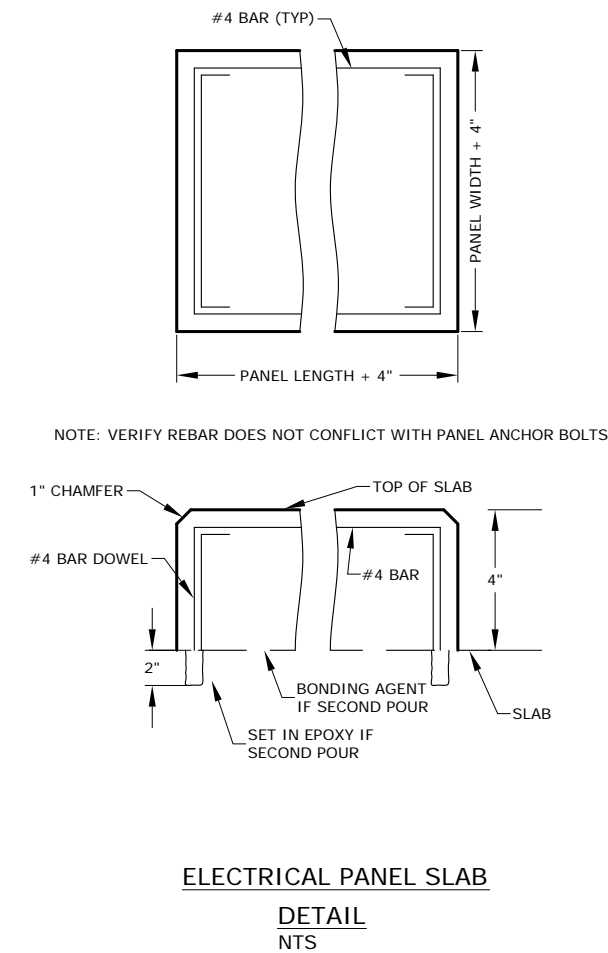
PUMP PLATFORM
DETAIL
NTS

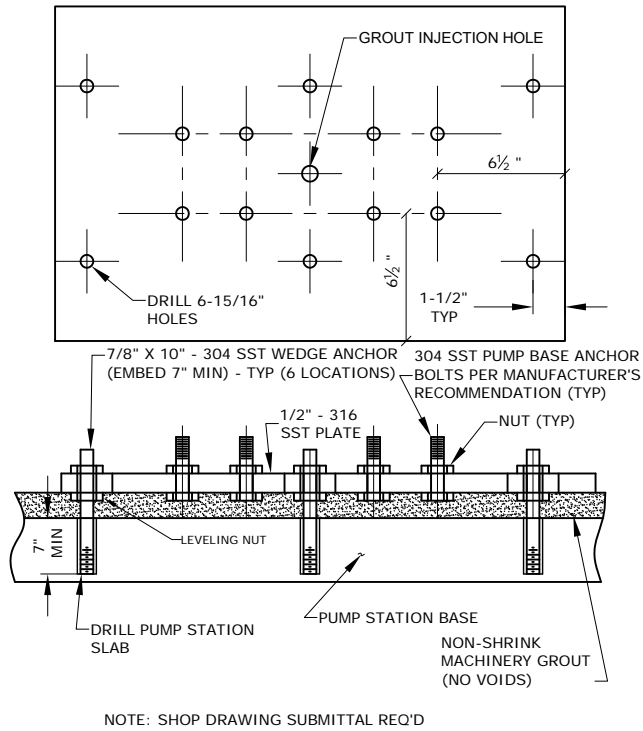


CHAIN-LINK FENCE
DETAIL
NTS

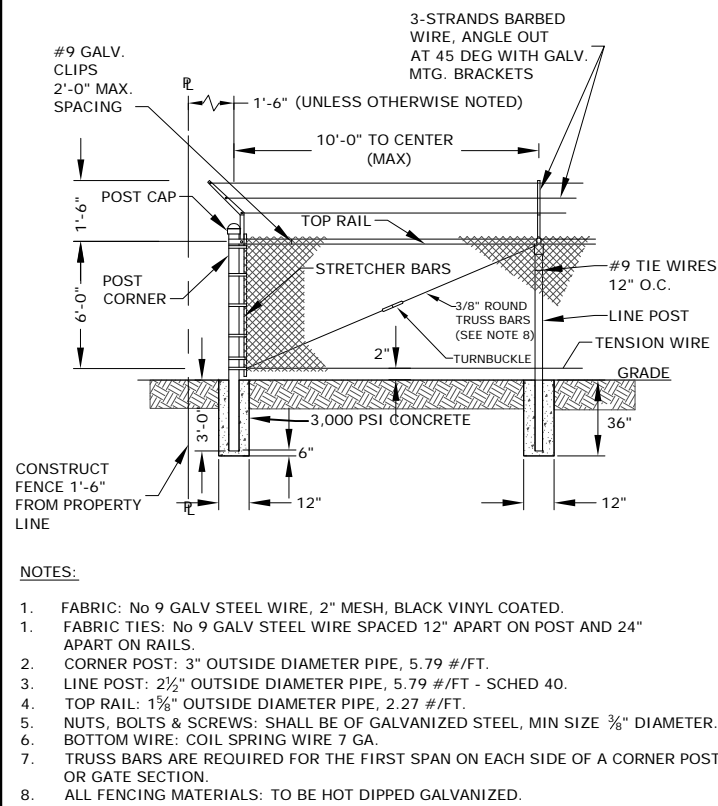


12' SWING GATE
DETAIL
NTS

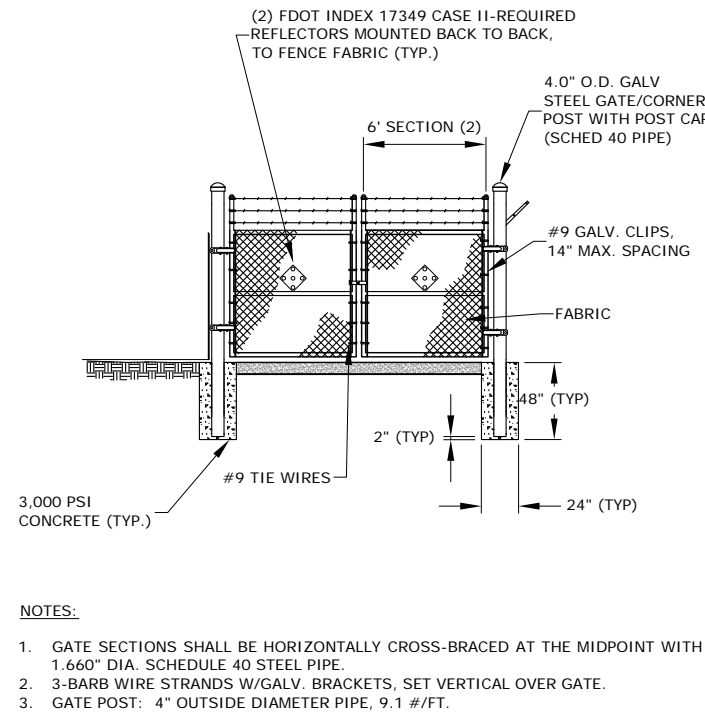

ELECTRICAL PANEL SLAB
DETAIL
NTS

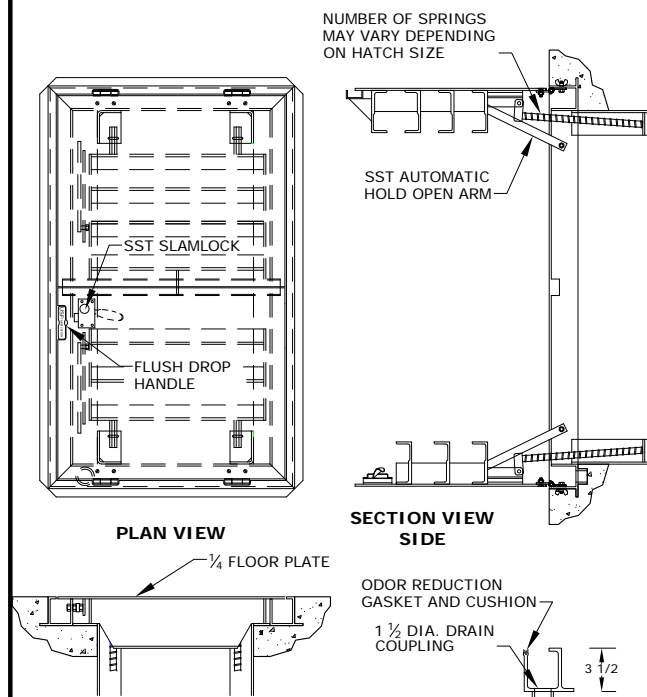

TROUGH FRAME, HEAVY-DUTY, DOUBLE ACCESS DOOR COVER (THD)
DETAIL
NTS

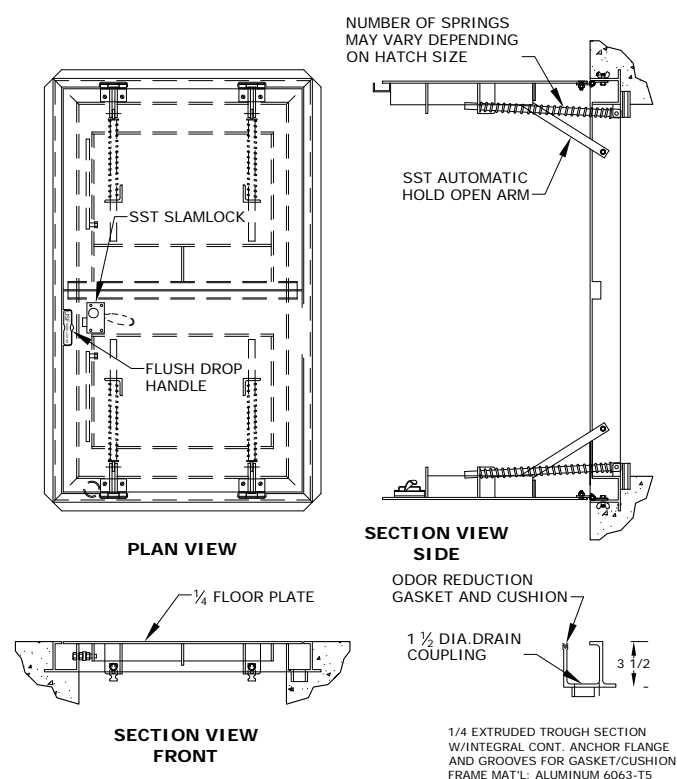

TROUGH FRAME, PEDESTRIAN, DOUBLE ACCESS DOOR COVER (TPD)
DETAIL
NTS

PROJECT NAME:

XXXXXXXXXXXXXXXXXXXX

XXXXXXXXXXXXXXXXXXXX

PROJECT NO XXXX

NOT FOR CONSTRUCTION

SEAL

DESIGN:	DRAWN:	CHECK:
DATE:	REVISION DESCRIPTION:	

DRAWING NAME:
STANDARD DETAILS

SCALE:
AS SHOWN

DWG NO:

DESIGNATION:
M-4

TO BE COMPLETED
BY ENGINEER OF RECORD

SITE PLAN
SCALE:

TO BE COMPLETED
BY ENGINEER OF RECORD

ELECTRICAL RISER DIAGRAM
NTS


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NOT FOR CONSTRUCTION	

SEAL


DESIGN:	DRAWN:	CHECK:
DATE:	REVISION DESCRIPTION:	

DRAWING NAME: ELECTRICAL SITE PLAN	
SCALE: AS SHOWN	DWG NO:
DESIGNATION: E-1	

L:\EED_DATA\CAD_STANDARDS\WWS STD SUBMITTALS\LIFT STATION TO DEVELOPER\WWS WEBSITE 6.6.2013\WWDWED LIFT STATIONS TEMPLATE.dwg, ELECTRICAL PLAN & CONNECTION PANEL (E-2), 6/6/2013 3:53:39 PM, CBGARCIA, Adobb

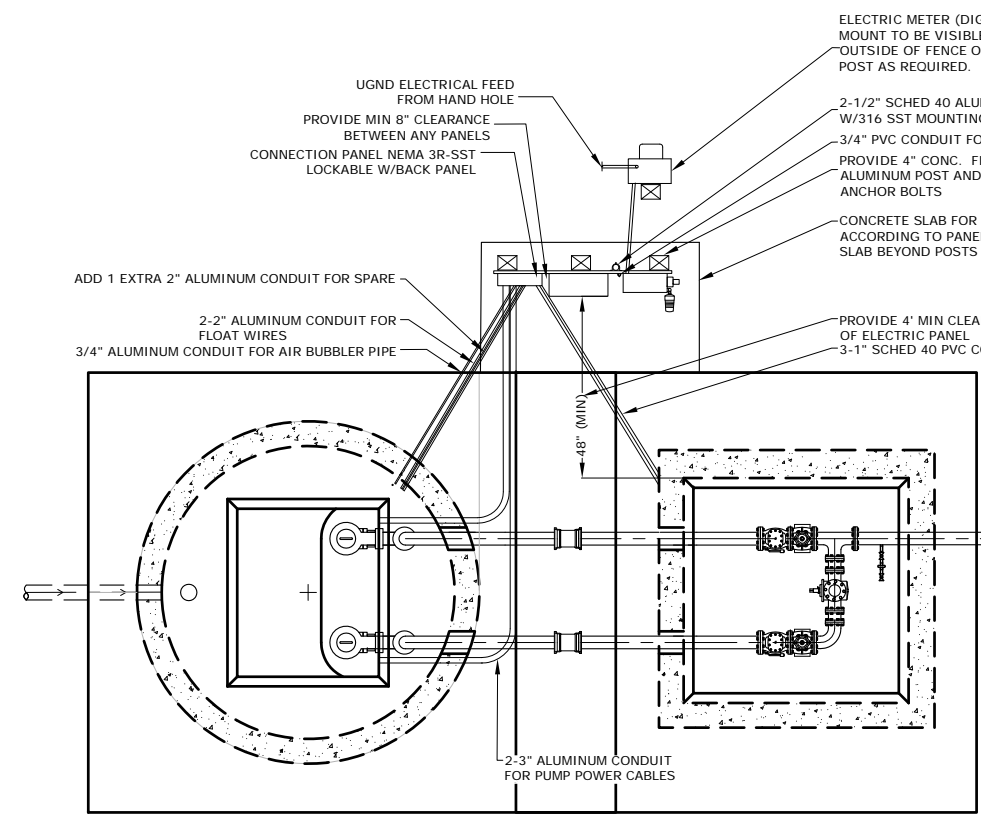


PLAN VIEW
NTS

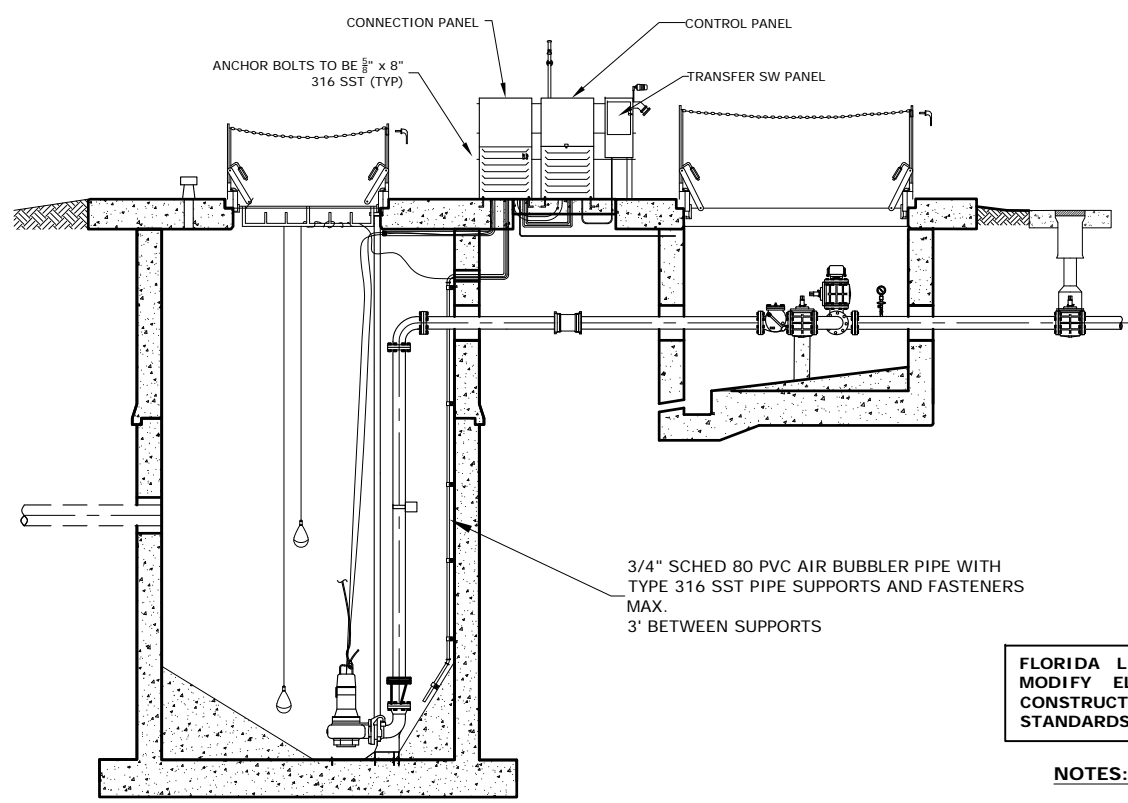

ELEVATION
NTS


FLORIDA LICENSED PROFESSIONAL ENGINEER TO REVIEW AND MODIFY ELECTRICAL DESIGN AS REQUIRED TO ACCOMPLISH CONSTRUCTION IN ACCORDANCE WITH APPLICABLE CODES AND STANDARDS.

- NOTES:**
1. AREA INSIDE WETWELL IS CONSIDERED A CLASS 1, DIVISION 2 AREA IN ACCORDANCE WITH THE NATIONAL ELECTRICAL CODE
 2. ALL OTHER AREAS ARE NOT CLASSIFIED
 3. NO PENETRATIONS SHALL BE PERMITTED IN THE TOP OF ANY PANEL BOX
 4. CONTROL PANEL/CONNECTION PANEL AND TRANSFER SWITCH TO BE MANUFACTURED BY CHAMPION CONTROLS, INC. TO WWS SPECIFICATIONS (NO SUBSTITUTION).

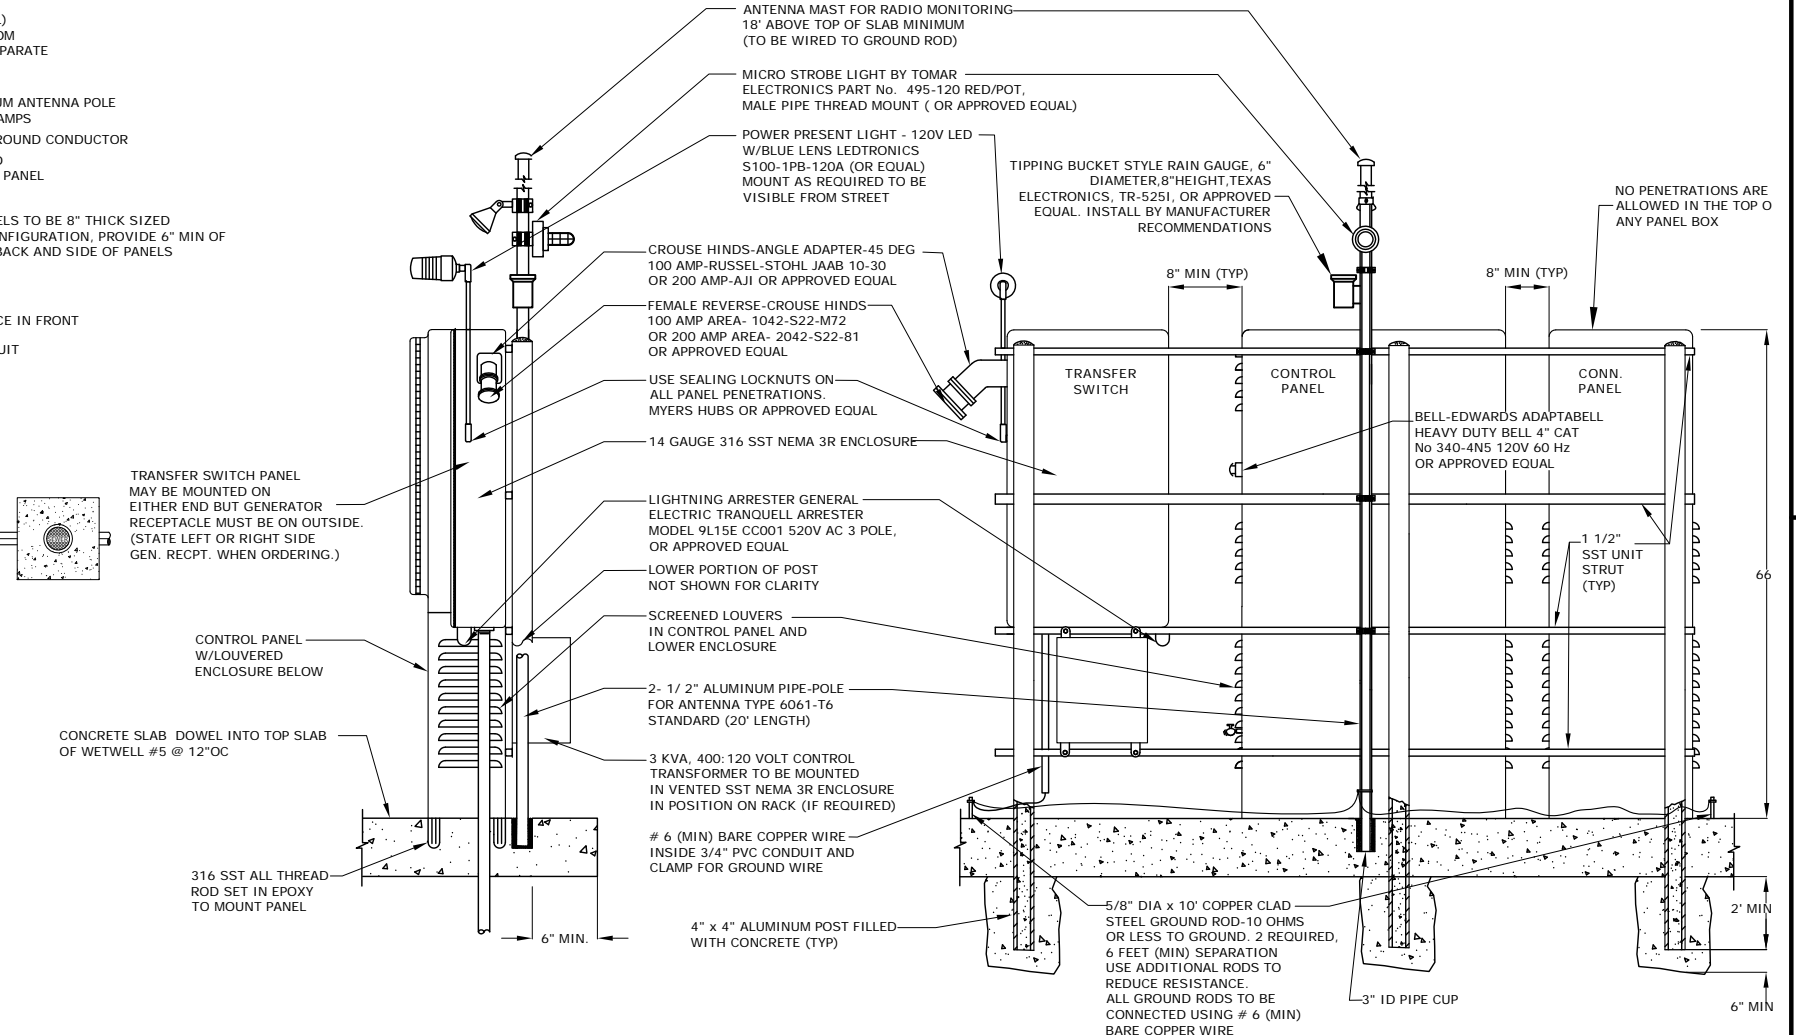

PANEL SIDE VIEW
NTS

PANEL REAR VIEW
NTS

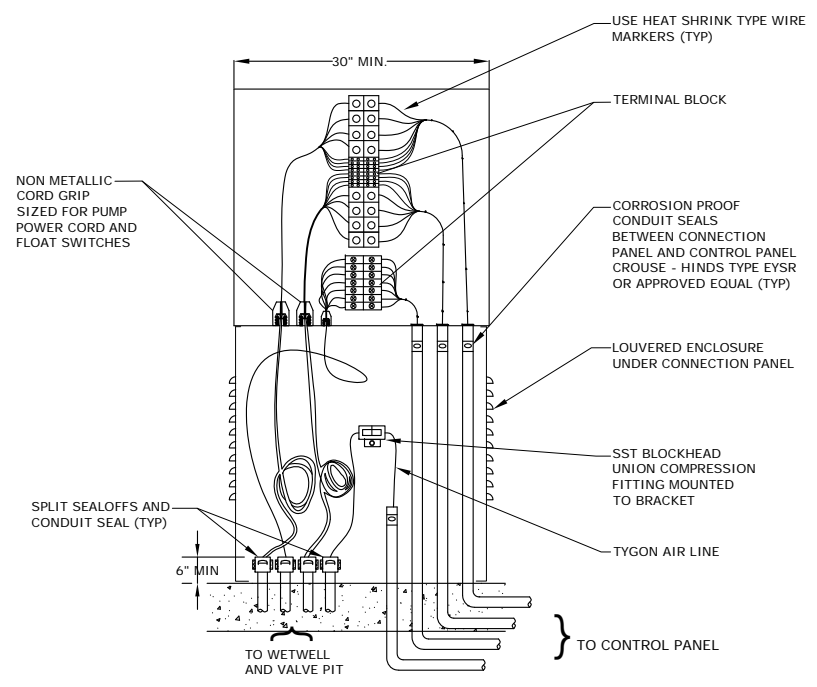


CONNECTION PANEL DETAIL
NTS


PROJECT NAME:
XXXXXXXXXXXXXXXXXXXX
XXXXXXXXXXXXXXXXXXXX
PROJECT NO XXXX
NOT FOR CONSTRUCTION

DESIGN:		DATE:	DRAWN:	CHECK:
REVISION DESCRIPTION:				
DRAWING NAME: ELECTRICAL PLAN AND CONNECTION PANEL				
SCALE: AS SHOWN	DWG NO:			
DESIGNATION: E-2				

L:\EED_DESIGN_DATA\CAD STANDARDS\WWS STD SUBMITTALS\LIFT STATION TO DEVELOPER\WWS WEBSITE 6.6.2013\WVED LIFT STATIONS TEMPLATE.dwg, DUPLEX CONTROLS CIRCUIT (E-3), 6/6/2013 3:53:42 PM, CBGARCIA, Adobe PDF, pcs

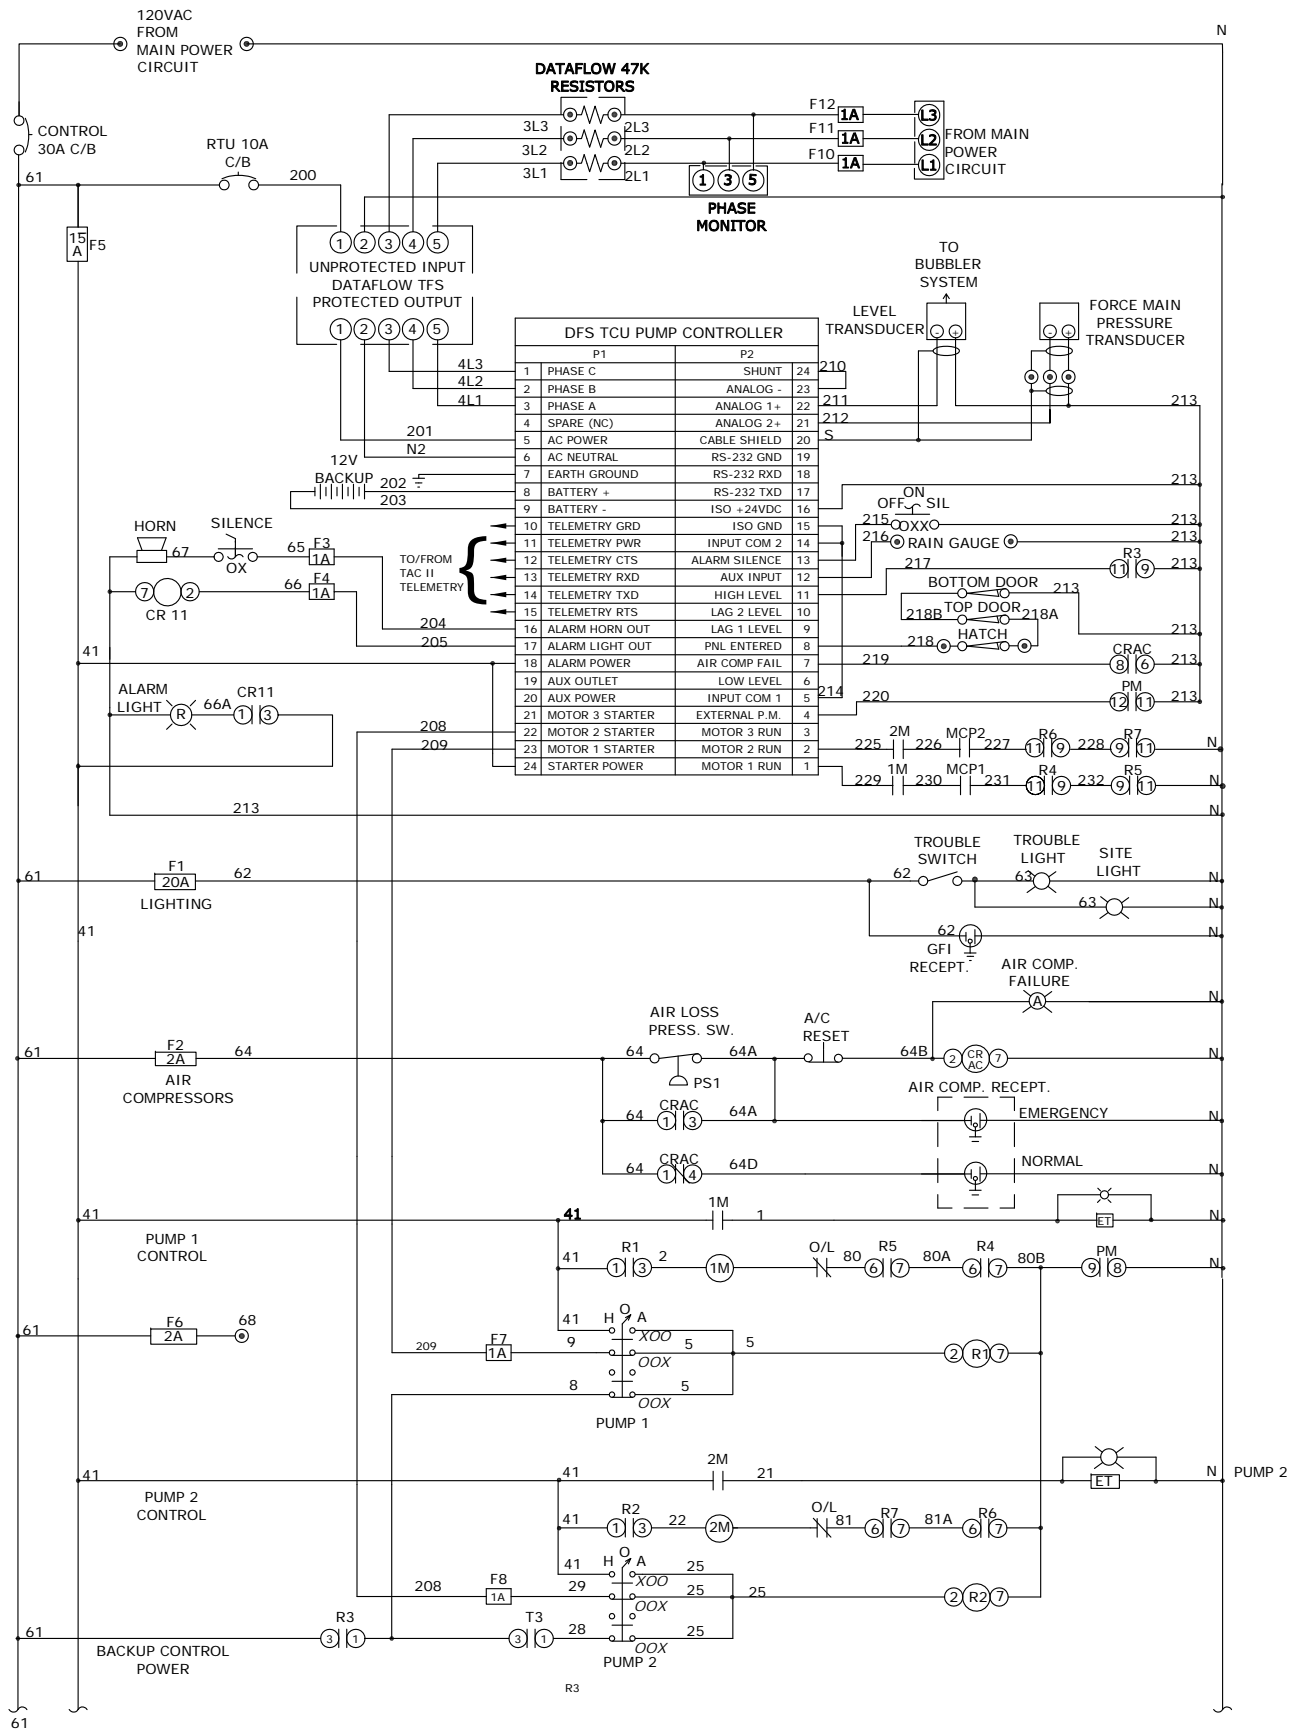

FLORIDA LICENSED PROFESSIONAL ENGINEER TO REVIEW AND MODIFY ELECTRICAL DESIGN AS REQUIRED TO ACCOMPLISH CONSTRUCTION IN ACCORDANCE WITH APPLICABLE CODES AND STANDARDS.

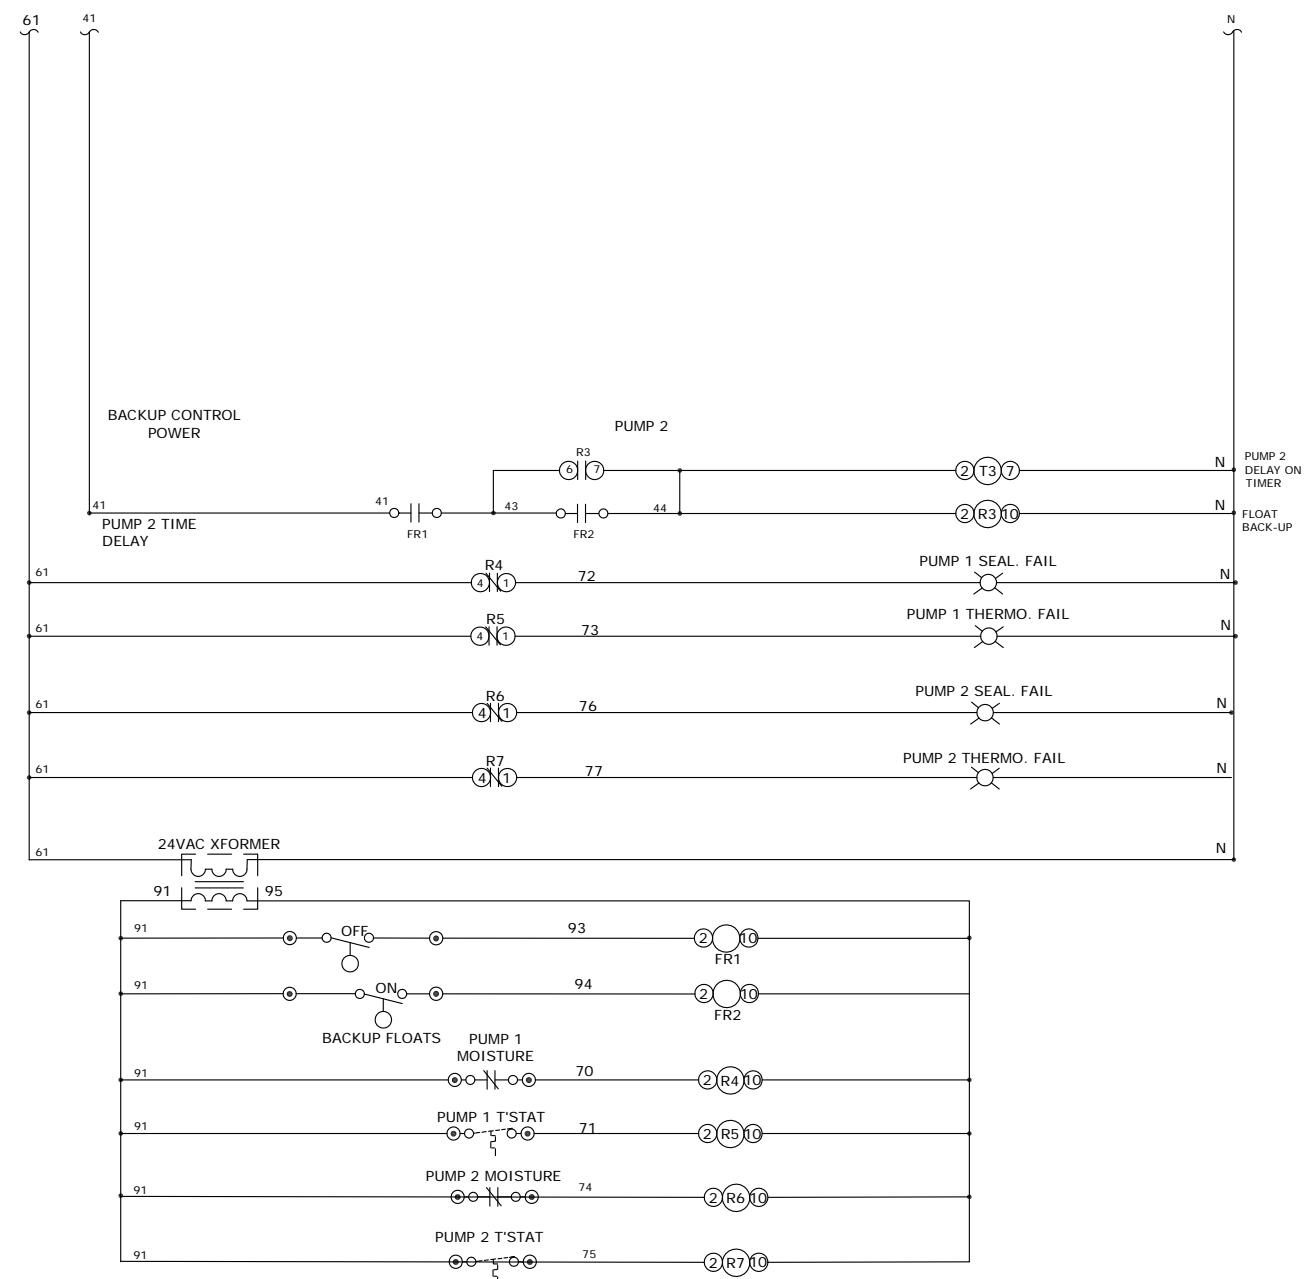

ELECTRICAL CONTROLS CIRCUIT (DUPLEX)


PROJECT NAME: XXXXXXXXXXXXXXXXXXXX
 XXXXXXXXXXXXXXXXXXXX
 PROJECT NO XXXX
NOT FOR CONSTRUCTION

SEAL

DESIGN:	DRAWN:	CHECK:
DATE:	REVISION DESCRIPTION:	
DRAWING NAME: DUPLEX CONTROLS CIRCUIT		
SCALE: NTS	DWG NO:	
DESIGNATION: E-3		

BELL-EDWARDS ADAPTABELL HEAVY DUTY BELL, 4", CAT NO. 340-4N5 120V 60 Hz, UL APPROVED OR APPROVED EQUAL


SCREENED LOUVERS BOTH SIDES 3 AREAS

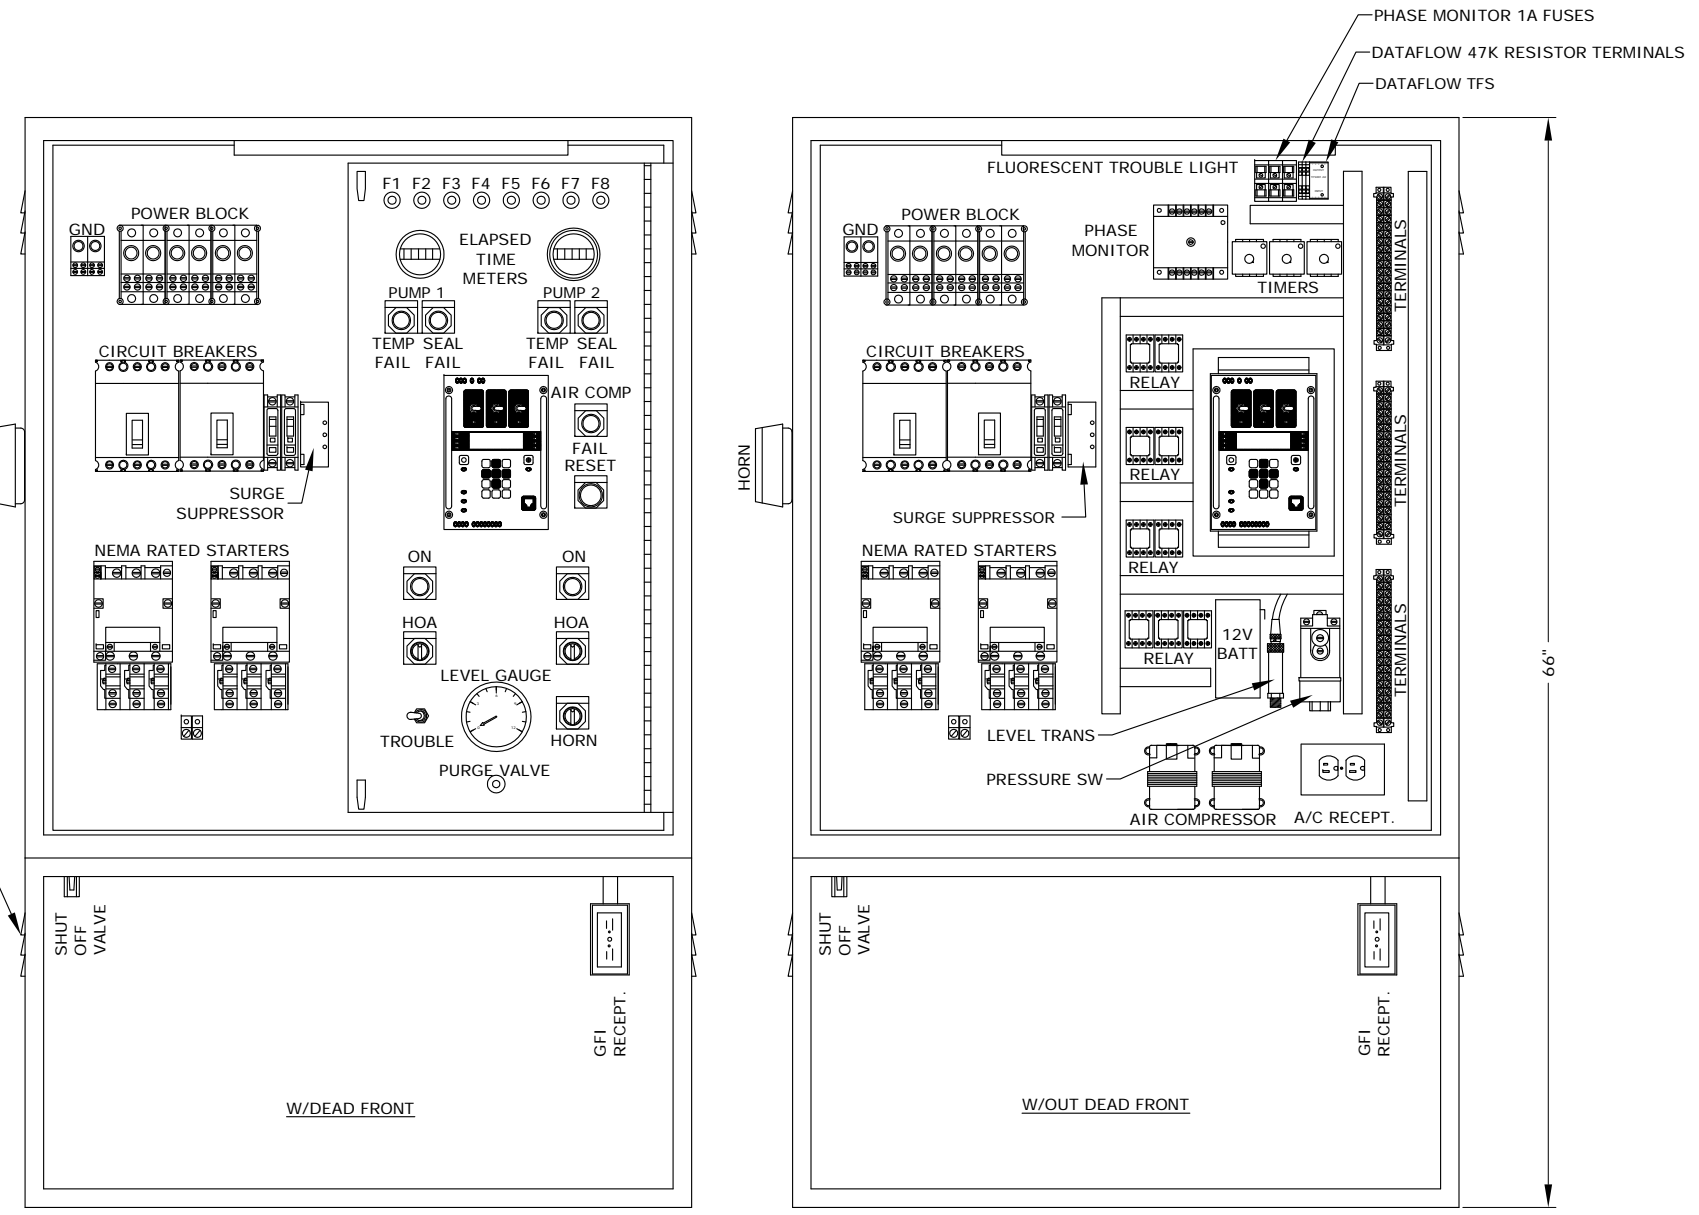

DUPLEX CONTROL PANEL LAYOUT


ENCLOSURE SIZE : 66" x 36" x 10"
 RATING: NEMA 3R
 MATERIAL: 316 STAINLESS STEEL

ELECTRICAL INPUT CONNECTION BLOCK

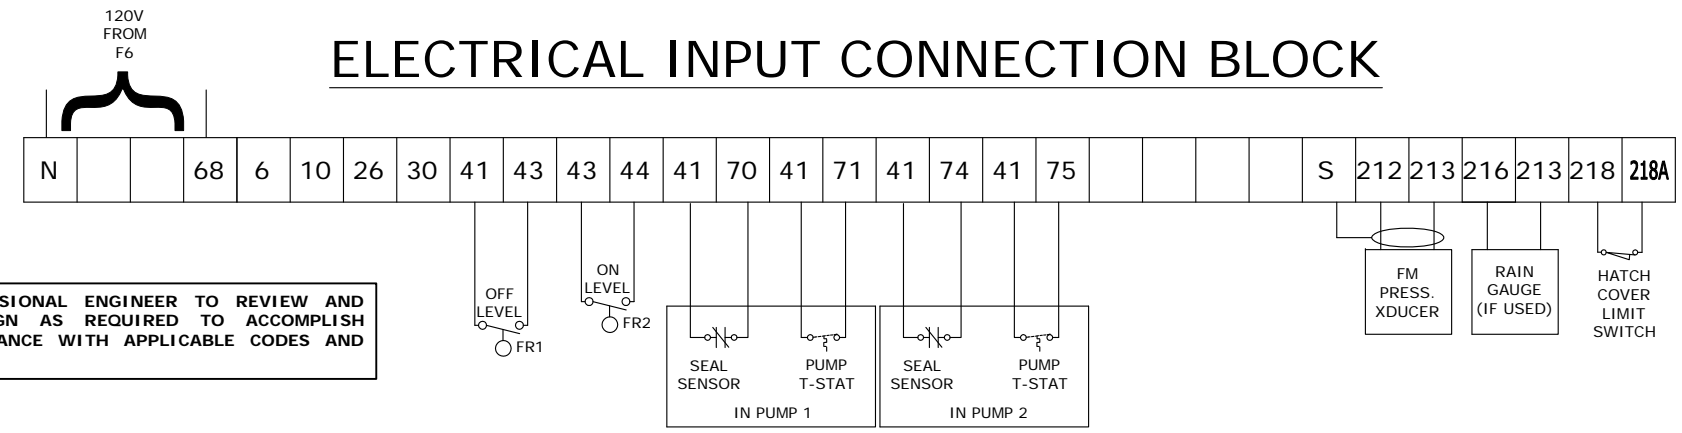

FLORIDA LICENSED PROFESSIONAL ENGINEER TO REVIEW AND MODIFY ELECTRICAL DESIGN AS REQUIRED TO ACCOMPLISH CONSTRUCTION IN ACCORDANCE WITH APPLICABLE CODES AND STANDARDS.

PROJECT NAME: XXXXXXXXXXXXXXXXXXXX XXXXXXXXXXXXXXXXXXXX	PROJECT NO XXXX NOT FOR CONSTRUCTION
SEAL	
DESIGN:	CHECK:
DATE:	REVISION DESCRIPTION:
DRAWING NAME: ELECTRIC SCHEMATIC AND CONTROL PANEL	
SCALE: NTS	DWG NO.:
DESIGNATION: E-4	

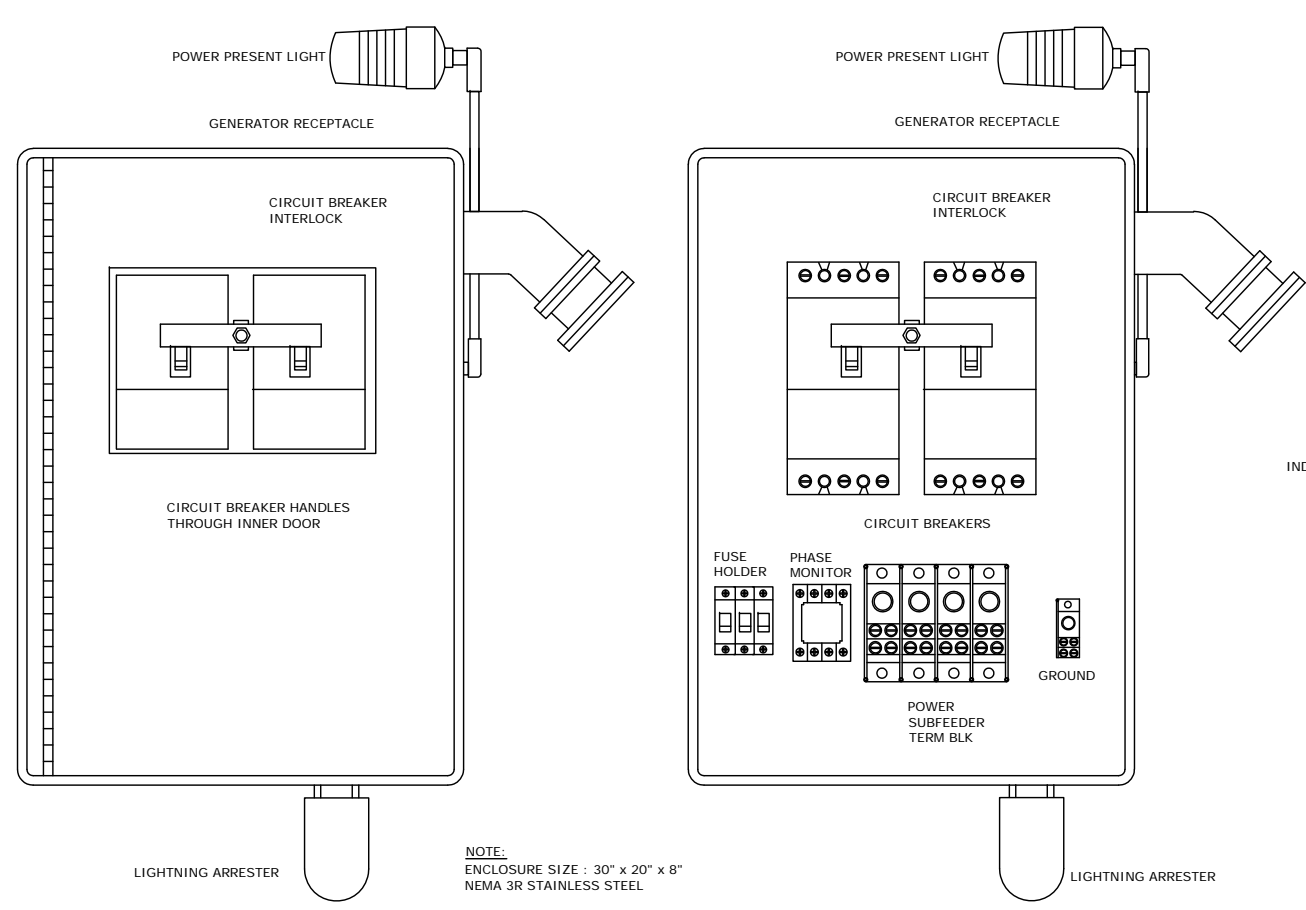

NOTE:
ENCLOSURE SIZE : 30" x 20" x 8"
NEMA 3R STAINLESS STEEL


240 VOLT								
HP	MOTOR AMP (I)	STARTER SIZE	CONDUCTOR (A)	PUMP CB	MAIN/EMER CB	CONDUCTOR (B)	GENERATOR PLUG*	SERVICE RACEWAY (MIN)
3	9.6	1	12	20	100	1 (44A)	100	2"
5	15.2	1	10	40	100	1 (58A)	100	2"
7.5	22	2	10	50	125	1 (75A)	100	2"
10	28	2	8	70	125	1 (90A)	100	2"
15	42	3	6	100	175	0 (125A)	100	2"
20	54	3	4	150	225	0 (155A)	100	2"
25	68	4	4	175	300	00 (190A)	100	2"
30	80	4	3	200	300	000 (220A)	100	2"

480 VOLT								
HP	MOTOR AMP (I)	STARTER SIZE	CONDUCTOR (A)	PUMP CB	MAIN/EMER CB	CONDUCTOR (B)	GENERATOR PLUG*	SERVICE RACEWAY (MIN)
3	5	1	12	15	100	1 (32.5A)	200	2"
5	8	1	12	15	100	1 (40A)	200	2"
7.5	11	1	12	20	100	1 (47.5A)	200	2"
10	14	2	12	30	100	1 (55A)	200	2"
15	21	2	10	50	125	1 (72.5A)	200	2"
20	27	2	10	60	125	1 (87.5A)	200	2"
25	34	2	8	90	150	1 (105A)	200	2"
30	40	3	6	100	150	1 (120A)	200	2"
40	52	3	4	150	225	0 (150A)	200	2"
50	65	4	4	175	250	00 (182.5A)	200	3"
60	77	4	3	200	300	000 (212.5A)	200	3"
75	96	4	1	250	350	0000 (260A)	200	3"

INDICATE APPLICABLE DATA

- NOTE :
- THE ABOVE TABLE COMPILED PER CURRENT NATIONAL ELECTRIC CODE SECTION 430 TABLE 430.250
 - GROUNDING ELECTRODE SIZED PER NATIONAL ELECTRICAL CODE
 - *GENERATOR PLUGS ARE SIZED TO MATCH THE GENERATOR'S CORD, NOT THE ELECTRICAL SERVICE.
 - CONDUCTOR B IS A MOTOR CIRCUIT FEEDER, RATED AT 90 DEG C, SIZED FOR 2 PUMPS AT 125% OF FLA PLUS A 20 AMP GENERAL LOAD.
 - DESIGNER TO VERIFY DATA IN THESE TABLES
 - SERVICE RACEWAY TO BE OVERSIZED AS SHOWN TO ACCOMMODATE FUTURE EXPANSION.

EMERGENCY CONNECTION/TRANSFER SWITCH
NTS

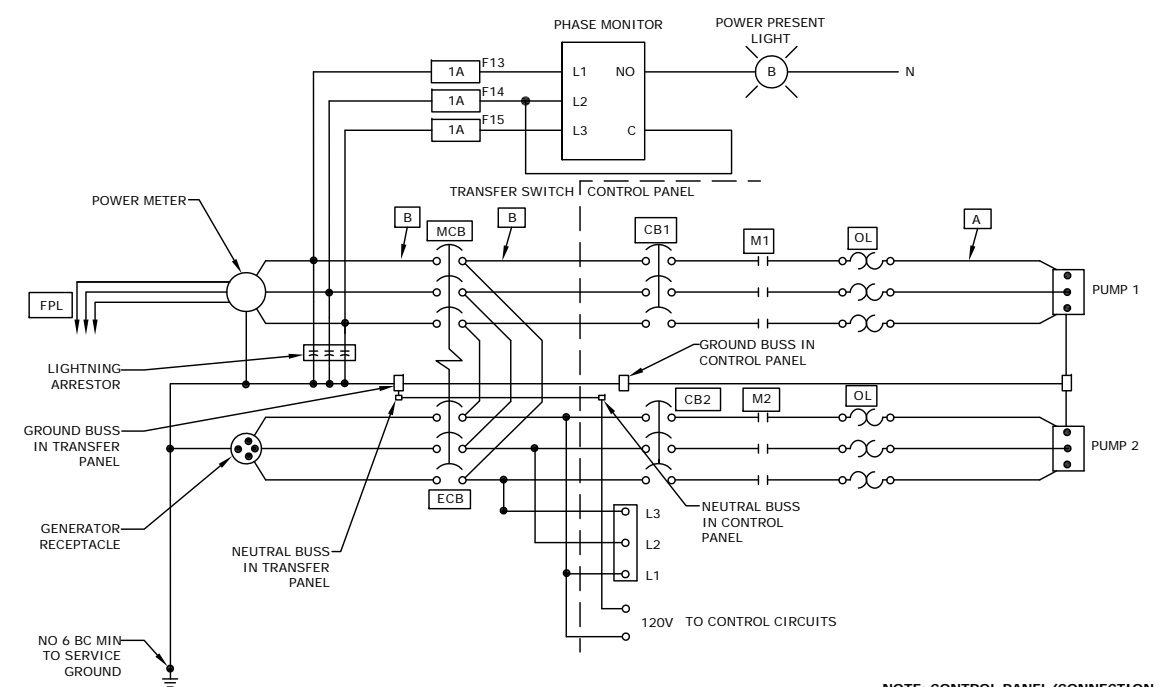


TRANSFER SWITCH MUST BE RATED AS SERVICE ENTRANCE EQUIPMENT
240V MAIN POWER CIRCUIT

NOTE:
MCB AND ECB ARE TO BE SUITABLE FOR USE AS SERVICE EQUIPMENT ARE TO BE PERMANENTLY IDENTIFIED AS SERVICE DISCONNECTS. ARE TO BE CAPABLE OF BEING OPERATED WITHOUT EXPOSING OPERATOR TO CONTACT WITH LIVE PARTS. GROUND FAULT PROTECTION-25000 IC AT 240 V, 30000 IC AT 480 V.

NOTE: CONTROL PANEL/CONNECTION PANEL AND TRANSFER SWITCH TO BE MANUFACTURED BY CHAMPION CONTROLS, INC. TO WWS SPECIFICATIONS (NO SUBSTITUTION).

FLORIDA LICENSED PROFESSIONAL ENGINEER TO REVIEW AND MODIFY ELECTRICAL DESIGN AS REQUIRED TO ACCOMPLISH CONSTRUCTION IN ACCORDANCE WITH APPLICABLE CODES AND STANDARDS.

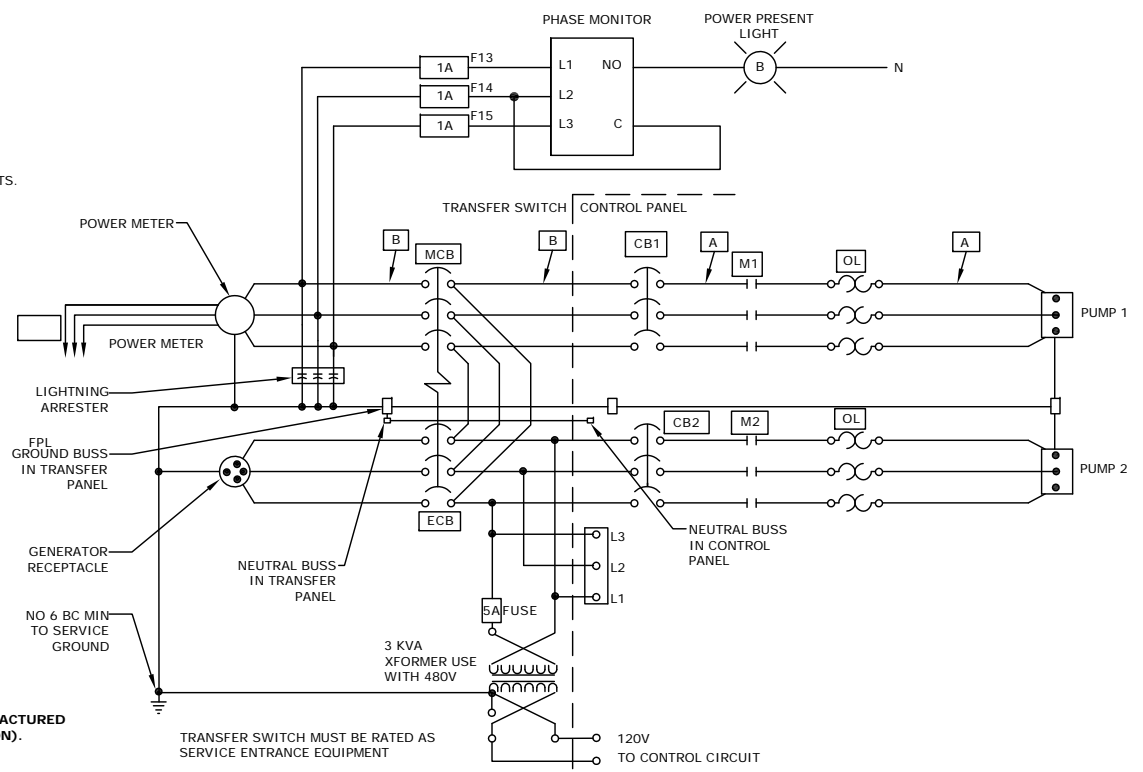





480V MAIN POWER CIRCUIT

PROJECT NAME:
XXXXXXXXXXXXXXXXXXXX
XXXXXXXXXXXXXXXXXXXX
PROJECT NO XXXX
NOT FOR CONSTRUCTION

SEAL

DESIGN:	DRAWN:	CHECK:
DATE:	REVISION DESCRIPTION:	
DRAWING NAME: ELECTRICAL SERVICE AND TRANSFER SWITCH		
SCALE: AS SHOWN	DWG NO:	
DESIGNATION: E-5		

L:\EED_DESIGN_DATA\CAD STANDARDS\WWS STD SUBMITTALS\LIFT STATION TO DEVELOPER\WWS WEBSITE 6.6.2013\WVED LIFT STATIONS TEMPLATE.dwg, ELECTRICAL DETAILS (E-6), 6/6/2013 3:53:49 PM, C.BGARCIA, Adobe PDF.pc3

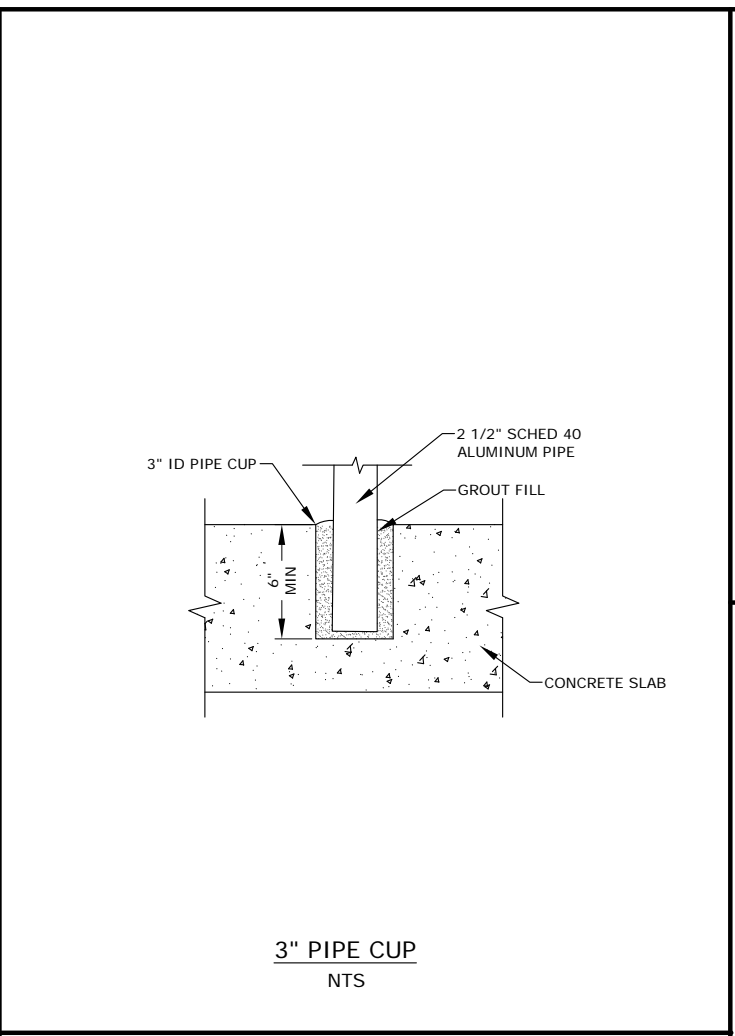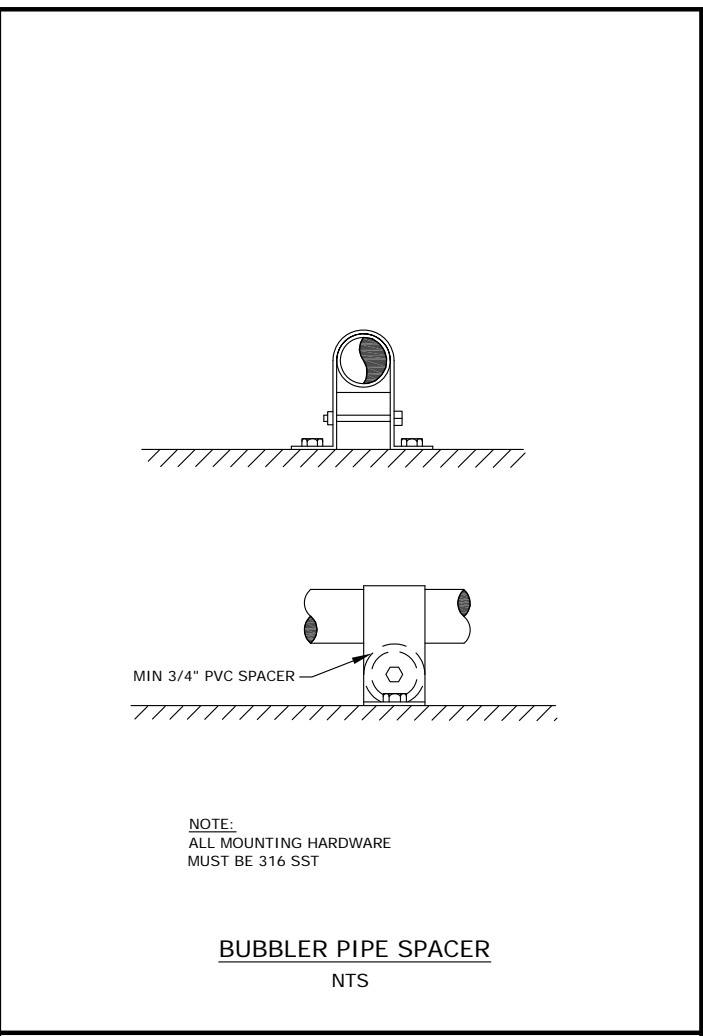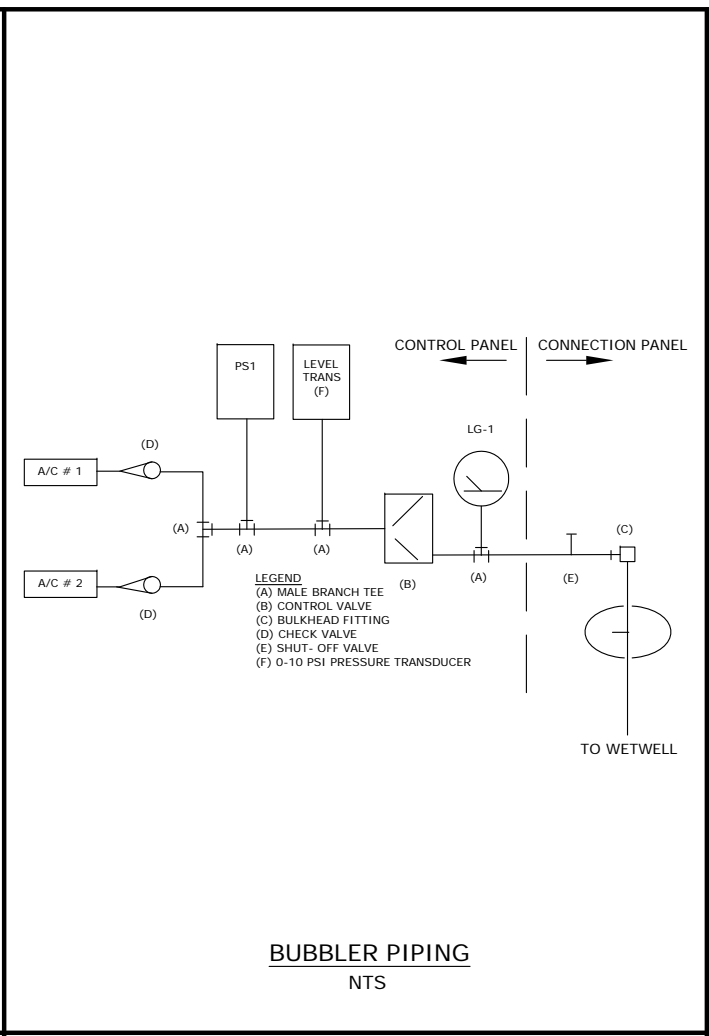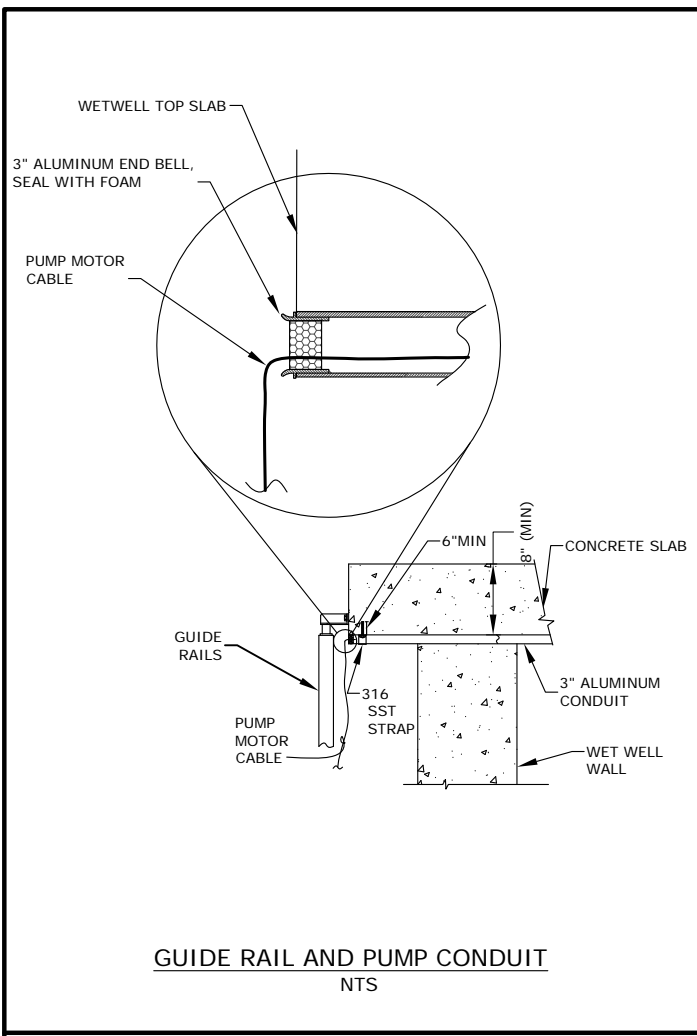

PROJECT NAME:
XXXXXXXXXXXXXXXXXXXX
XXXXXXXXXXXXXXXXXXXX
PROJECT NO XXXX

NOT FOR CONSTRUCTION

SEAL

DESIGN:	DRAWN:	CHECK:
DATE:	REVISION DESCRIPTION:	
DRAWING NAME: ELECTRICAL DETAILS		
SCALE: AS SHOWN	DWG NO:	
DESIGNATION: E-6		

LAST SAVED: 06/06/13 - 3:27PM